


engineering. surveying. planning.

# Highland Ridge Active Adult Community

570 Meriden Waterbury Turnpike Southington, Connecticut

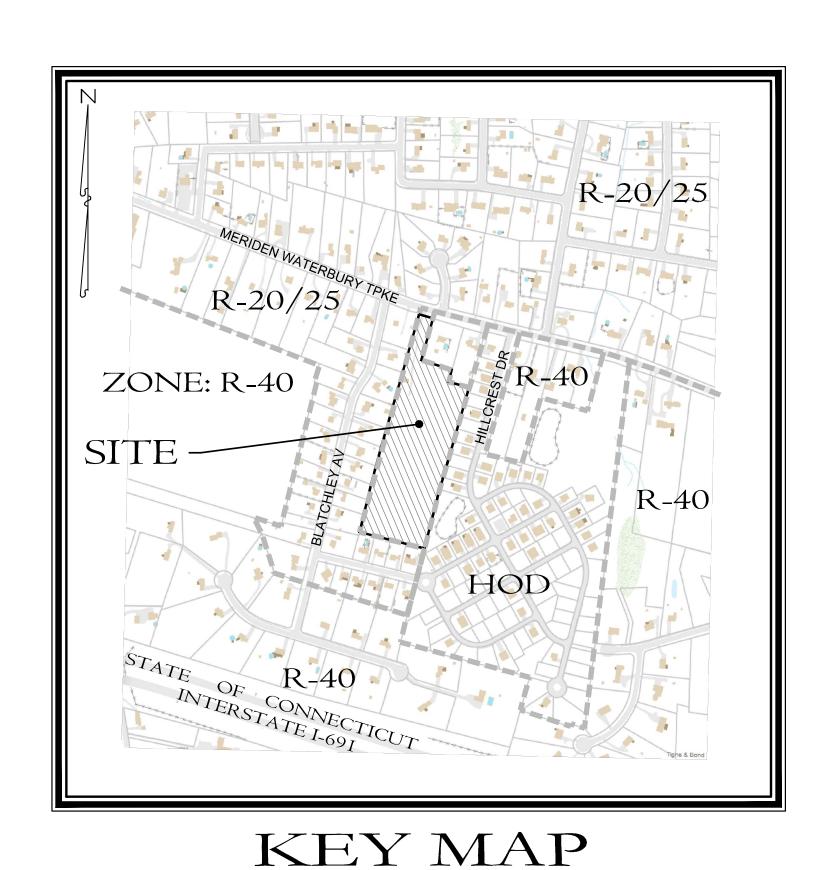

SCALE: 1"=500'

Sheet Index:

S1	Property & Topographic Survey Map
C1	Site Layout & Landscaping Plan
C2	Site Grading & Drainage Plan
C3	Site Sewer & Water Plan
P1	Plan and Profile - Highland Ridge Lane (Private)
ES1	Soil Erosion & Sedimentation Control Plan
D1	Details
D2	Details
D3	Details
DB1	Detention Basin Details

## Applicant:

AA Denorfia Building & Development 133 Main Street Southington, Connecticut

## Property Owner:

Cecelia Docar 570 Meriden Waterbury Turnpike Southington, Connecticut

### Consultants:

## Engineering & Surveying

Harry E. Cole & Son P.O. Box 44 - 876 South Main Street Plantsville, Connecticut 06489 Tel. (860) 628-4484 Fax (860) 620-0196

PREPARED FOR

## AA Denorfia Building & Development


September 1, 2022


**Revision Table** 

Sept. 26, 2022 Revised per Town Comments September 1, 2022

First Submittal Set


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Tel: (860) 628-4484

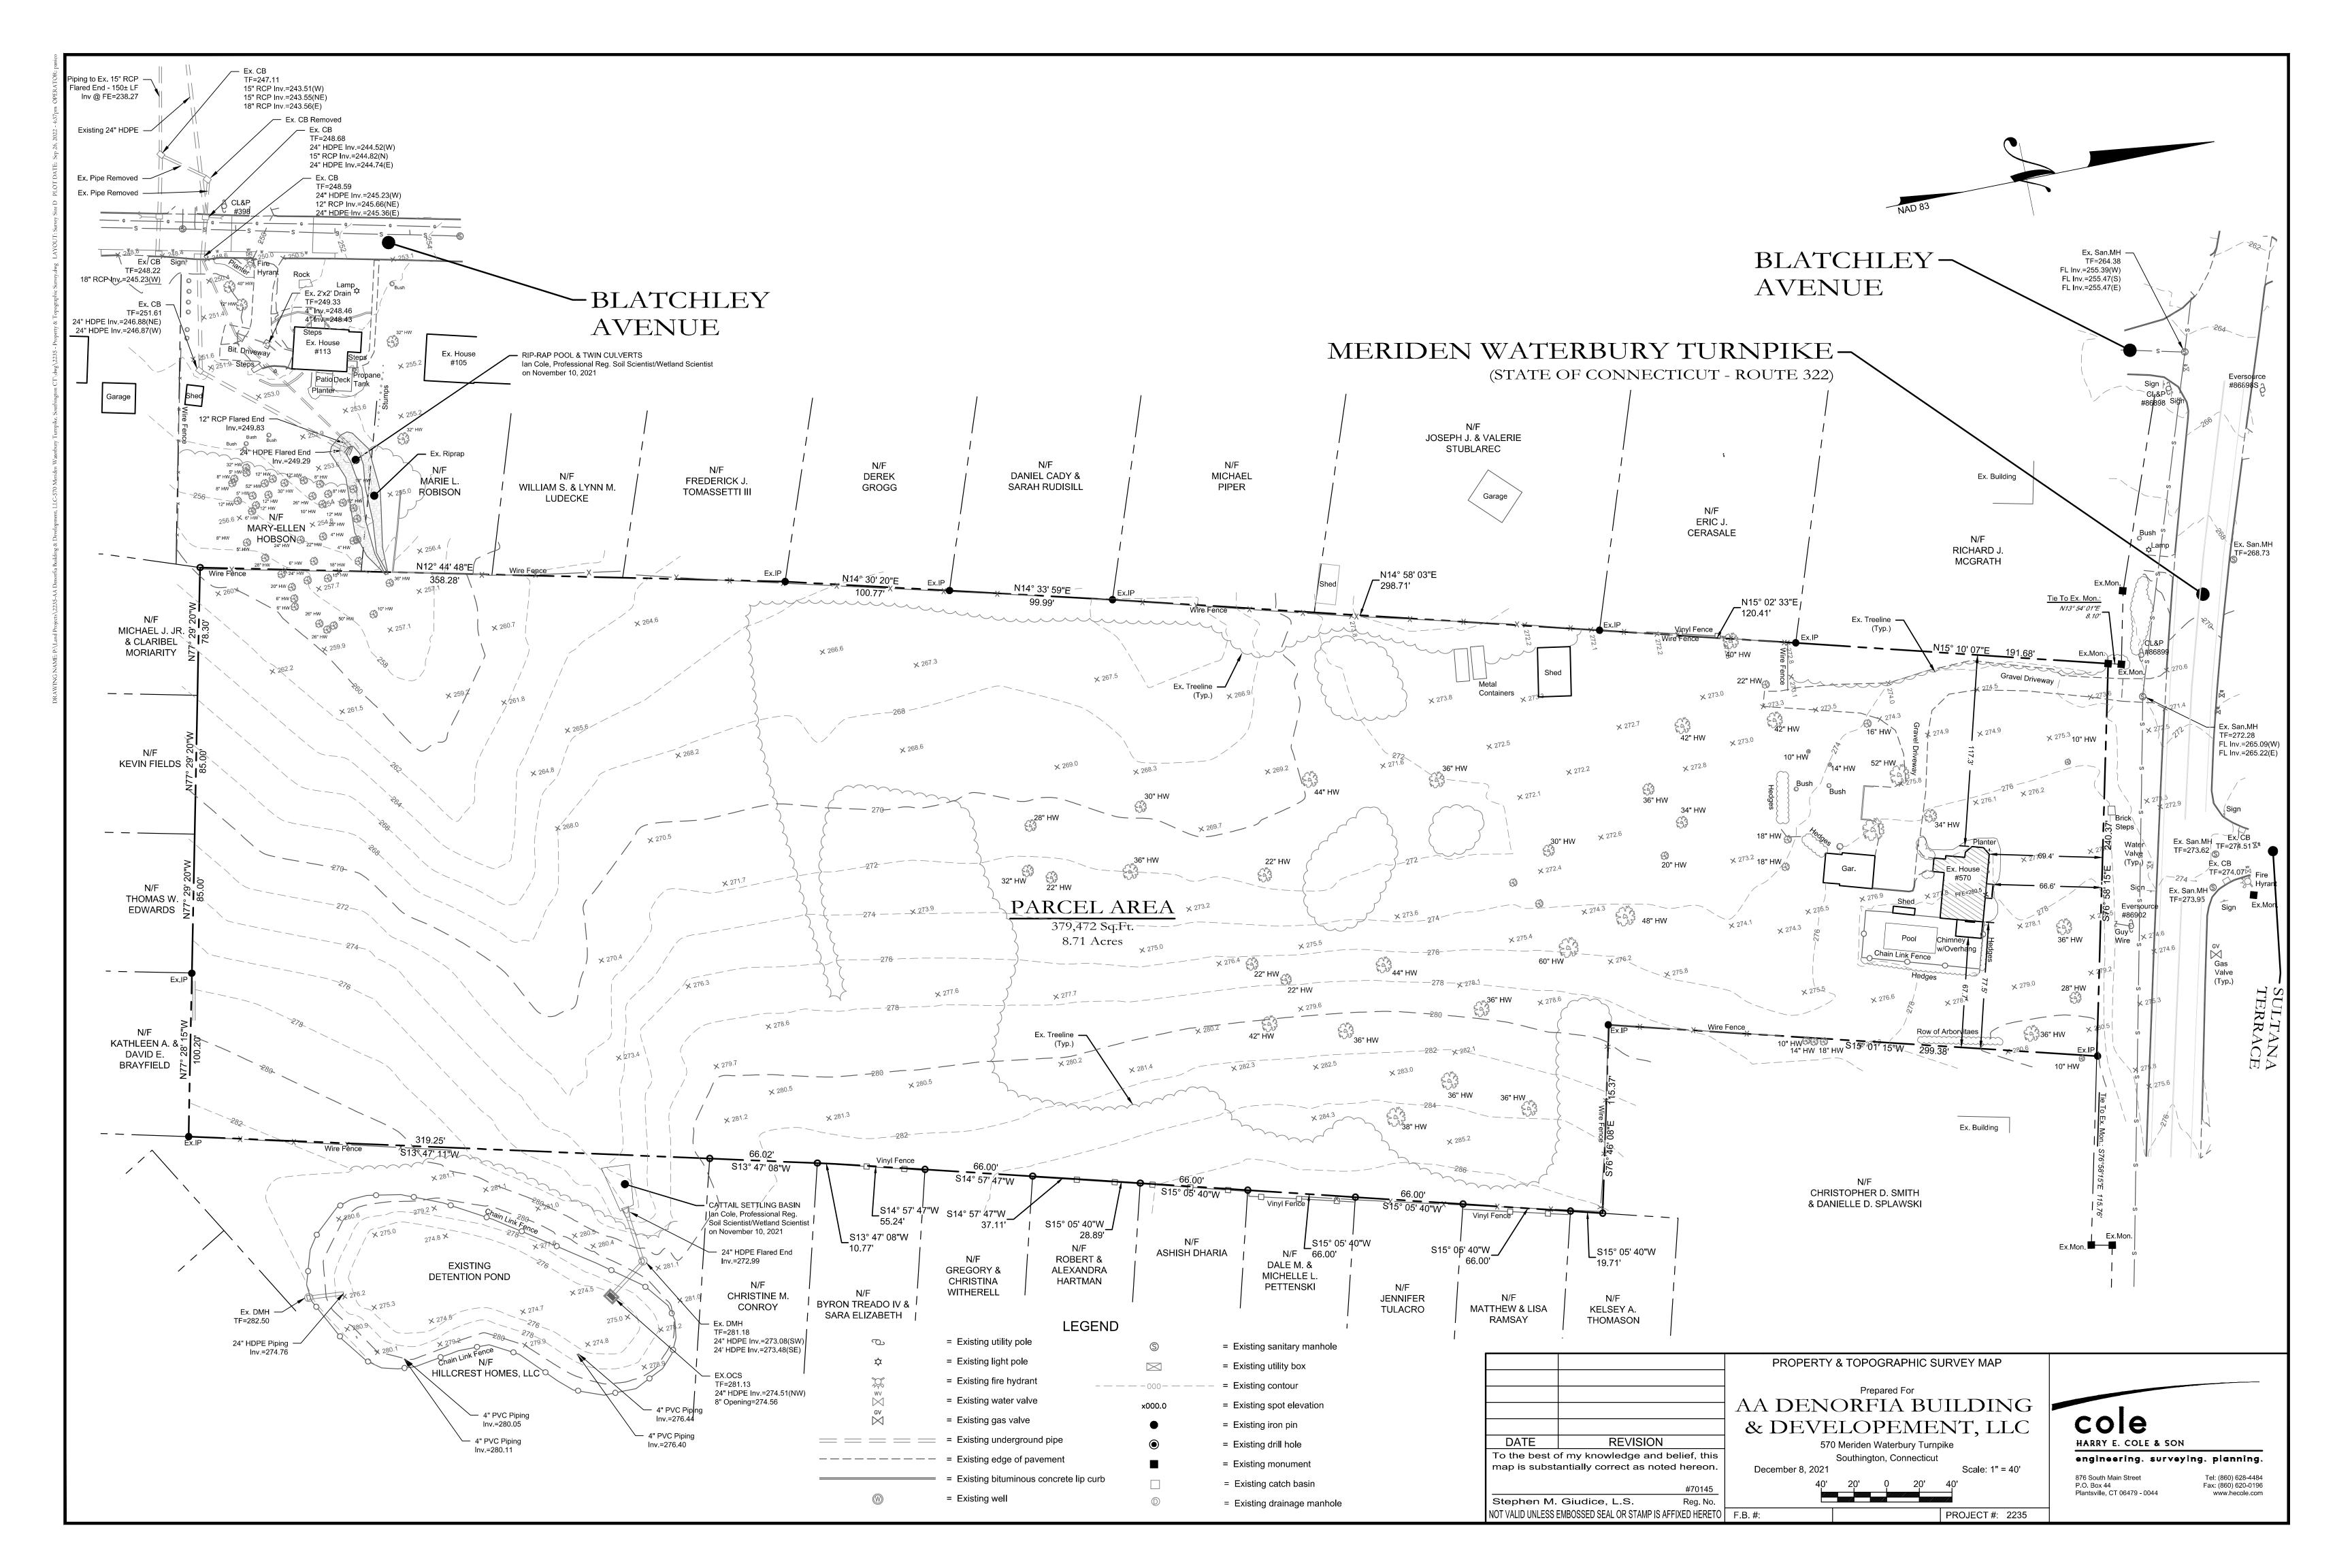Fax: (860) 620-0196

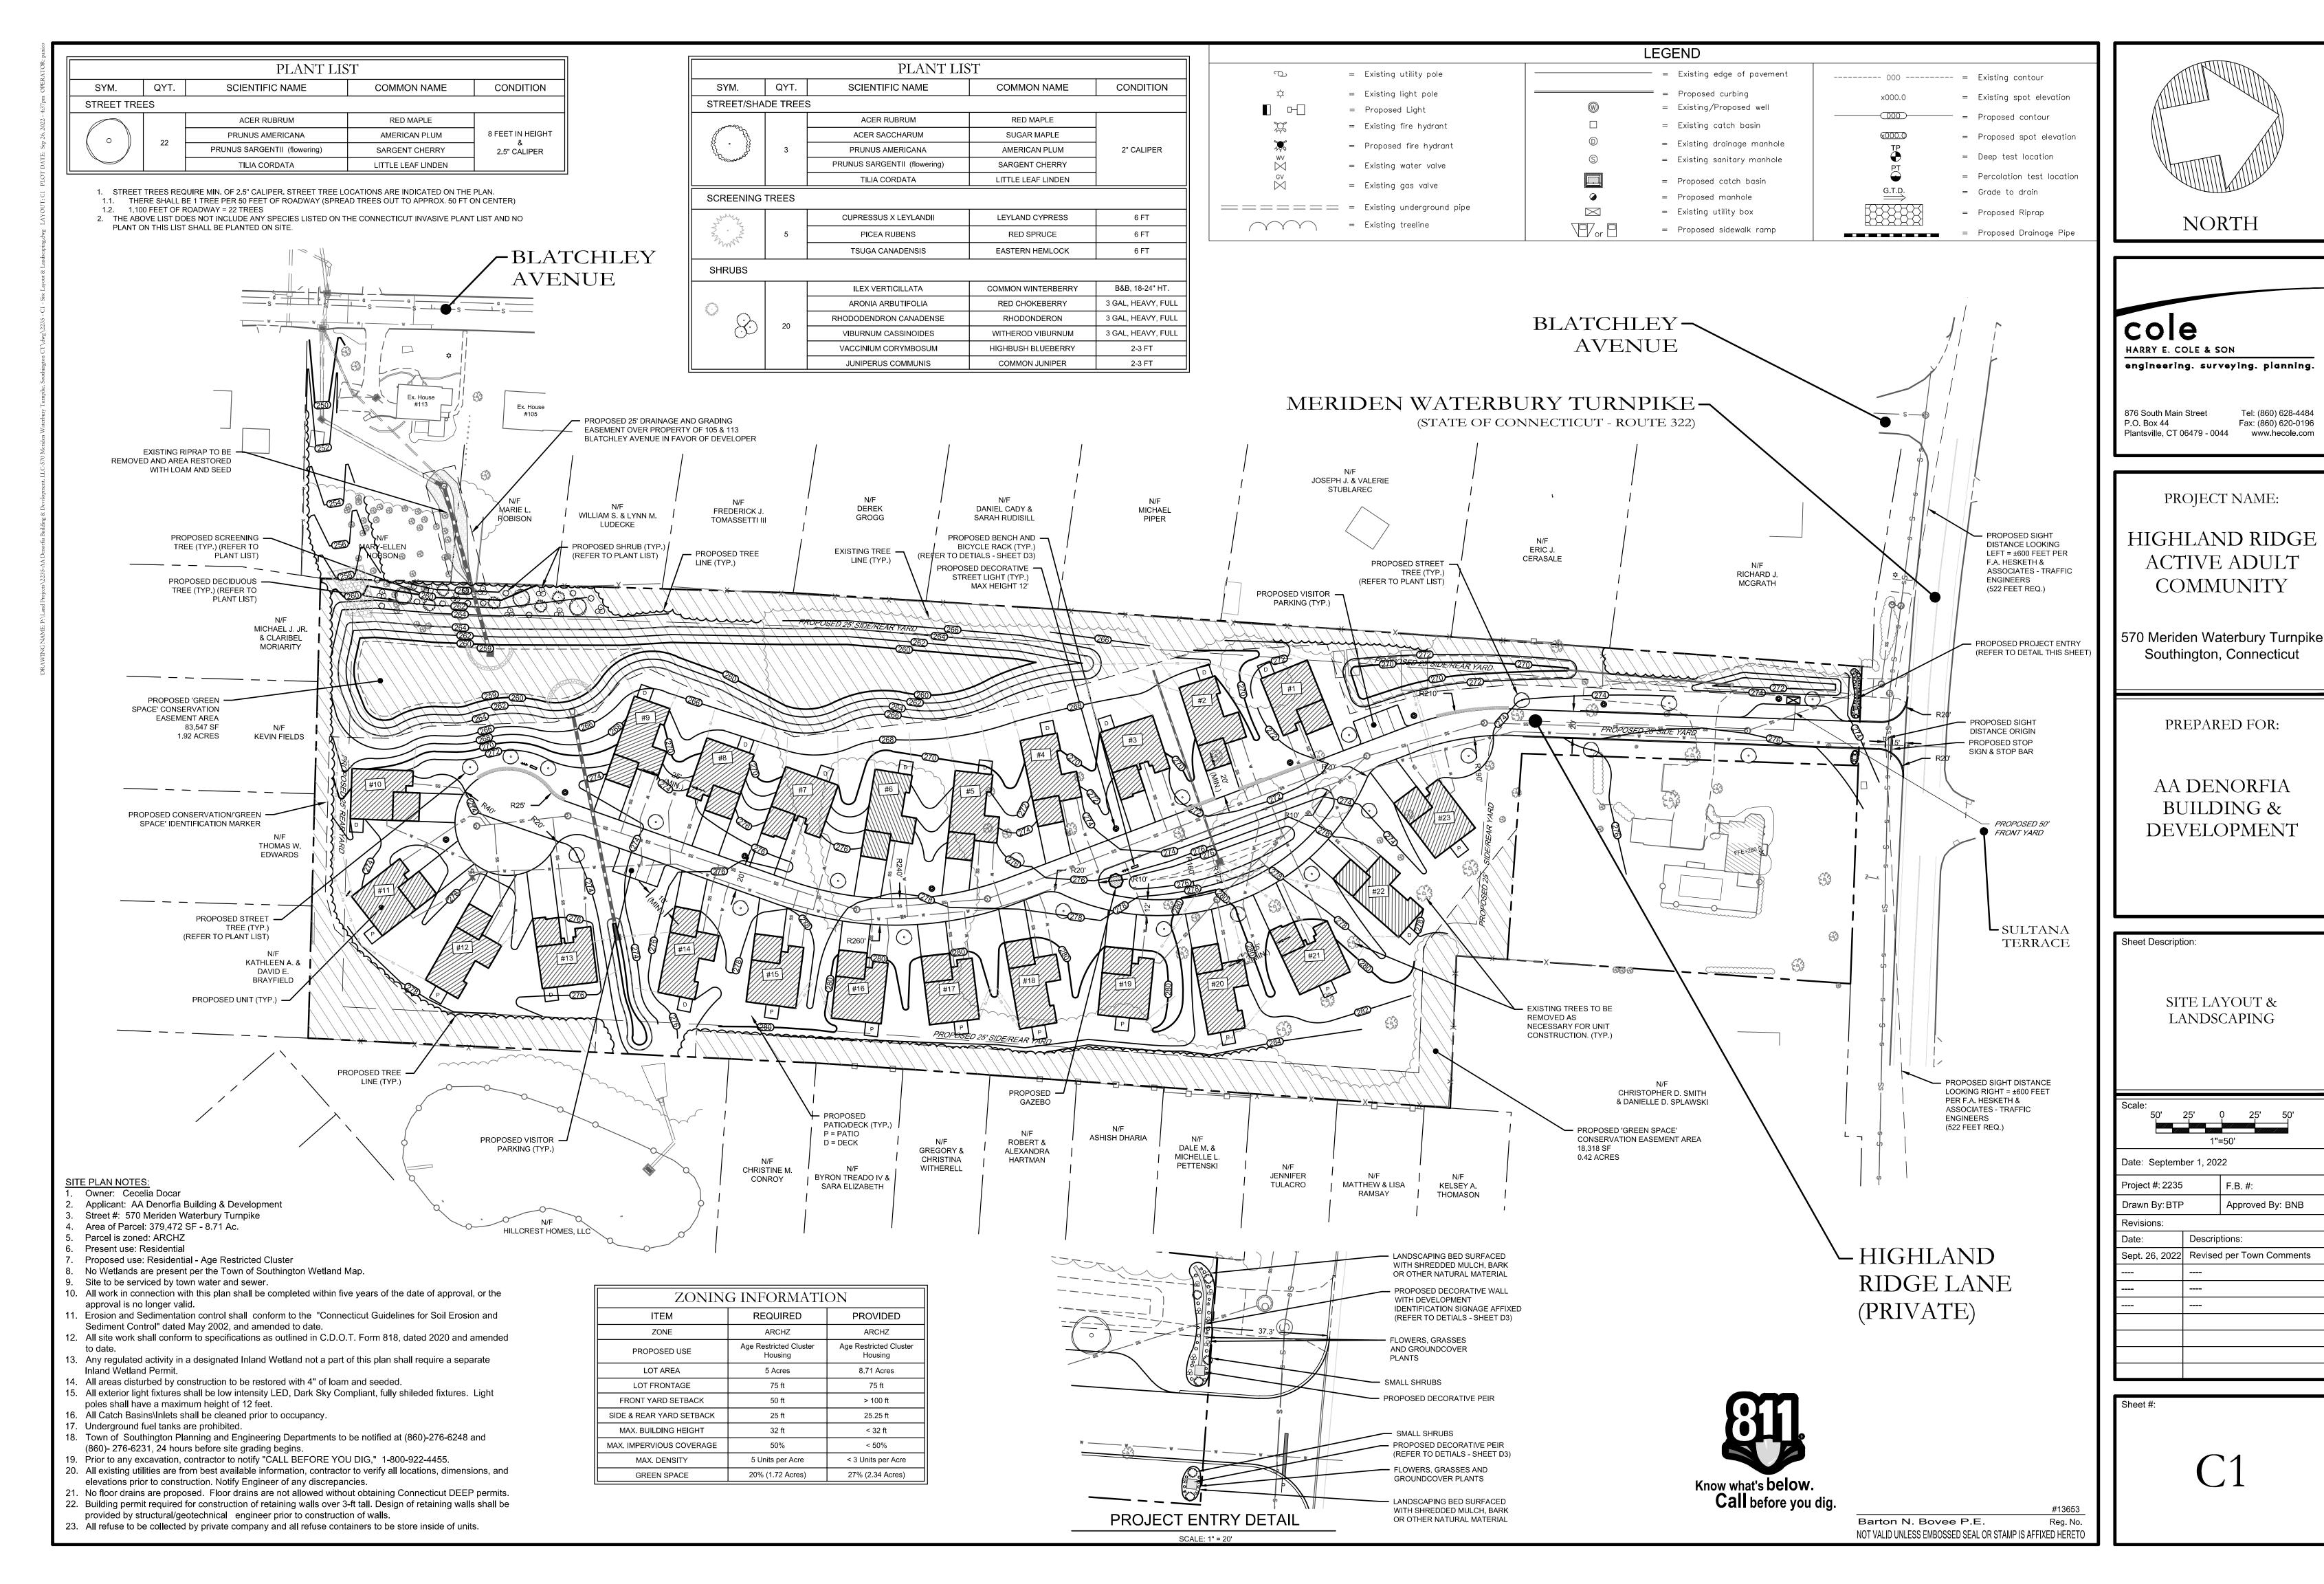

Maximum earth slopes shall be two feet horizontal to one foot vertical.

elevations prior to construction. Notify Engineer of any discrepancies.

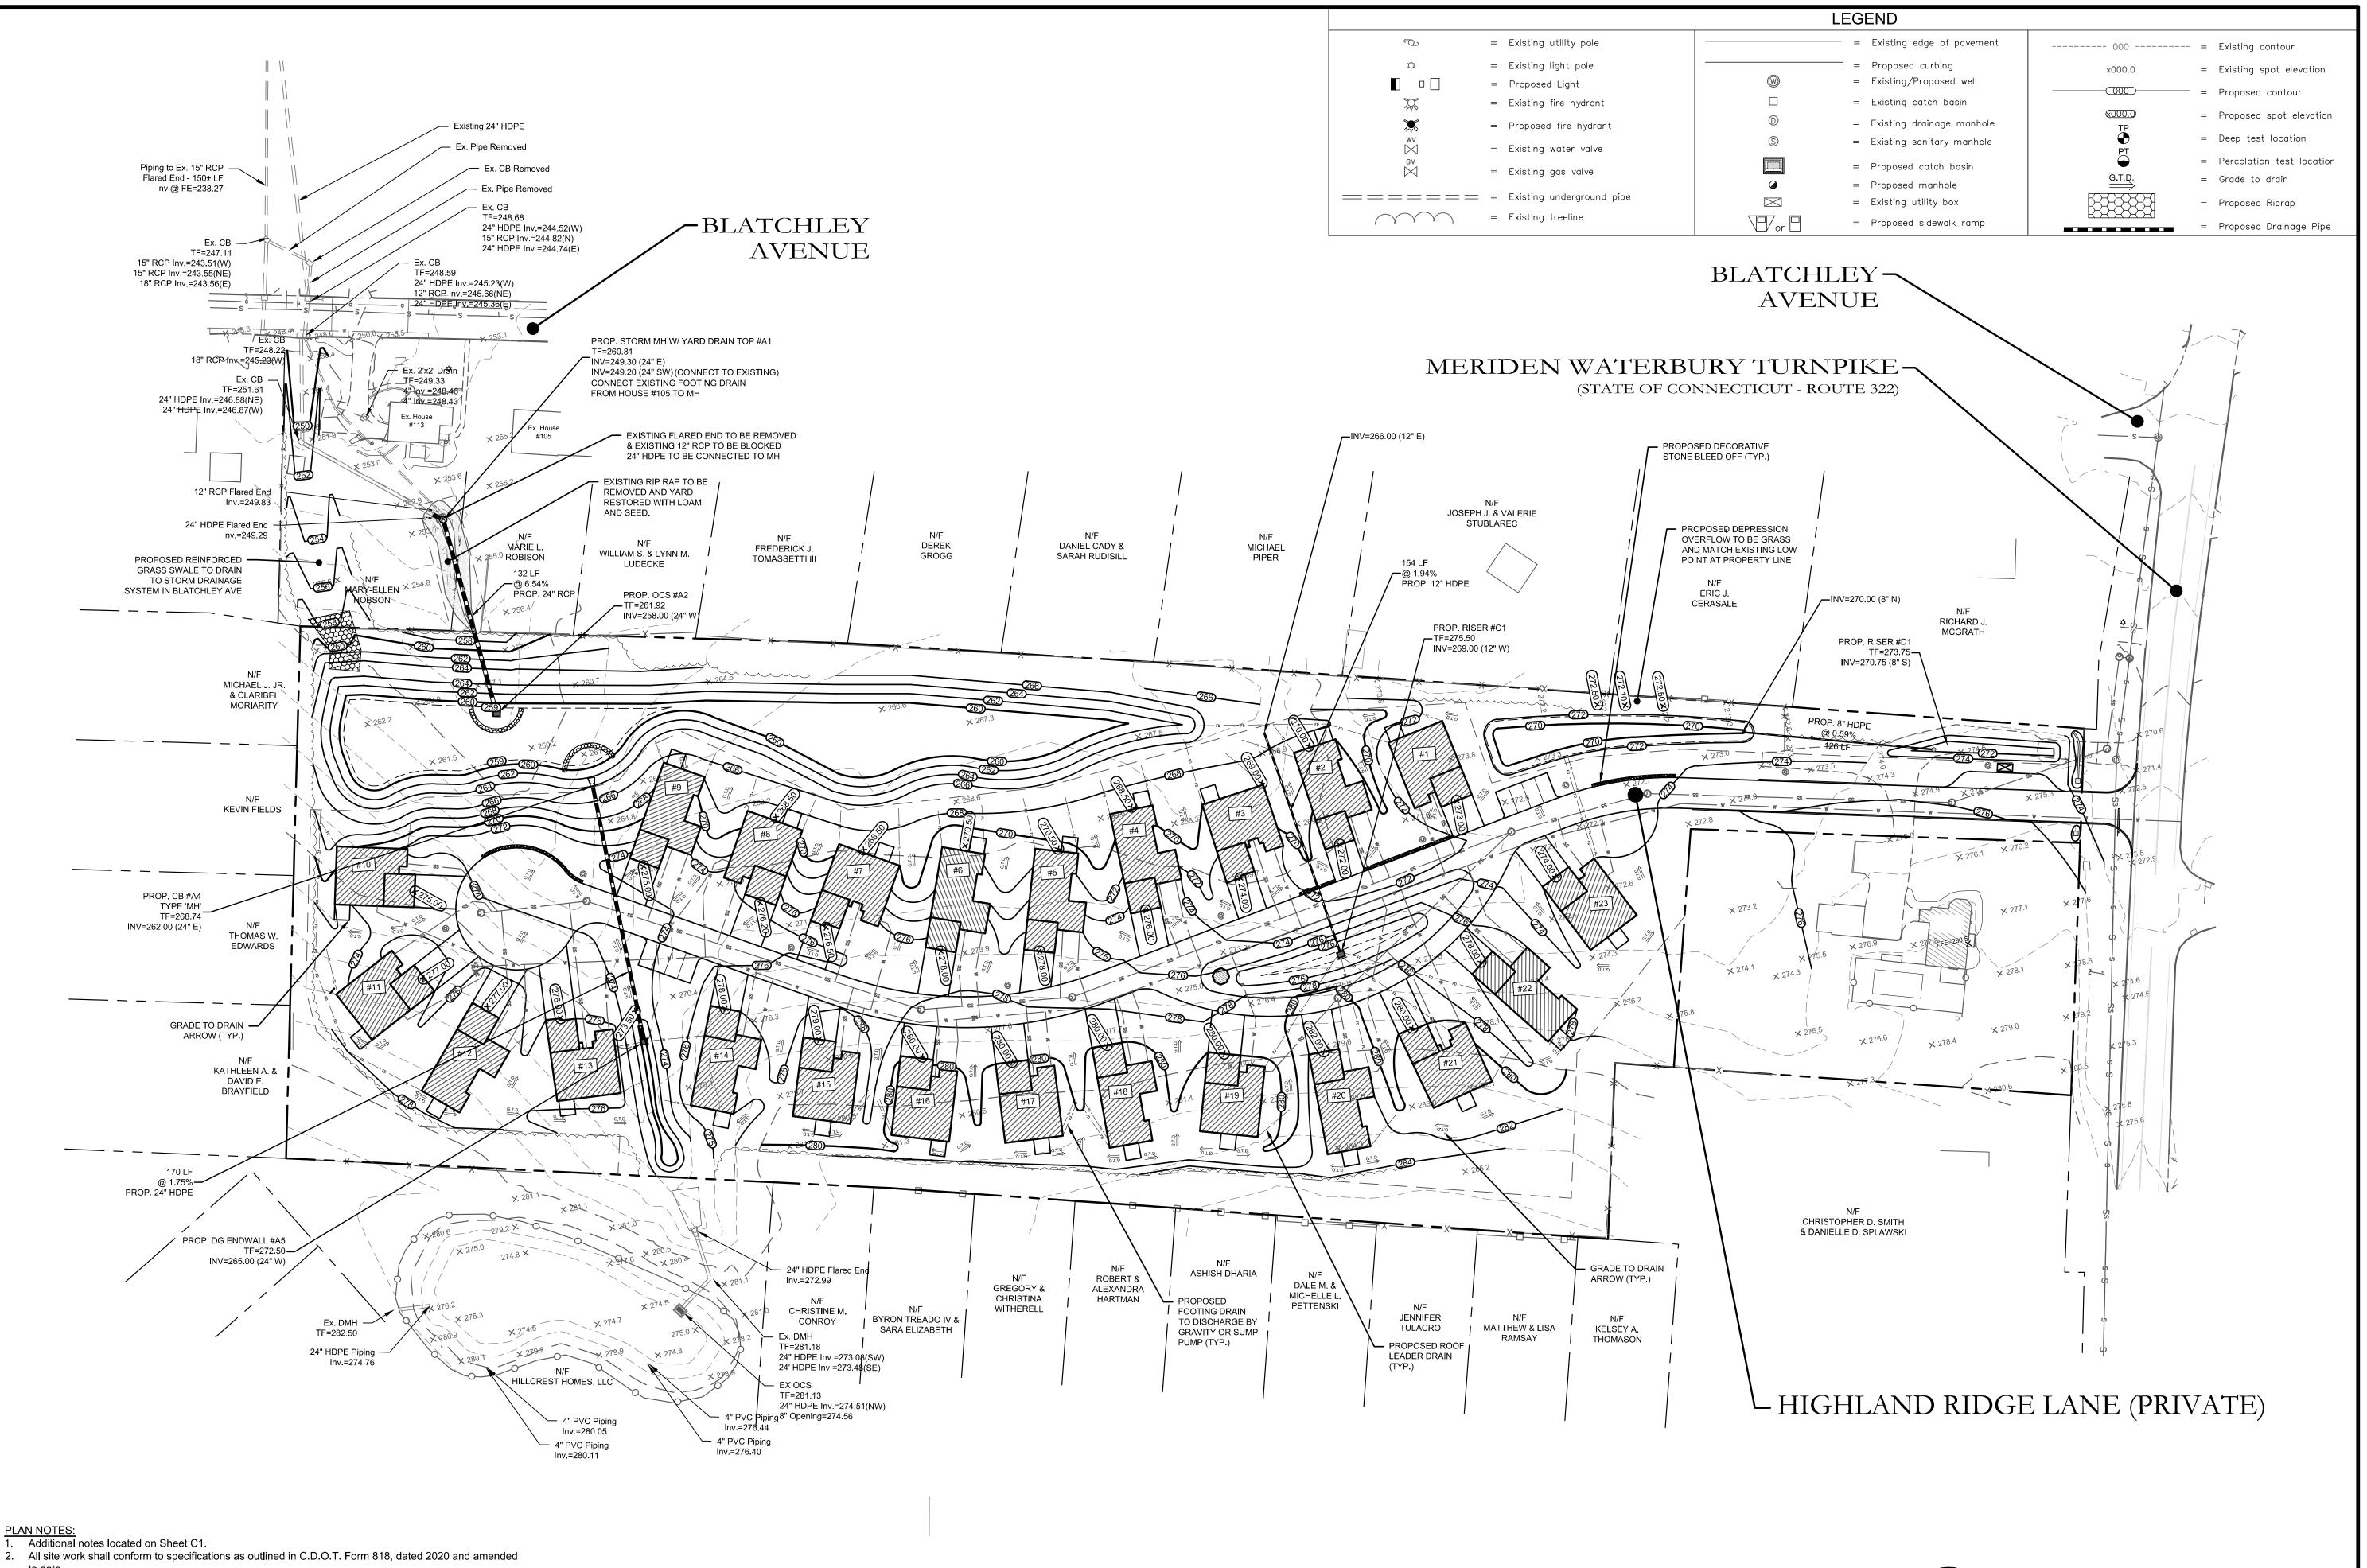provided by structural/geotechnical engineer prior to construction of walls.

Roof drains shall daylight to grass lawn areas.

All Catch Basins\Inlets shall be cleaned prior to occupancy.

(860)- 276-6231, 24 hours before site grading begins.

All areas disturbed by construction to be restored with 4" of loam and seeded.

7. Town of Southington Planning and Engineering Departments to be notified at (860)-276-6248 and

9. All existing utilities are from best available information, contractor to verify all locations, dimensions, and

10. No floor drains are proposed. Floor drains are not allowed without obtaining Connecticut DEEP permits.11. Building permit required for construction of retaining walls over 3-ft tall. Design of retaining walls shall be

Prior to any excavation, contractor to notify "CALL BEFORE YOU DIG," 1-800-922-4455.

Know what's below.
Call before you dig.

#13653

Barton N. Bovee P.E. Reg. No.

NOT VALID UNLESS EMBOSSED SEAL OR STAMP IS AFFIXED HERETO

NORTH

COC HARRY E. COLE & SON engineering. surveying. planning.

876 South Main Street Tel: (860) 628-4484
P.O. Box 44 Fax: (860) 620-0196
Plantsville, CT 06479 - 0044 www.hecole.com

PROJECT NAME:

HIGHLAND RIDGE ACTIVE ADULT COMMUNITY

570 Meriden Waterbury Turnpike Southington, Connecticut

PREPARED FOR:

AA DENORFIA
BUILDING &
DEVELOPMENT


Sheet Description:

SITE GRADING & DRAINAGE PLAN

50'	25'	0 25' 50'			
	1"=	=50'			
Date: September 1, 2022					
Project #: 2235		F.B. #:			
Drawn By: BTP	)	Approved By: BNB			
Revisions:					
Date:	Descrip	tions:			
Sept. 26, 2022	Revised per Town Comments				

Sheet #:

C2

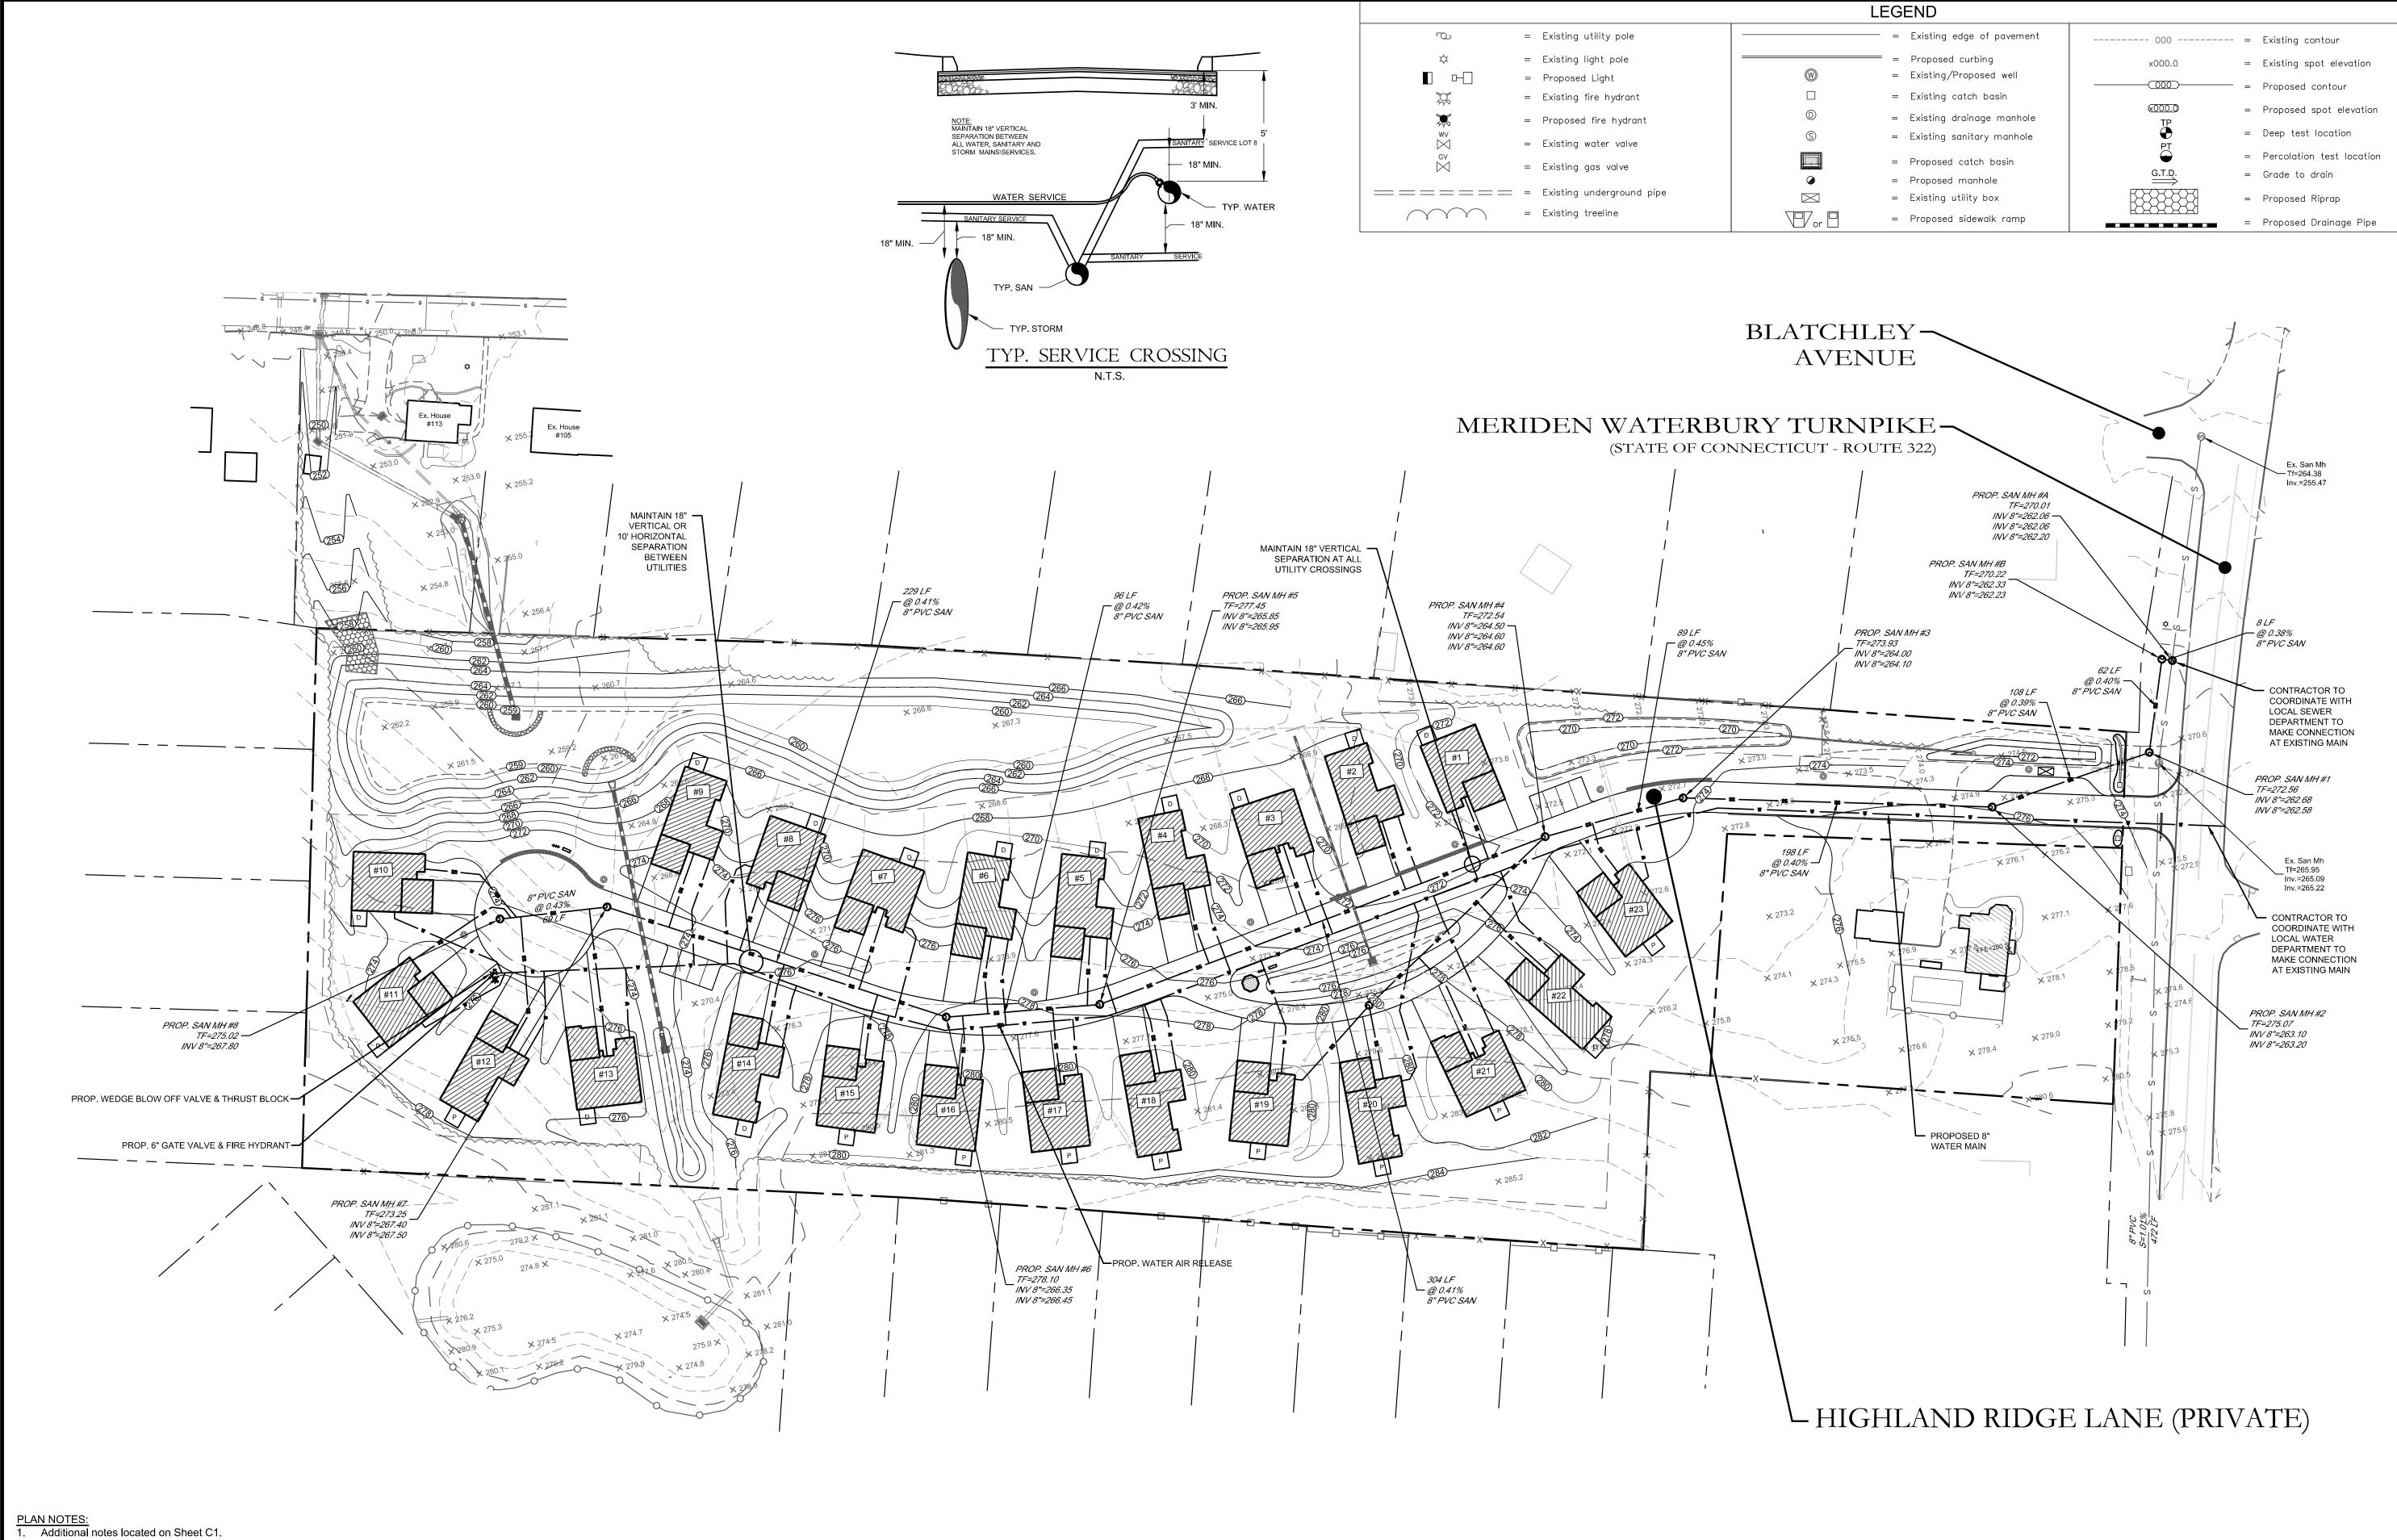

2. Site to be serviced by town water and sewer. 3. All work in connection with this plan shall be completed within five years of the date of approval, or the

approval is no longer valid. All site work shall conform to specifications as outlined in C.D.O.T. Form 818, dated 2020 and amended

Sanitary service connection for domestic\office waste only. No industrial waste shall be discharged. 6. Water service sizing to be determined by the Southington Water Department upon receipt of all

pertinent water fixture data.

7. Town of Southington Planning and Engineering Departments to be notified at (860)-276-6248 and (860)- 276-6231, 24 hours before site grading begins.


Prior to any excavation, contractor to notify "CALL BEFORE YOU DIG," 1-800-922-4455. 9. All existing utilities are from best available information, contractor to verify all locations, dimensions, and

elevations prior to construction. Notify Engineer of any discrepancies. 10. No floor drains are proposed. Floor drains are not allowed without obtaining Connecticut DEEP permits.

11. Building permit required for construction of retaining walls over 3-ft tall. Design of retaining walls shall be provided by structural/geotechnical engineer prior to construction of walls.

Know what's **below**. **Call** before you dig.

Barton N. Bovee P.E. Reg. No. NOT VALID UNLESS EMBOSSED SEAL OR STAMP IS AFFIXED HERETO

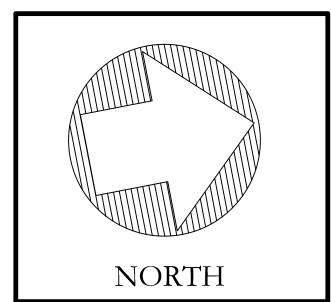

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I	HARRY E. COLE & SON
	engineering. surveying. planning

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PROJECT NAME:

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570 Meriden Waterbury Turnpike Southington, Connecticut


PREPARED FOR:


AA DENORFIA BUILDING & DEVELOPMENT

### **Sheet Description:**

SEWER & WATER PLAN

50	25	0 25 50			
1"=50'					
Date: September 1, 2022					
Project #: 2235		F.B. #:			
Drawn By: BTP	1	Approved By: BNB			
Revisions:					
Date:	Descriptions:				
Sept. 26, 2022	Revised per Town Comments				
		_			

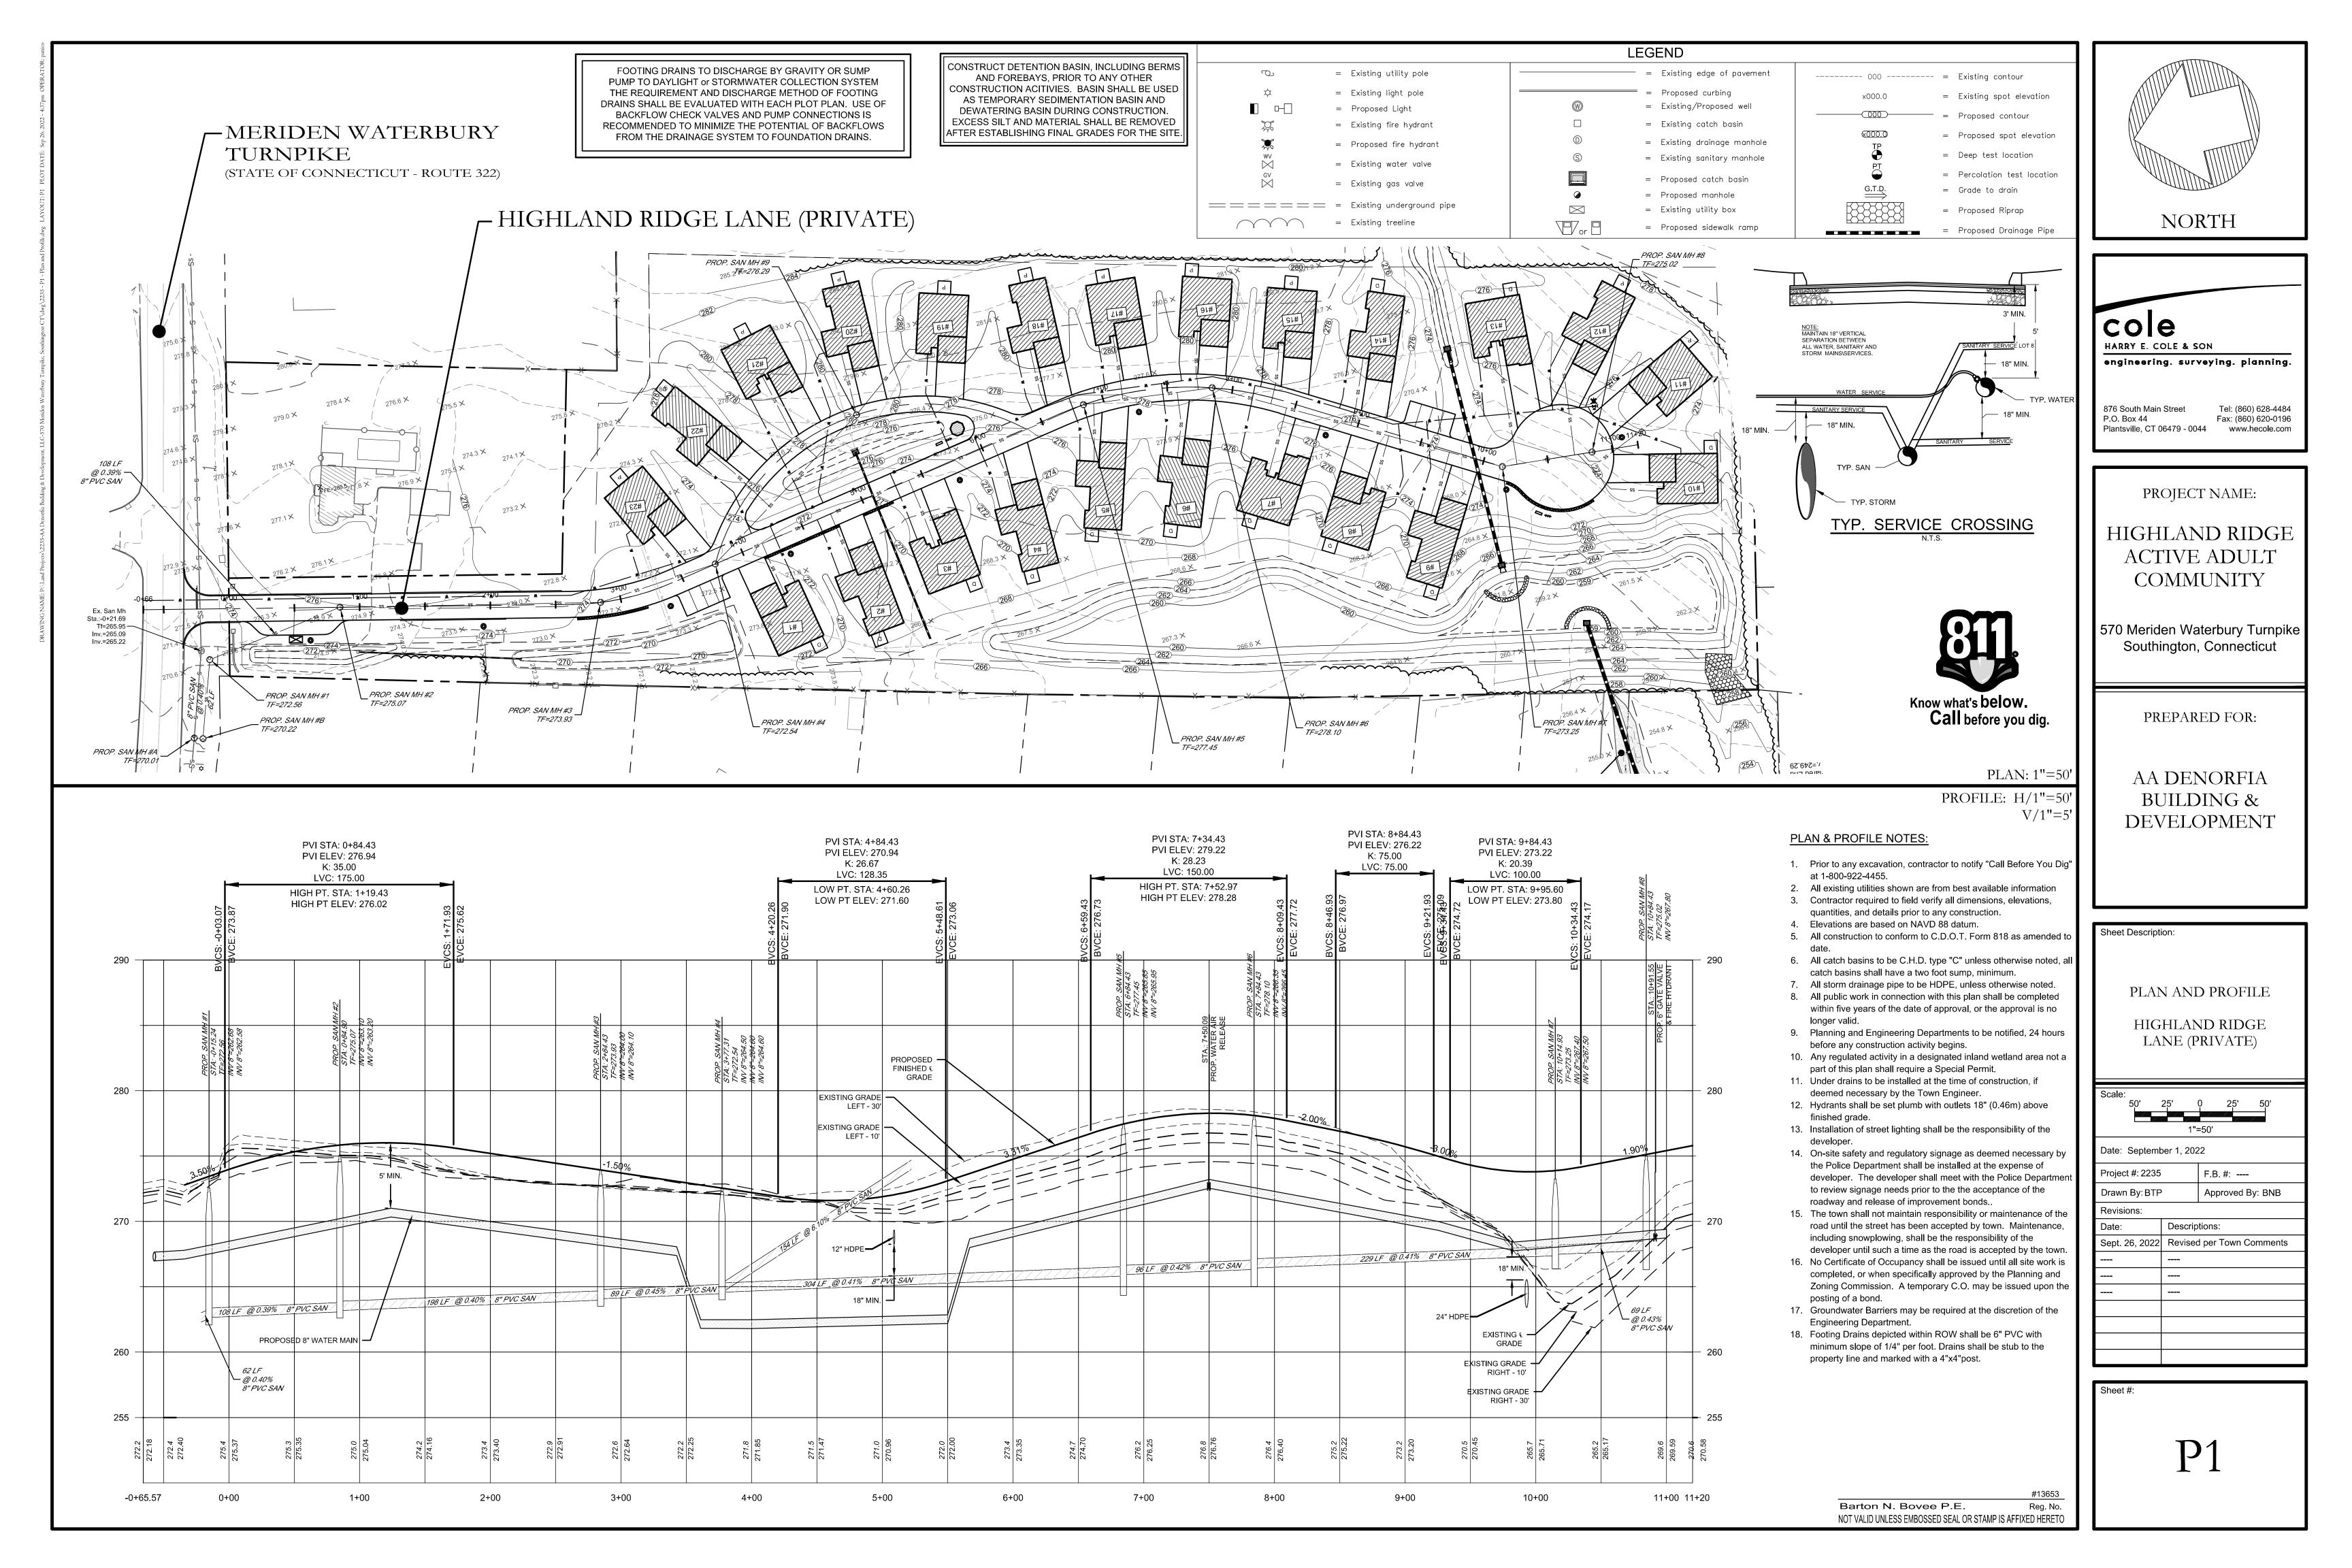

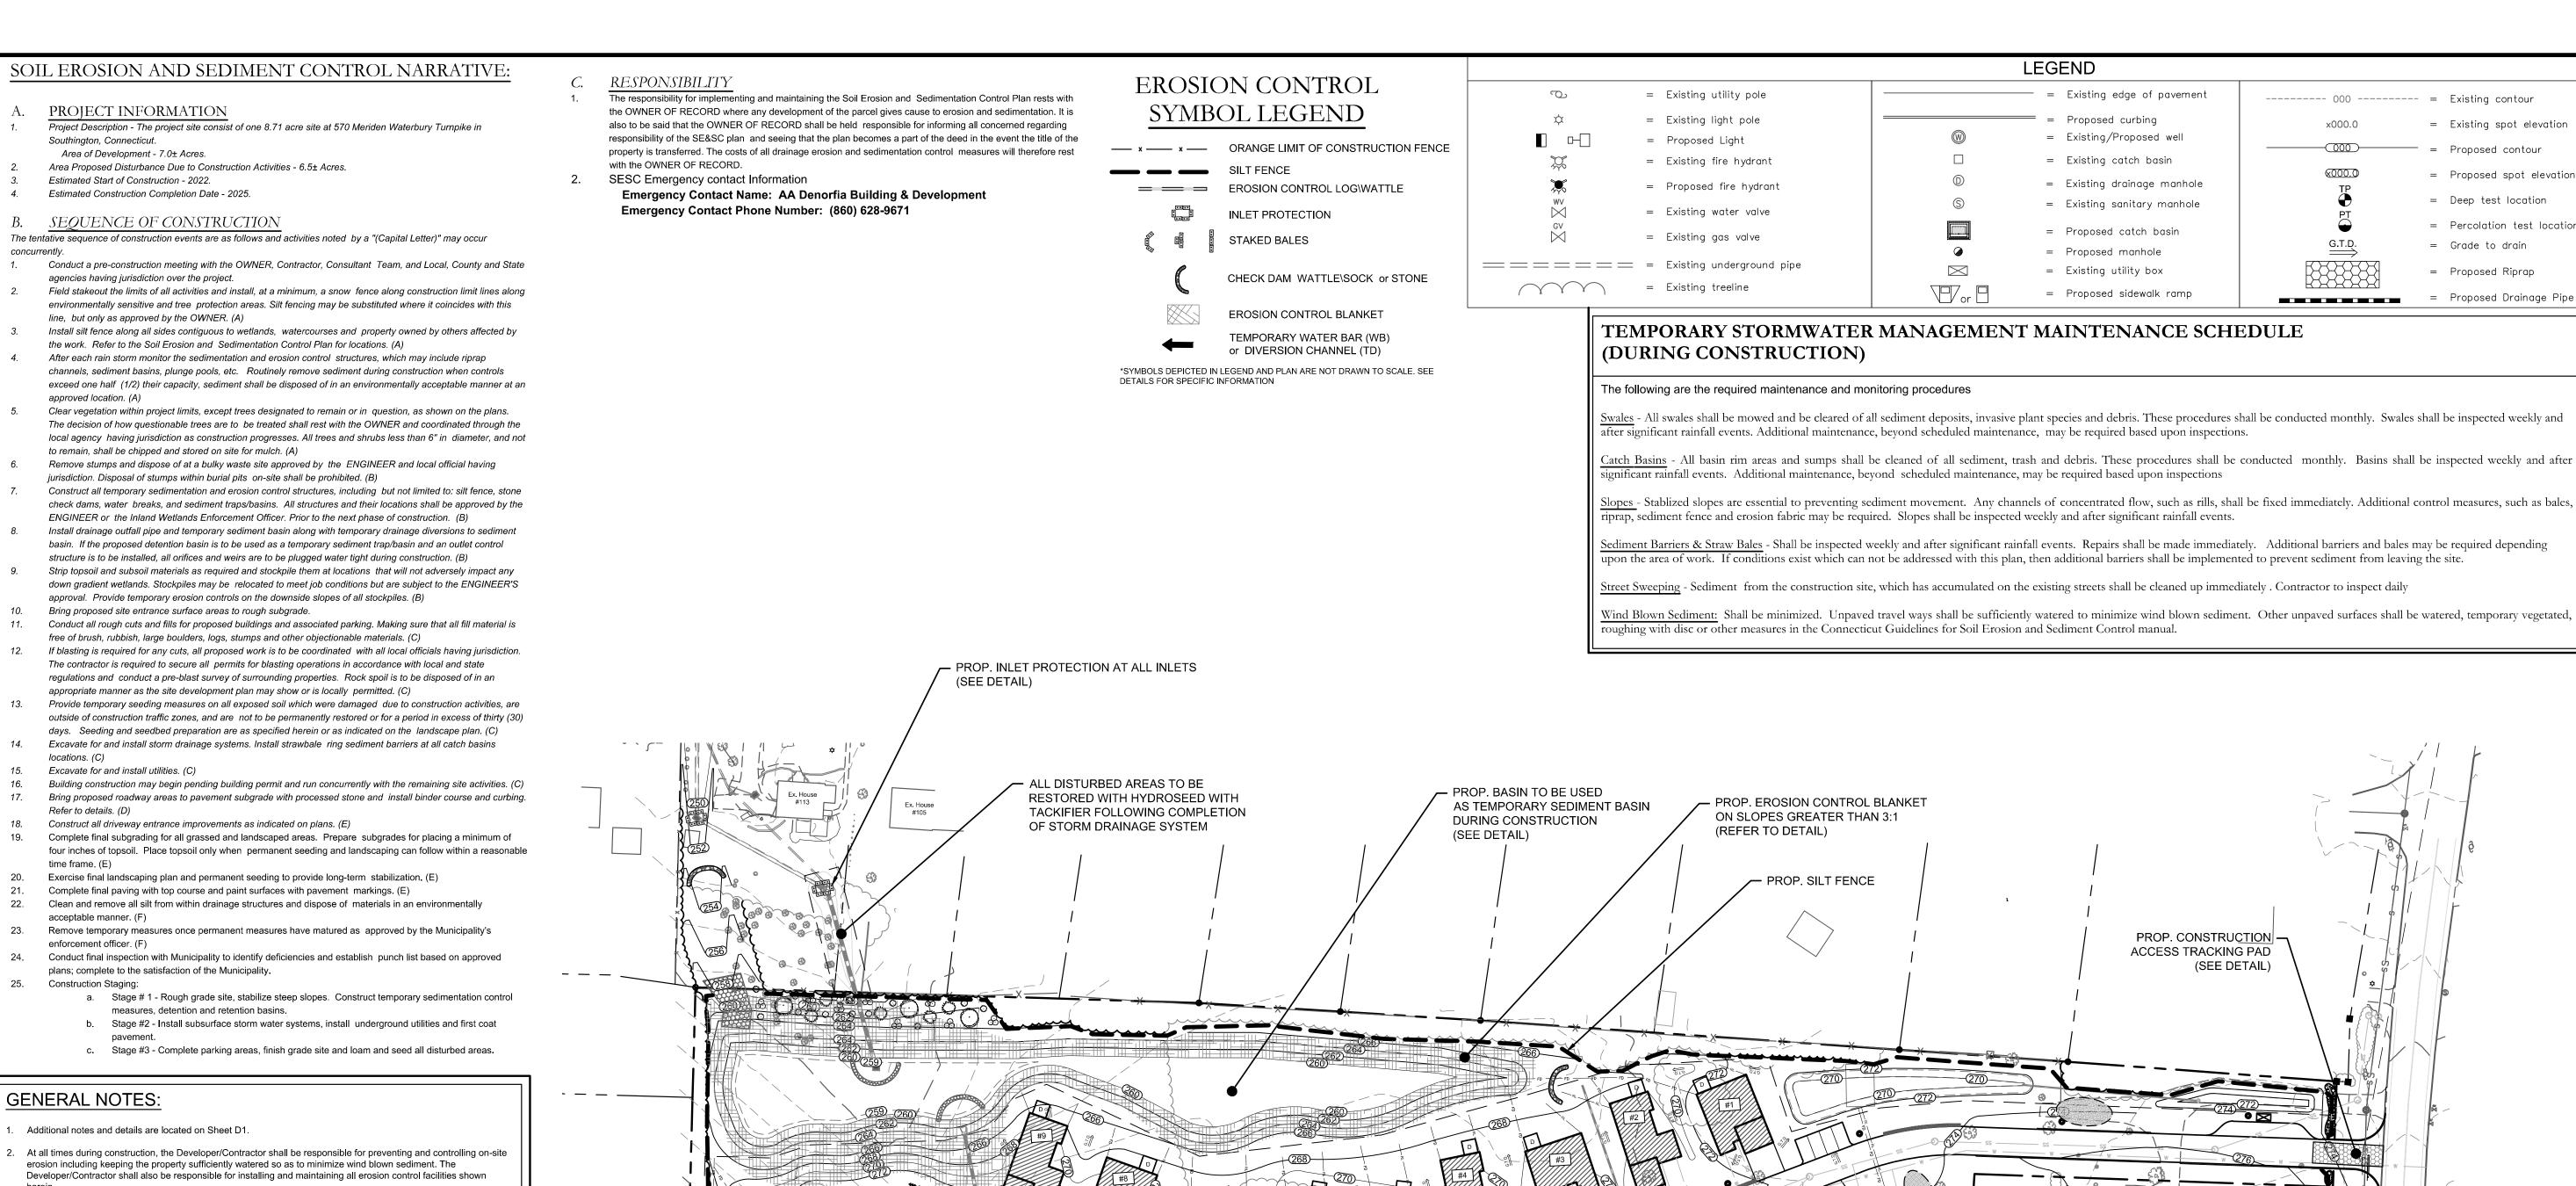

- All soils exposed during land disturbing activity (stripping, grading, utility installations, stockpiling, filling, etc.) shall be kept in a roughened condition by ripping or disking along land contours until mulch, vegetation, or other permanent erosion control BMPs are installed. No soils in areas outside project street rights-of-way and future pavement shall remain exposed by land disturbing activity for more than thirty (30) days before required temporary or permanent erosion control (e.g. watering, seed/mulch, landscaping, etc.) is installed, unless otherwise approved by the Town
- All inlets shall be cleaned prior to occupancy.
- All slopes greater than 3:1 shall be protected with Erosion Control Blankets (S150 by North American Green or
- All erosion control measures shall remain intact and operational until the site has been stabilized and vegetation is thoroughly established. This may occur after completion of construction, therefore it is critical for the Developer, Contractor and\or Owner to understand the erosion control responsibilities and maintain the erosion control
- To minimize erosion of the sandy soils, vegetation shall be established immediately following completion of grading within each area. Vegetation may consist of temporary seeding or final loam and seed.
- If areas of work are not addressed by this plan or sediment and erosion issues arise in areas not covered by this plan, then the plan shall be augmented in the field. Contractor shall be responsible to insure no sediment or erosion problems encroach upon abutting property. This may require additional barriers, swales and bales.
- All erosion and sediment control measures shall conform to the 2002 Connecticut Guidelines for Soil Erosion and Sediment Control manual.

D. All Dewatering shall incorporate the use of filter bags on discharge ends.

### STORMWATER MANAGEMENT MAINTENANCE **SCHEDULE**

SOUTHINGTON, CONNECTICUT

The following are the required maintenance and monitoring procedures.

Riprap and Discharge Aprons - Shall be cleared of all sediment deposits and invasive plant species and are to be nspected for rip-rap damage and deterioration. These procedures to be conducted yearly between May I and before

Outlet Control Structure - Shall be cleaned of all sediment, trash and debris and is to be inspected for structural integrity. These procedures to be conducted yearly between May 1 and September 15. Structure shall be inspected two times a year and after significant rainfall events. Additional maintenance, beyond scheduled maintenance, may be required based upon inspections. Repairs shall be executed immediately.


Emergency Spillway - Shall be cleared of all sediment deposits and invasive plant species and are to be inspected for riprap damage and deterioration. These procedures to be conducted yearly between May 1 and September 15. Repairs


Catch Basins - All basin rim areas and sumps shall be cleaned of all sediment, trash and debris. These procedures to be onducted yearly anytime after May I and before September 15.

<u>Swales</u> - all swales be cleared of all sediment deposits, invasive plant species and debris. Any erosion shall be repaired. hese procedures to be conducted annually. Swales shall be inspected two times a year and after significant rainfall events. Additional maintenance, beyond schedule maintenance, may be required based upon inspections

Water Quality Basin - Basin shall be cleared of all sediment deposits, invasive plant species and debris. These procedures to be conducted yearly between May 1 and September 15. Basin shall be inspected two times a year and after significant rainfall events. Additional maintenance, beyond scheduled maintenance, may be required based upon

Slopes - Slope erosion control blankets and vegetation shall be inspected twice a year and after significant rainfall events. Additional maintenance, beyond schedule maintenance, may be required based upon inspections. Any rills or channeling shall be repaired immediately

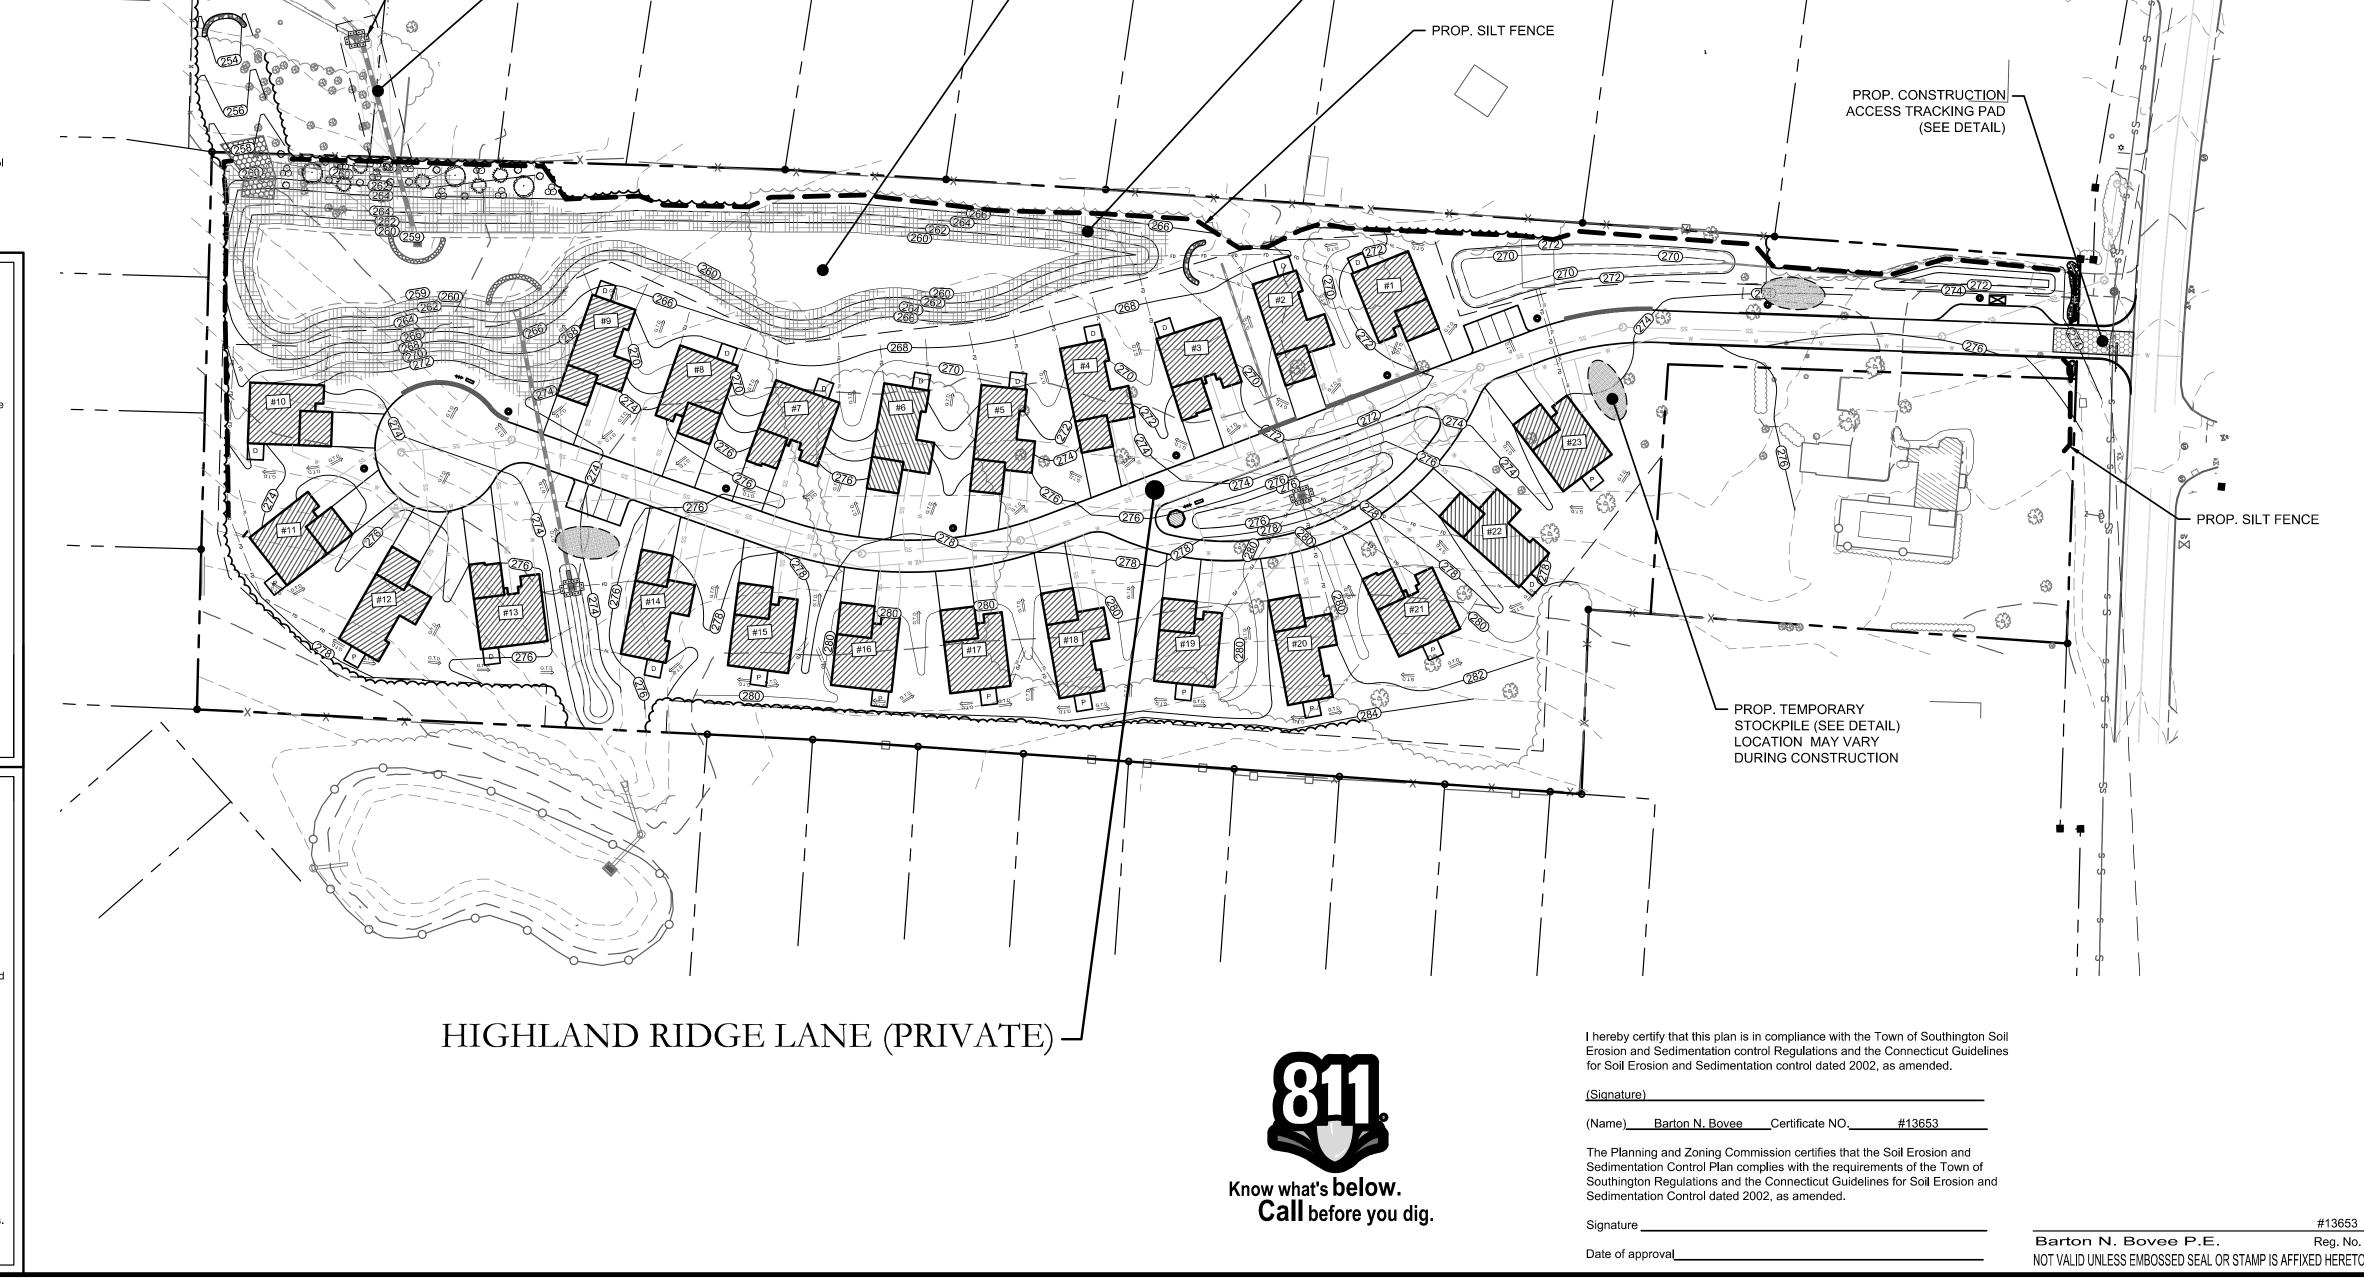

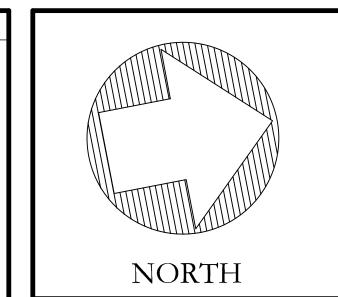

---- 000 ---

- = Existing contour

= Existing spot elevation

= Proposed spot elevation

= Percolation test location

= Proposed Drainage Pipe

= Proposed contour

= Deep test location

= Grade to drain

= Proposed Riprap

cole HARRY E. COLE & SON engineering, surveying, planning.

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PROJECT NAME:

HIGHLAND RIDGE ACTIVE ADULT COMMUNITY

570 Meriden Waterbury Turnpike Southington, Connecticut


PREPARED FOR:

AA DENORFIA **BUILDING &** DEVELOPMENT

Sheet Description

SOIL EROSIOIN & SEDIMENTATION CONTROL PLAN


60'	30'	30'	60' ——			
1"=60'						
Date: September 1, 2022						
Project #: 2235		F.B. #:				
Orawn By: BTP	•	Approved By: BNB				
Revisions:						
Date:	Descrip	tions:				
Sept. 26, 2022	Revised	per Town Comments				
			_			

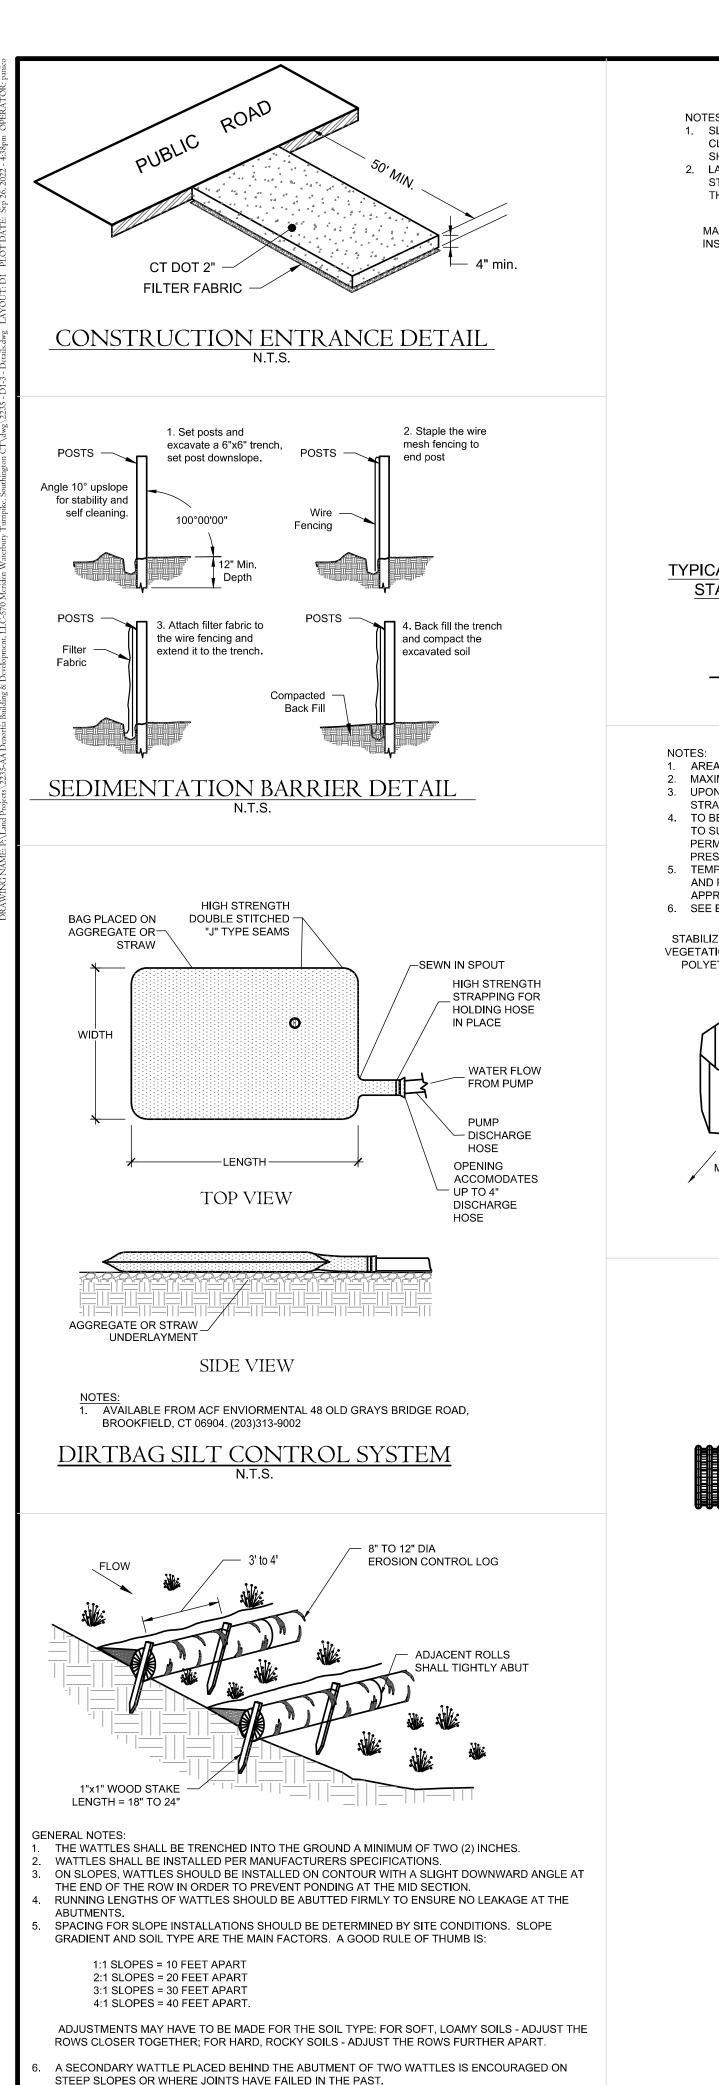

USE WOOD STAKES TO SECURE THE WATTLES. 1/2" TO 5/8" REBAR IS ALSO ACCEPTABLE. BE SURE TO USE A STAKE THAT IS LONG ENOUGH TO PROTRUDE SEVERAL INCHES ABOVE THE WATTLE: 18" IS A GOOD LENGTH FOR HARD, ROCKY SOIL. FOR SOFT LOAMY SOIL USE A 24" STAKE. STAKES SHOULD


EROSION CONTROL LOG SLOPE PROTECTION


BE DRIVEN THROUGH THE MIDDLE OF THE WATTLE. LEAVING 2 - 3 INCHES OF THE STAKE

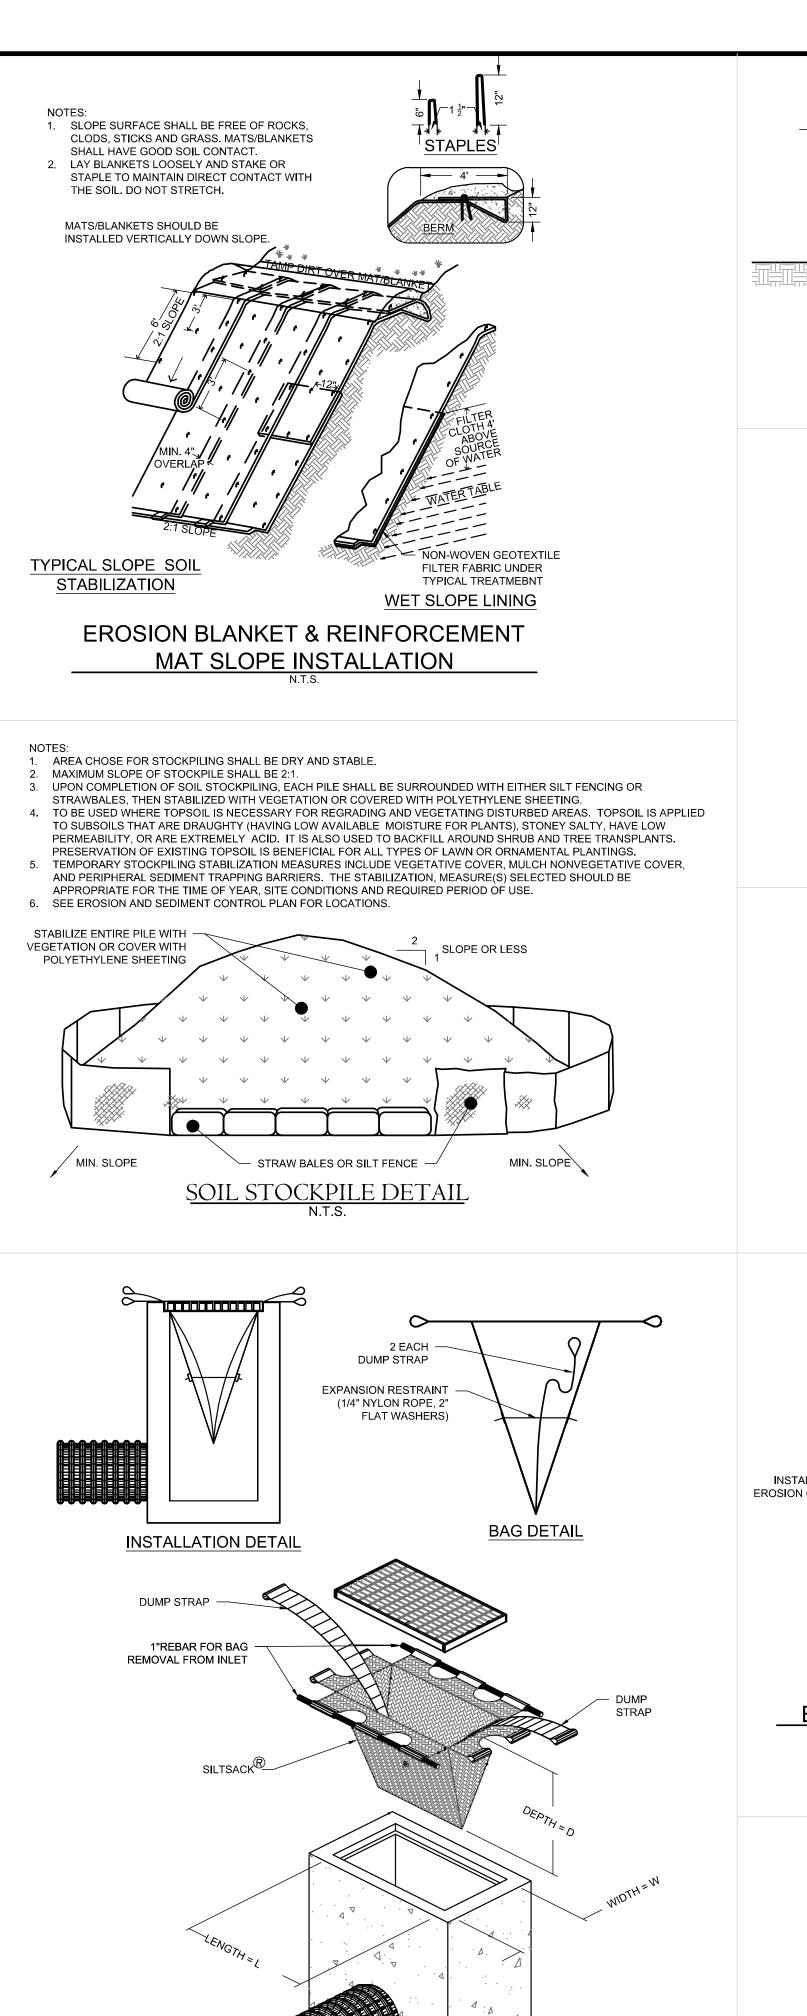


1. AVAILABLE FROM ACF ENVIRONMENTAL 48 OLD GRAYS BRIDGE

SILTSACK INLET CONTROL DEVICE

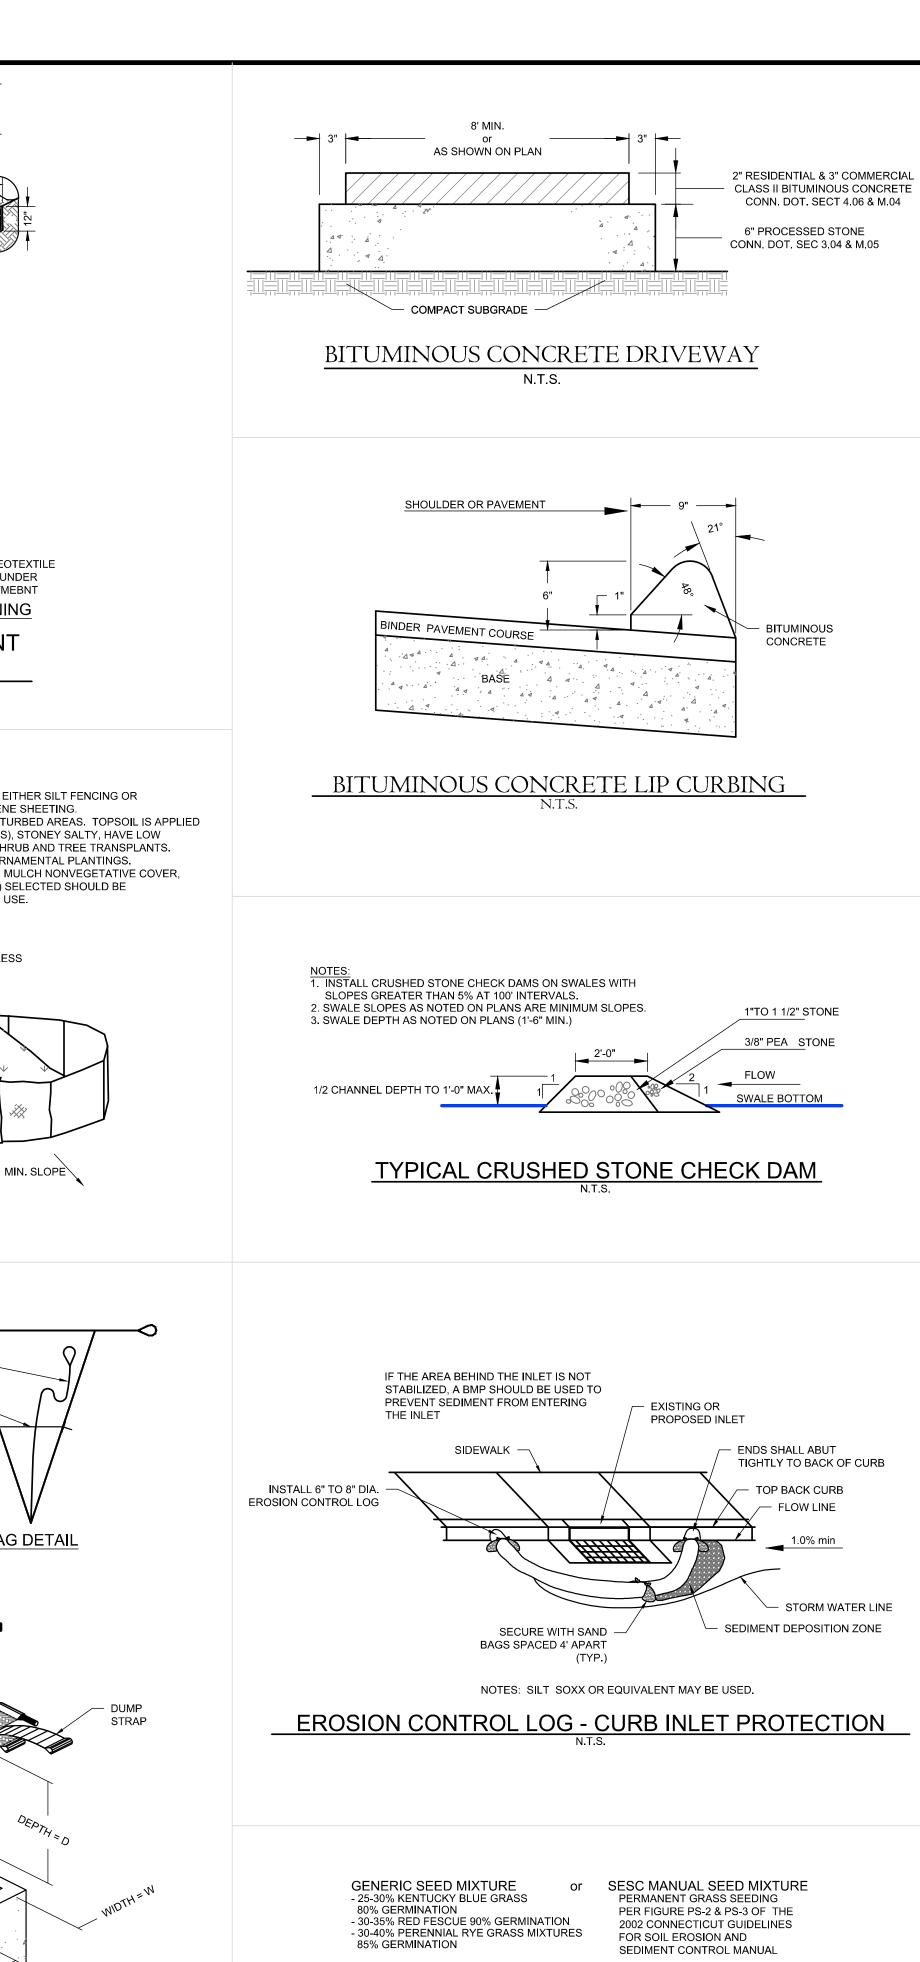

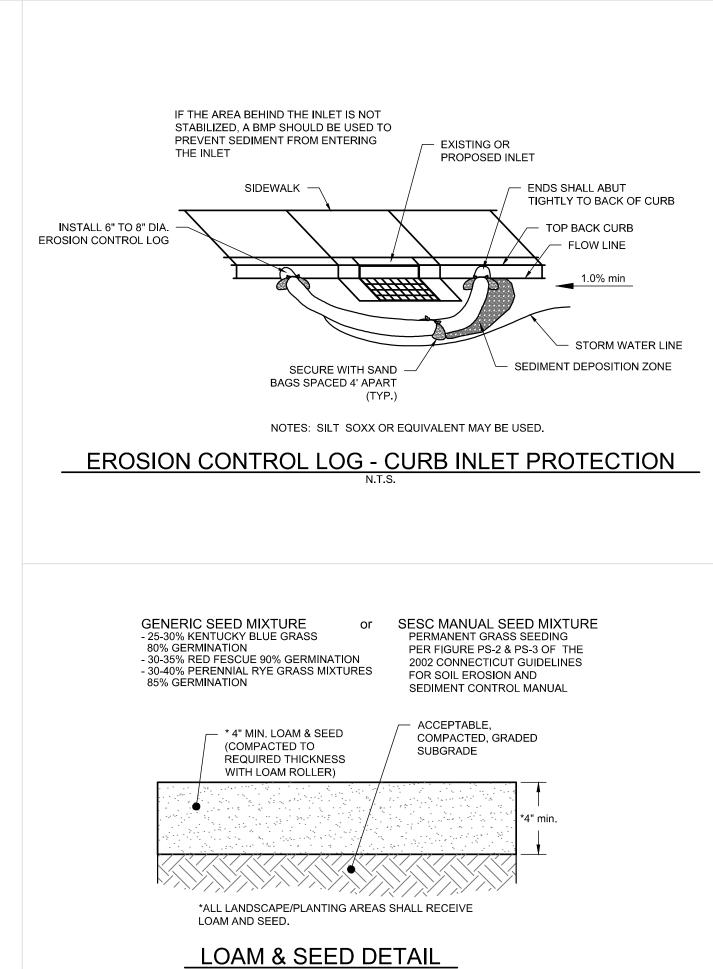


CONCRETE

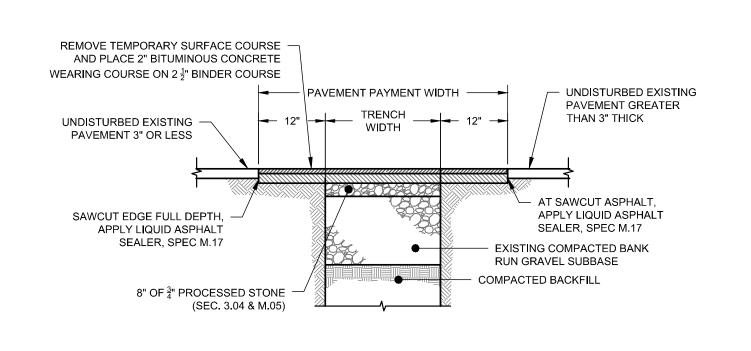


1. ALL PAVEMENT PATCH CONSTRUCTION SHALL CONFORM TO CONN. DOT FORM 816 SPECIFICATIONS AND STANDARDS.

PERMANENT PAVEMENT PATCH DETAIL

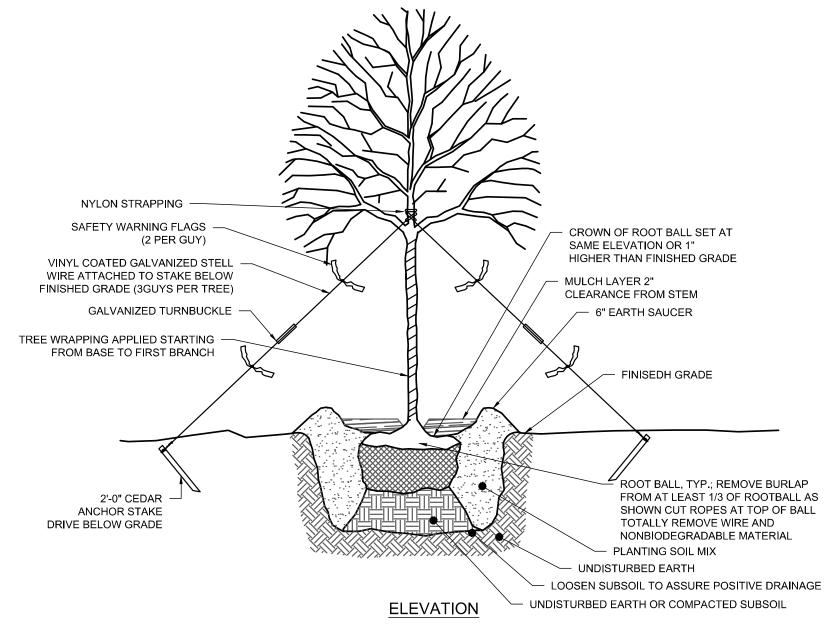

TREE PLANTING AND GUYING DETAIL INSTALLED IN OPEN AREAS

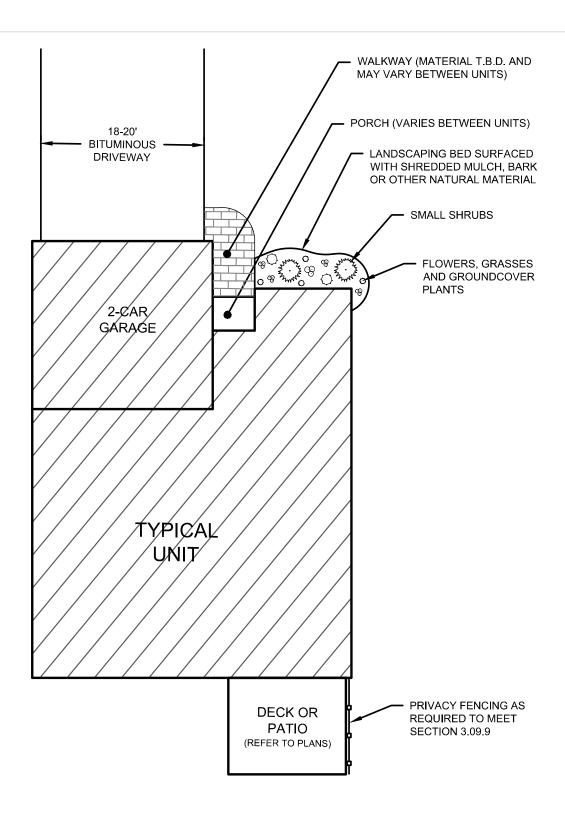

TYPICAL UNIT FOUNDATION PLANTING & PATIO/DECK DETAIL

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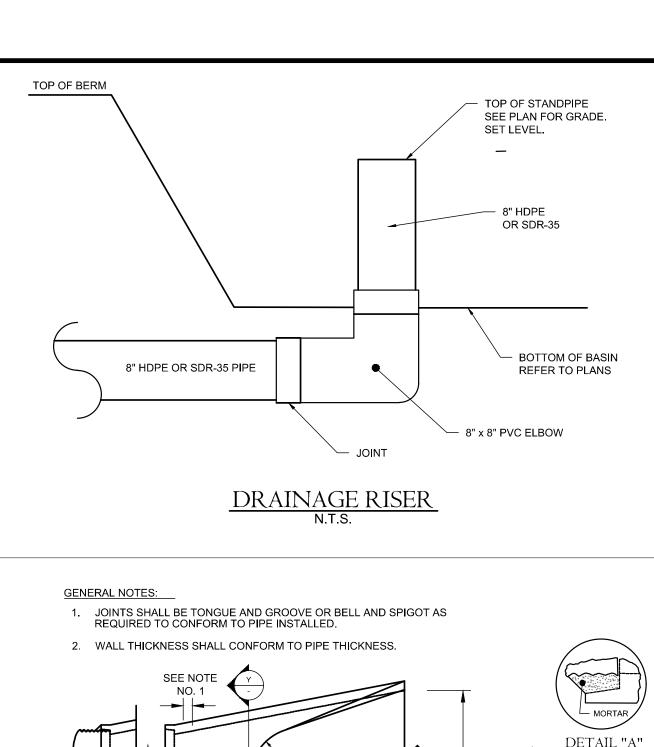
570 Meriden Waterbury Turnpike Southington, Connecticut


PREPARED FOR:

AA DENORFIA **BUILDING &** DEVELOPMENT

**Sheet Description:** 

DETAILS N.T.S. Date: September 1, 2022 F.B. #: ----Project #: 2235 Drawn By: BTP Approved By: MSL Revisions: Descriptions: Sept. 26, 2022 Revised per Town Comments



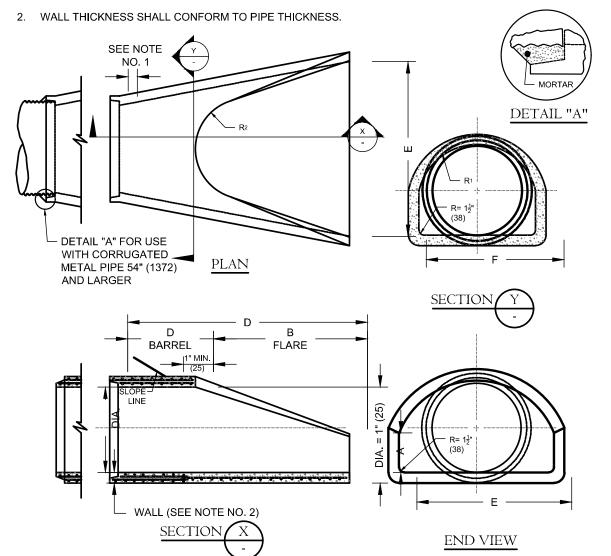


	DIMENSIONS FOR REINFORCED CONCRETE CULVERT END							REINFORCEMENT ONE LAYER ONLY IN CENTER OF WALL		
DIA.	А	В	С	D	Е	F	R <sub>1</sub>	R <sub>2</sub>	MIN. AREA OF LONGITUDINAL STEEL SQ. IN. PER FT.	MIN. AREA OF TRANSVERSE STE SQ. IN. PER FT.
12"(305)	4"(102)	2'-0"(610)	4'-0 <sup>3</sup> / <sub>8</sub> "(1241)	6'-0 <sup>3</sup> ''(1851)	2'-0"(610)	1'-7냚(506)	10 <sup>1</sup> / <sub>4</sub> "(260)	9"(229)	0.048	0.048
15"(381)	6"(152)	2'-3"(686)	3'-10"(1168)	6'-1"(1854)	2'-6"(762)	2'-0 <sup>5</sup> / <sub>16</sub> "(618)	1'-0½"(318)	11"(279)	0.054	0.054
18"(457)	9"(229)	2'-3"(686)	3'-10"(1168)	6'-1"(1854)	3'-0"(914)	2'-5"(737)	1'-3½"(394)	1'-0"(305)	0.060	0.060
21"(533)	9"(229)	2'-11"(889)	3'-2"(965)	6'-1"(1854)	3'-6"(1067)	2'-7½"(800)	1'-4"(406)	1'-1"(330)	0.066	0.066
24"(610)	9½"(241)	3'-7 <sup>1</sup> / <sub>2</sub> "(1105)	2'-6"(762)	6'-1 <sup>1</sup> / <sub>2</sub> "(1867)	4'-0"(1219)	2'-9 <sup>3</sup> / <sub>16</sub> "(843)	1'-4 <del>13</del> "(427)	1'-2"(356)	0.072	0.072
30"(762)	1'-0"(305)	4'-6"(1371)	1'-7 <sup>3</sup> ''(502)	6'-1 <sup>3</sup> "(1873)	5'-0"(1524)	3'-1"(940)	1'-6½"(470)	1'-3"(381)	0.084	0.084
36"(914)	1'-3"(381)	5'-3"(1600)	2'-10 <sup>3</sup> "(883)	8'-1 <sup>3</sup> ''(2483)	6'-0"(1829)	3'-11 <del>13</del> "(1214)	2'-0 <sup>5</sup> / <sub>16</sub> "(618)	1'-8"(508)	0.096	0.096
42"(1067)	1'-9"(534)	5'-3"(1600)	2'-11"(889)	8'-2"(2489)	6'-6"(1981)	4'-5 <sup>7</sup> / <sub>8</sub> "(1368)	2'-3 <sup>1</sup> <sub>2</sub> "(699)	1'-10"(559)	0.108	0.108
48"(1219)	2'-0"(610)	6'-0"(1829)	2'-2"(660)	8'-2"(2489)	7'-0"(2134)	4'-8½"(1435)	2'-4½"(724)	1'-10"(559)	0.120	0.120
54"(1372)	2'-3"(686)	5'-5"(1651)	2'-11"(889)	8'-4"(2540)	7'-6"(2286)	5'-5½"(1664)	2'-9 <sup>1</sup> / <sub>8</sub> "(841)	2'-0"(610)	0.132	0.132
60"(1524)	2'-9"(838)	5'-0"(1524)	3'-3"(991)	8'-3"/2515)	8'-0"(2438)	6'-0 <sup>1</sup> ''(1842)	3'-011''(932)	2'-0"(610)	0 144	0.144

## REINFORCED CONCRETE CULVERT END


- NOTES:

  1. FOR UNSHEETED TRENCH WHERE PIPE O.D. IS 6" OR LESS THAN, PAYMENT WIDTH (W) = 2"-6"; WHERE PIPE O.D. IS GREATER THAN 6" BUT LESS THAN OR EQUAL TO 36" THEN, W = O.D. + 2'-0"; WHERE PIPE O.D. IS GREATER THAN 36" THEN, W = O.D. + 3'-0".
- 2. IF SUITABLE GRANULAR PIPE BEDDING MATERIAL IS AVAILABLE FROM ON SITE EXCAVATIONS, IT SHALL BE UTILIZED PROVIDED IT
- 3. TYPICAL FOR PIPE MATERIALS SPECIFIED, AS CAST IRON (C.I.), CONCRETE PIPE, DUCTILE IRON PIPE OR STEEL PIPE.
- 4. SHEETING OR SHORING OF TRENCH WALLS, WHERE UNSUITABLE CONDITIONS EXIST, IS THE SOLE RESPONSIBILITY OF THE CONTRACTOR.
- 5. FOR ROCK REMOVAL DEPTHS (H) GREATER THAN 10', INCREASE PAYMENT WIDTH (W) BY 6". REMOVAL DEPTH SHALL BE MEASURED FROM THE TOP OF EXPOSED SURFACE.

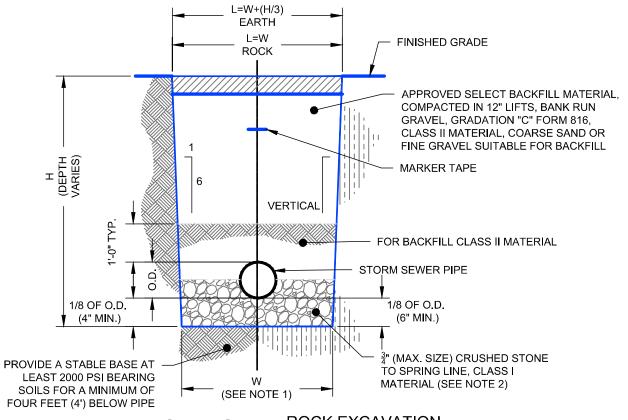



EARTH EXCAVATION ROCK EXCAVATION

STORM CLASS 'C' TRENCH DETAIL N.T.S.

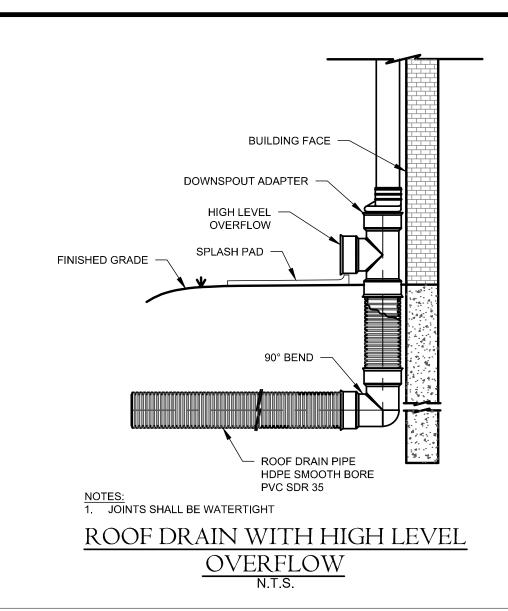

- SITE PREPARATION: GRADE SURFACE OF INSTALLATION AREAS SO GROUND IS SMOOTH AND COMPACT. REMOVE ALL ROCKS, ROOTS AND OTHER OBSTRUCTIONS FROM LYING IN DIRECT CONTACT WITH THE SOIL. SURFACE AND THE MAT.
- PROVIDE 4" TO 6" ROLLED TOPSOIL, SEED, AND FERTILIZE. INSTALL MAT AS DIRECTED BELOW AND RESEED AREAS DISTURBED DURING MAT INSTALLATION. SEED DISTURBED ARES OUTSIDE OF MAT INSTALLATION AND MULCH WITH HAY.
- 3. PREPARE 6" X 12" MAT ANCHOR TRENCHES AT TERMINAL ENDS 6" X 6" PERIMETER TRENCHES AT SIDES OF INSTALLATION.
- 4. GROUND FASTENING: 18" PINS, 3/16"Ø, WITH ATTACHED 1 1/2" WASHERS. PIN EACH MAT AT CENTER AND AT OVERLAPPED EDGES.
- 5. ROLL WIDTH OVERLAPS SHALL BE A MINIMUM OF 3". PIN AT 3' TO 5' INTERVALS. SPLICE ROLL ENDS IN A 6" X 6" CHECK SLOT.
- 6. BACKFILL TO COVER CONCLUDING AND CONTINUING ENDS AND FASTENERS, TAMP FIRMLY, AND ROLL CONTINUING MAT ROLL ACROSS BACKFILL AND PIN AGAIN.
- 7. PERIMETER TRENCHES SHOULD ONLY BE DUG UPON REACHING ACTUAL PERIMETER OF INSTALLATION. PIN AT 3' TO 5' INTERVALS PRIOR

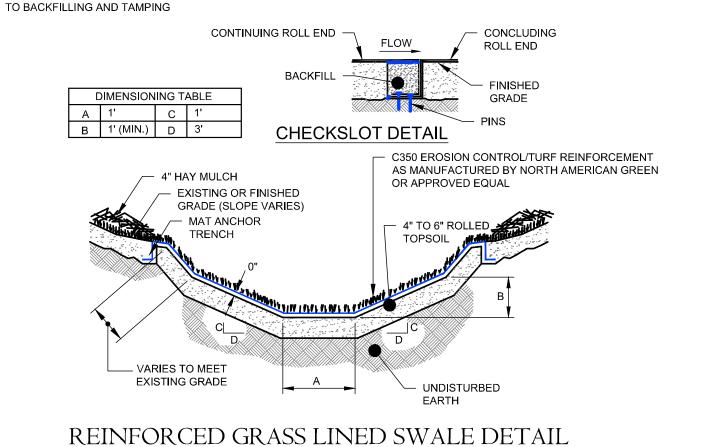

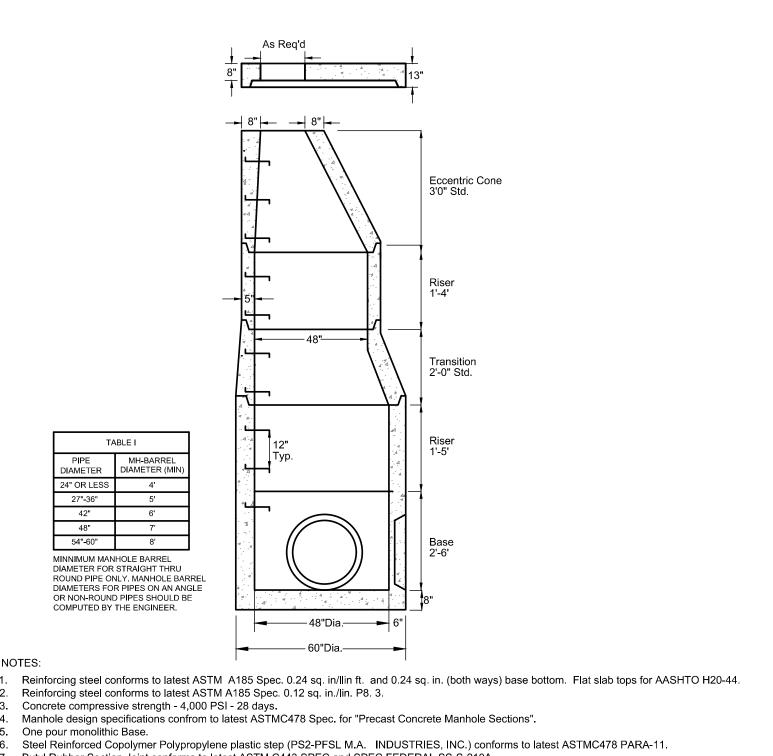



Reinforcing steel conforms to latest ASTM A185 Spec. 0.12 sq. in./lin. P8. 3. Concrete compressive strength - 4,000 PSI - 28 days. Manhole design specifications confrom to latest ASTMC478 Spec. for "Precast Concrete Manhole Sections". One pour monolithic Base. 6. Steel Reinforced Copolymer Polypropylene plastic step (PS2-PFSL M.A. INDUSTRIES, INC.) conforms to latest ASTMC478 PARA-11.

7. Butyl Rubber Section Joint conforms to latest ASTM C443 SPEC and SPEC FEDERAL SS-S-210A.

> STORMWATER PRECAST CONCRETE MANHOLE DETAIL

8. When specified Manholes coated with KOPPERS SUPER SERVICE BLACK or equal.

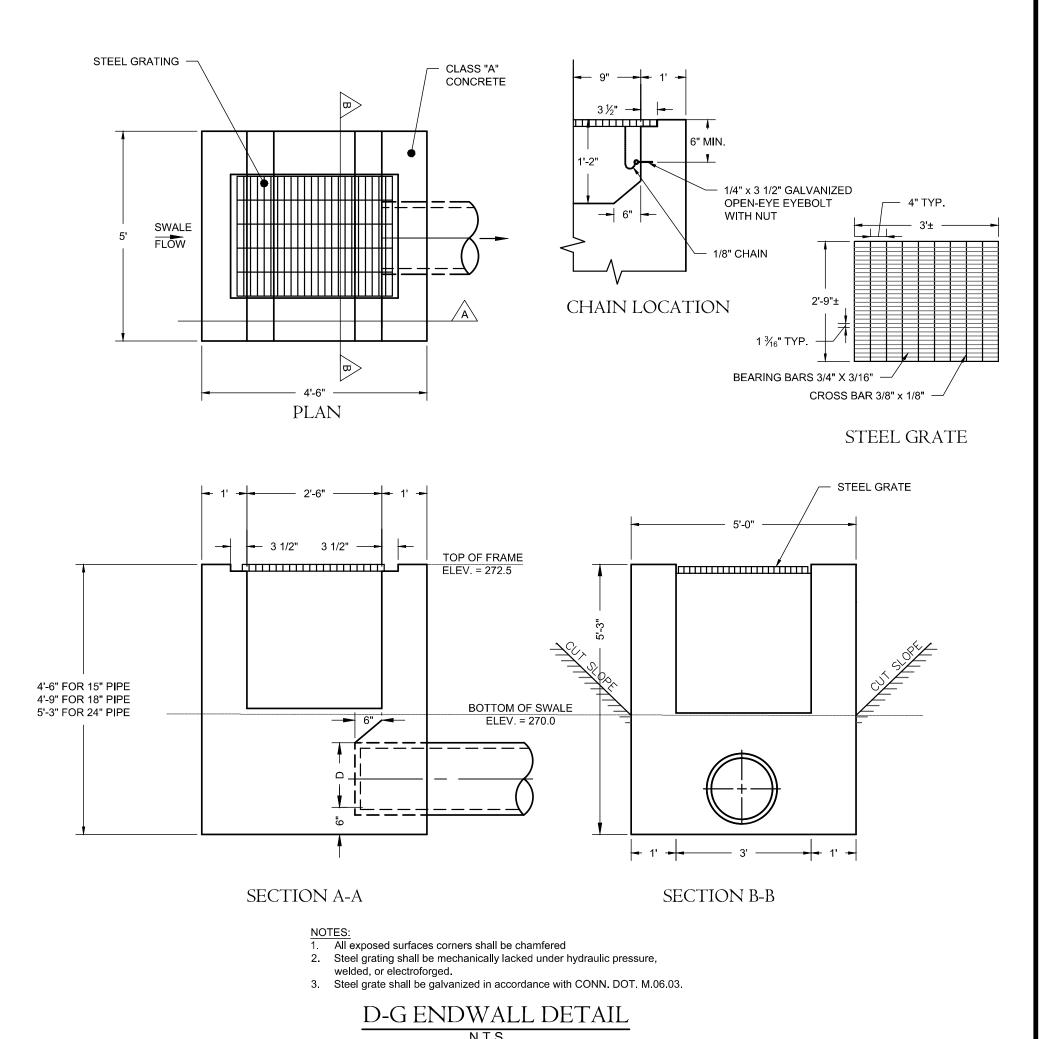

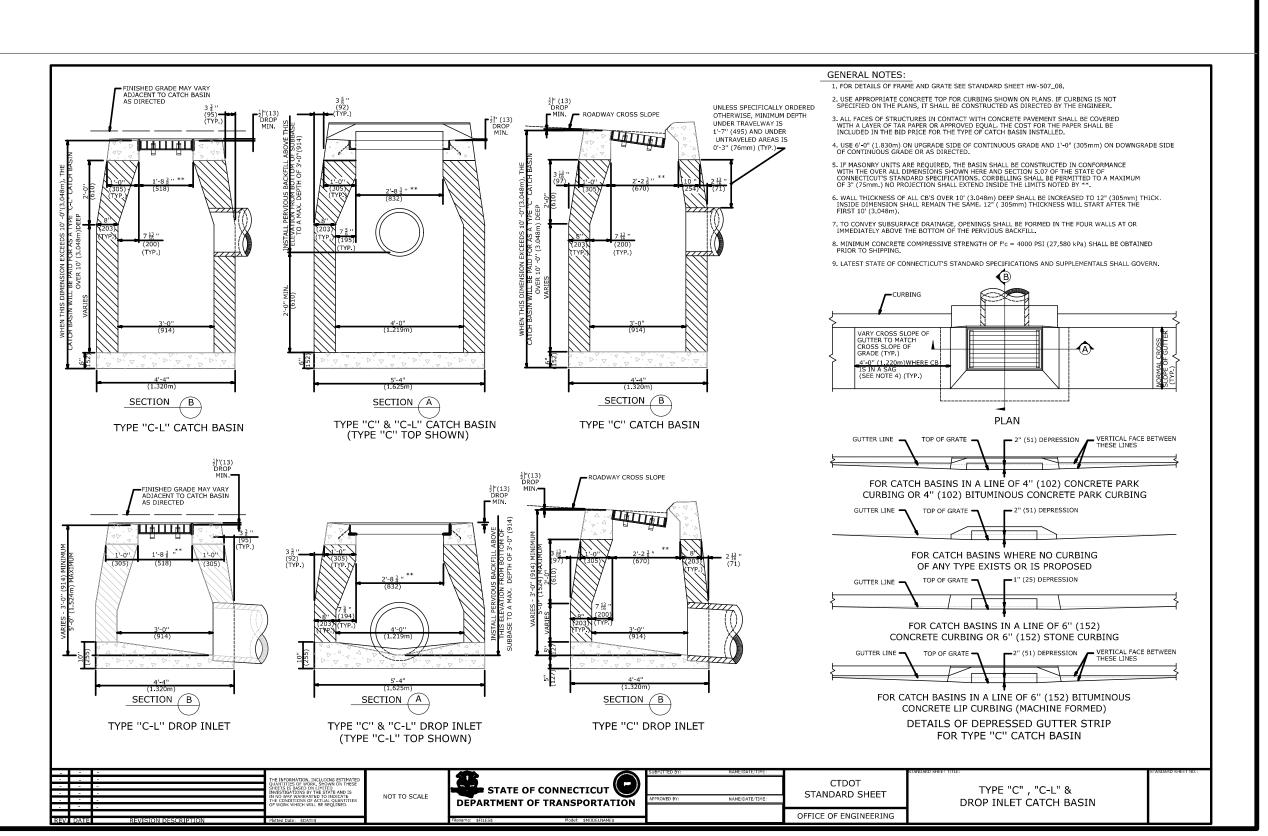



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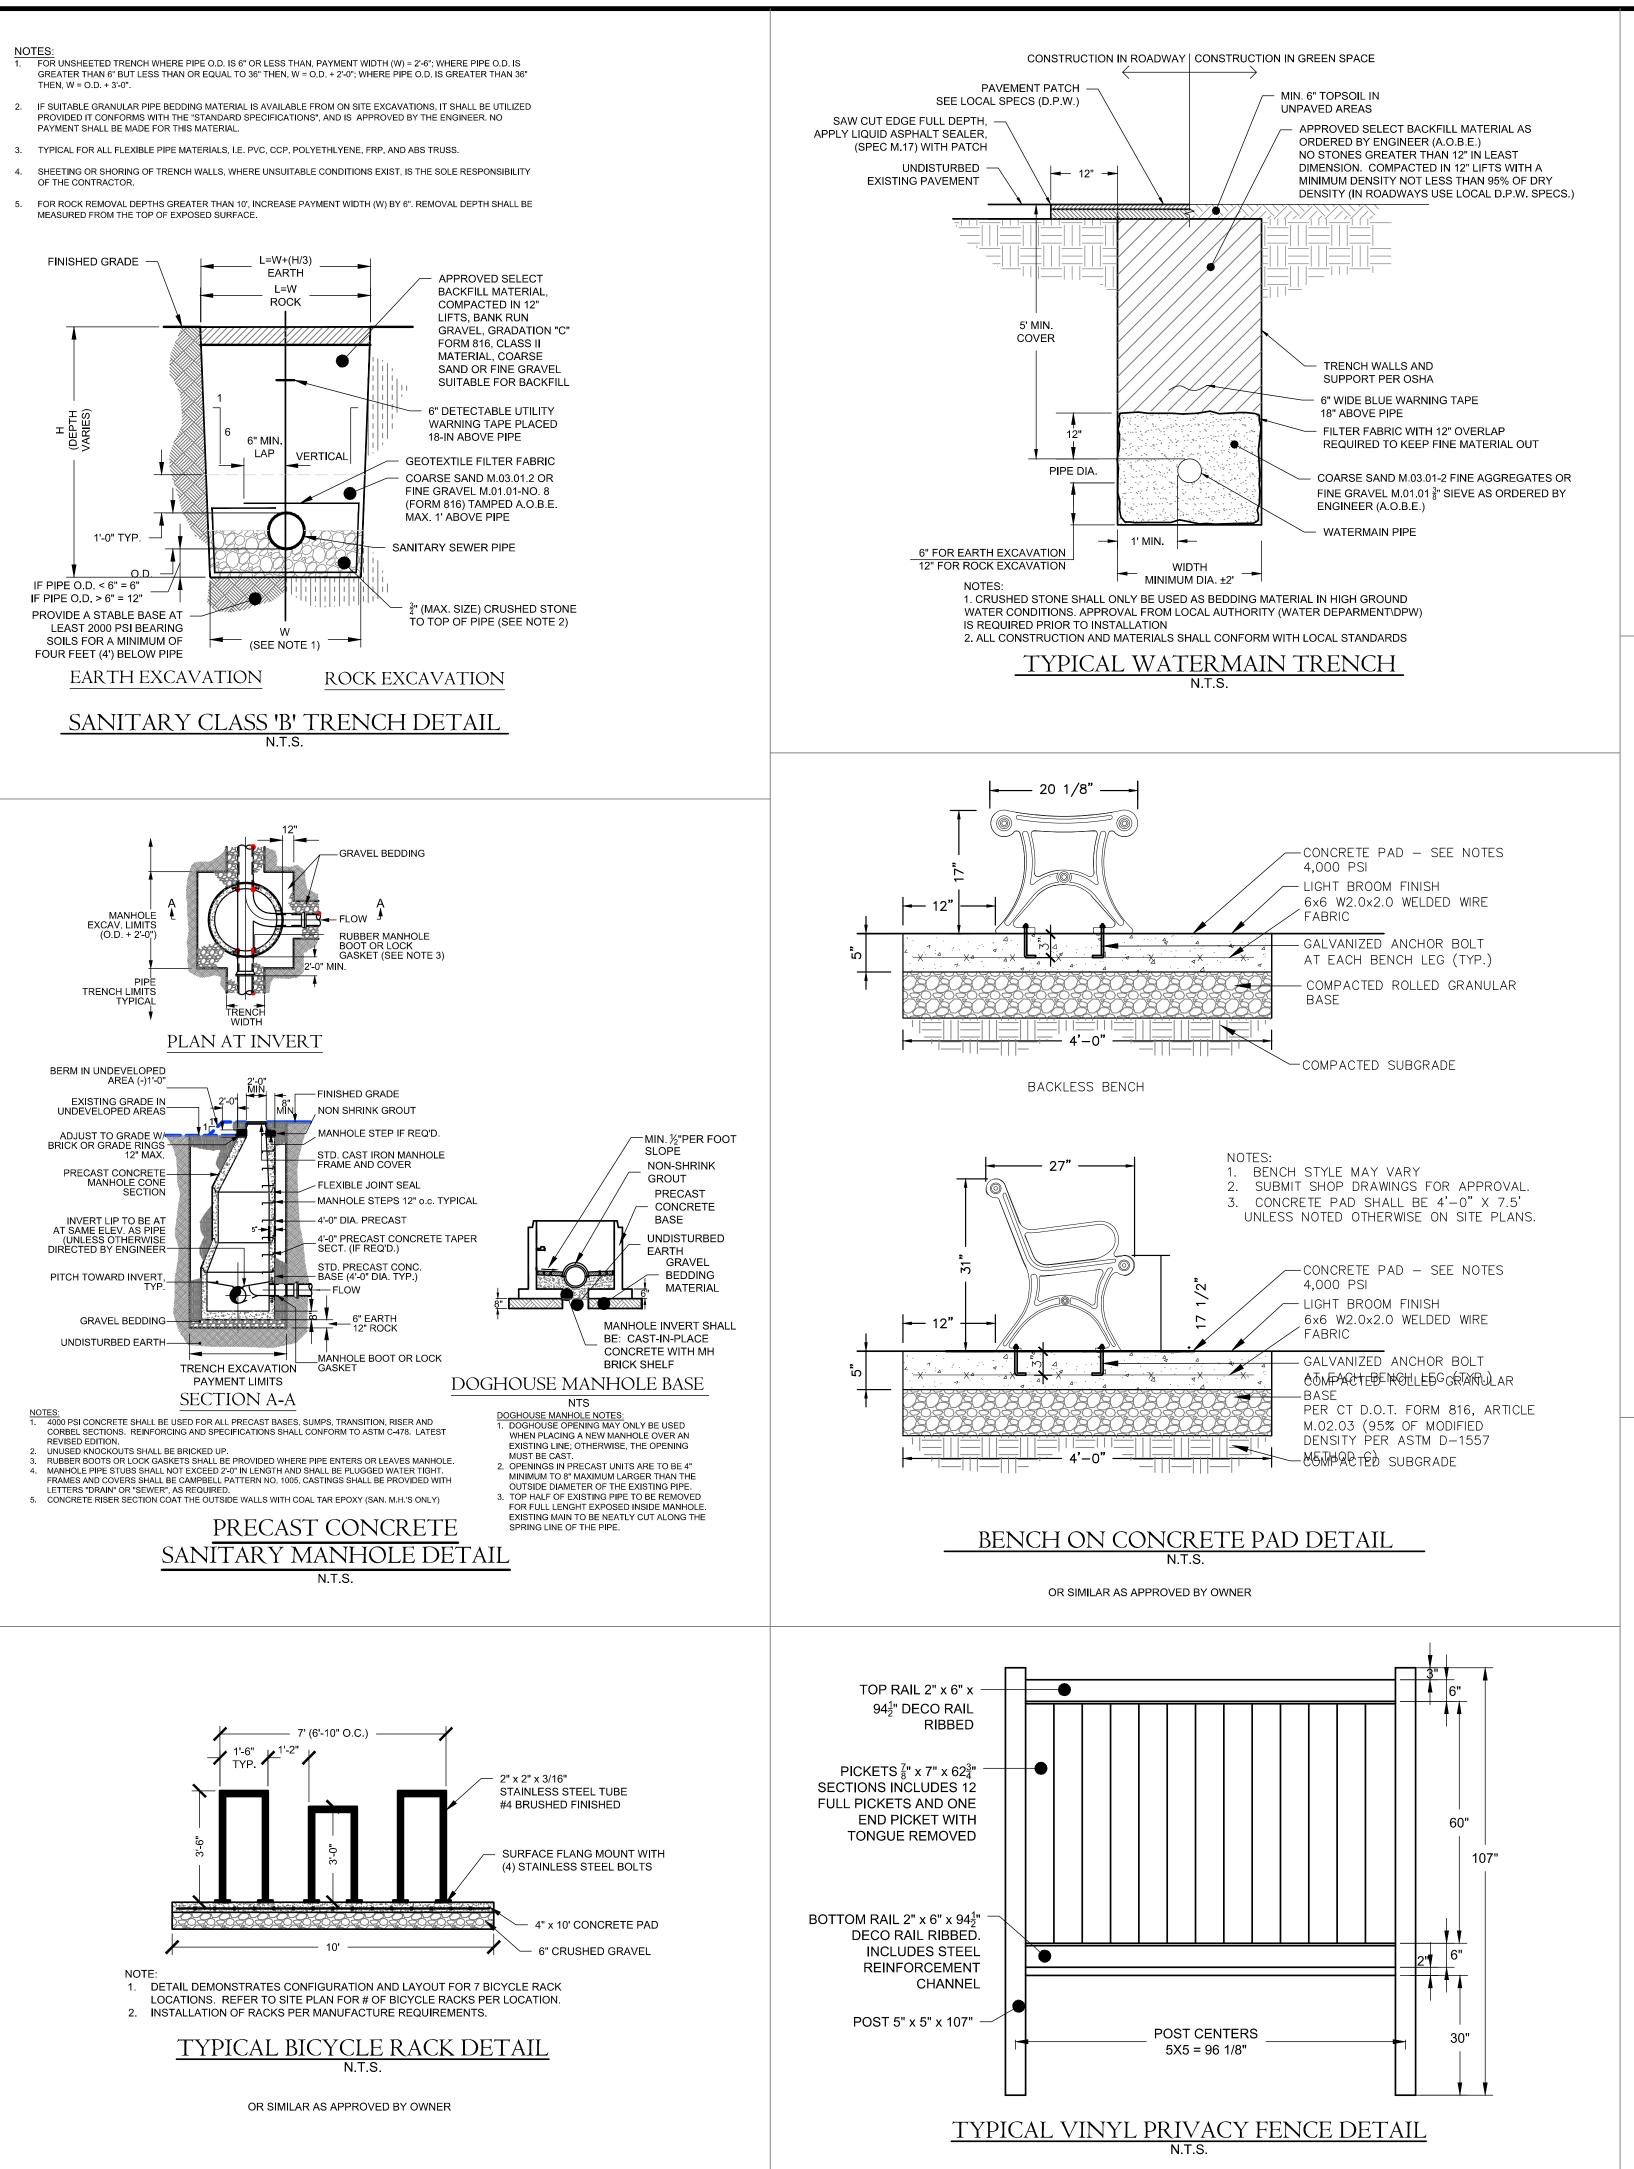
570 Meriden Waterbury Turnpike Southington, Connecticut


PREPARED FOR:


AA DENORFIA BUILDING & DEVELOPMENT


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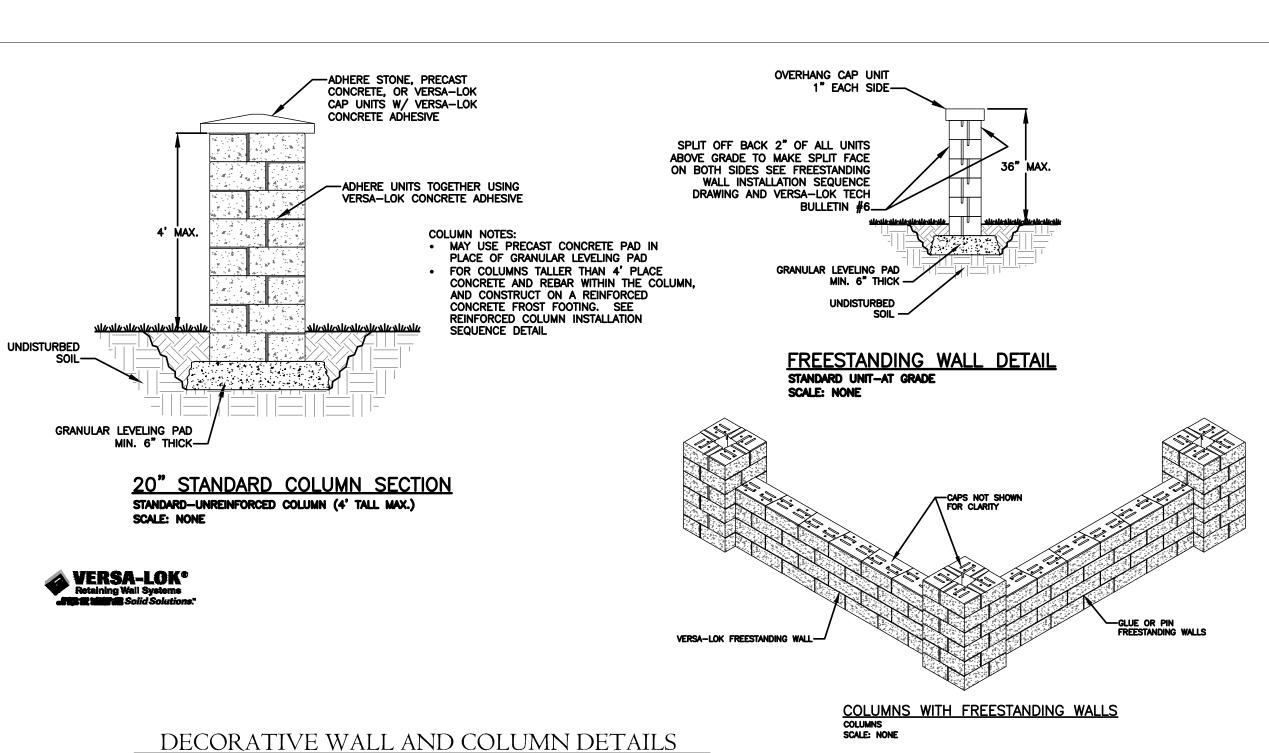
N.T.S. Date: September 1, 2022 F.B. #: ----Approved By: BNB Revisions: Descriptions: Sept. 26, 2022 Revised per Town Comments





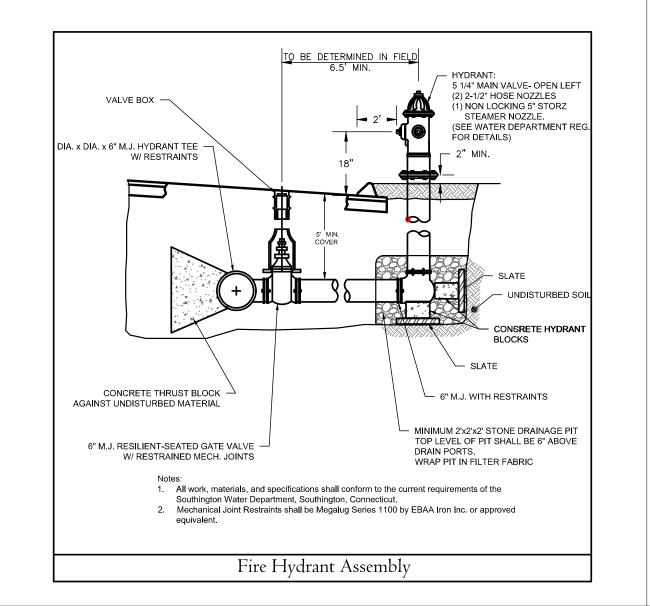

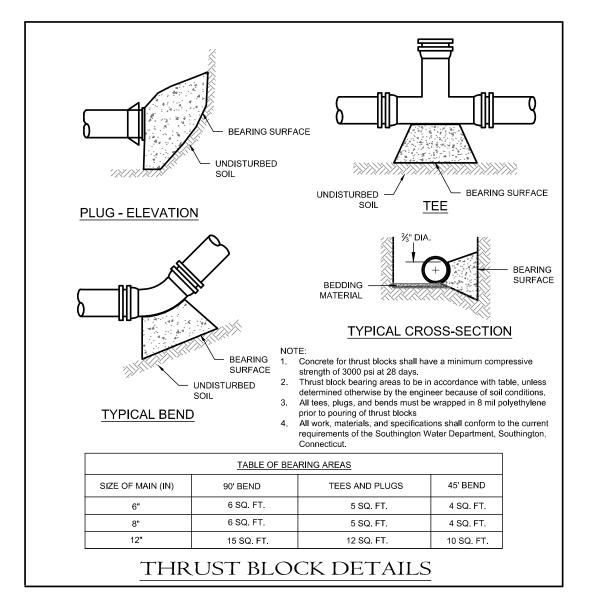

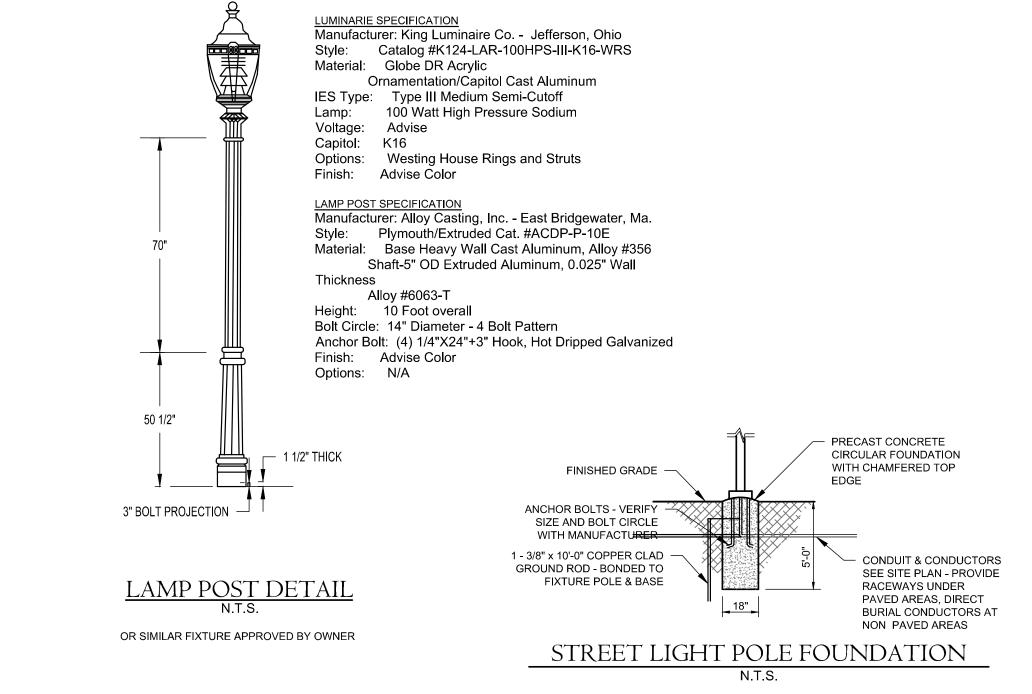

OR SIMILAR AS APPROVED BY OWNER



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570 Meriden Waterbury Turnpike Southington, Connecticut

PREPARED FOR:

AA DENORFIA
BUILDING &
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Scale:

N.T.S.

Date: September 1, 2022

Project #: 2235 F.B. #: --
Drawn By: BTP Approved By: BNB

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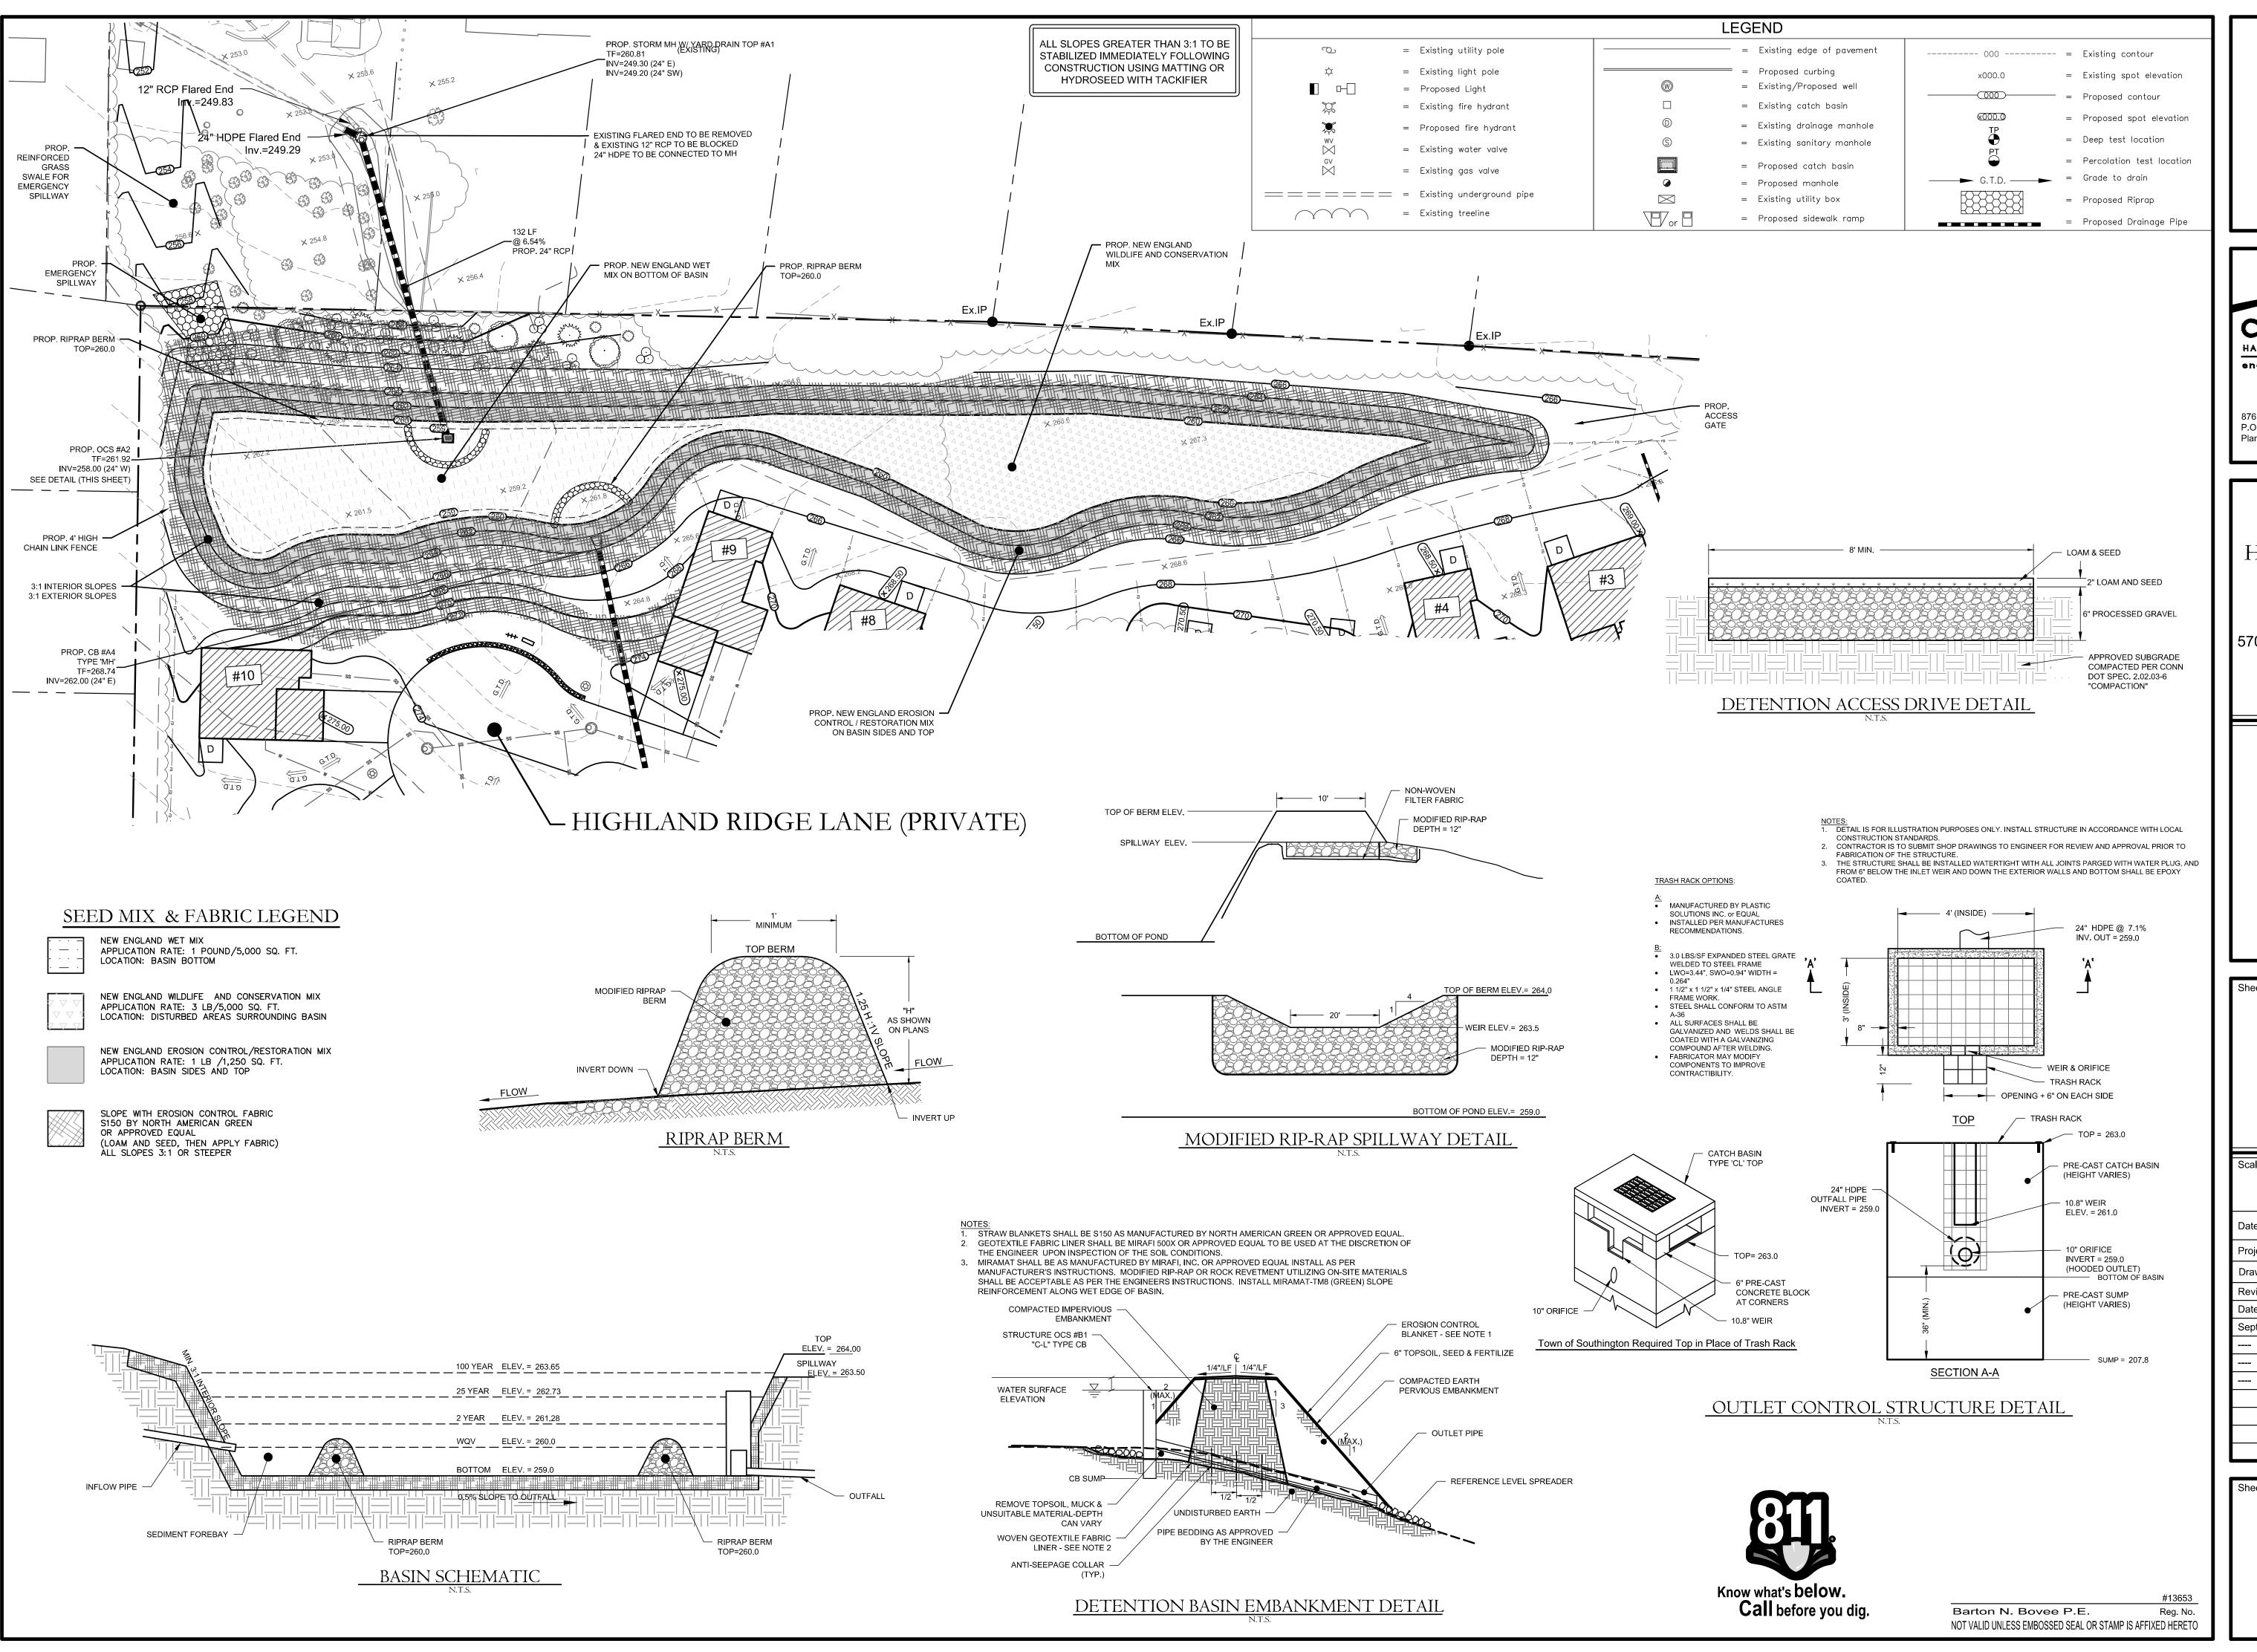
e: Descriptions:


ot. 26, 2022 Revised per Town Comme

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Sheet #:

D3



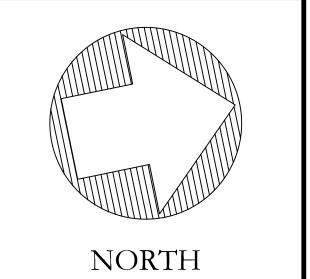

cole HARRY E. COLE & SON engineering. surveying. planning.

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PREPARED FOR:

AA DENORFIA BUILDING & DEVELOPMENT

**Sheet Description:** 

DETENTION BASIN DETAILS

