


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Highland Ridge Active Adult Community

580 Meriden Waterbury Turnpike
Southington, Connecticut

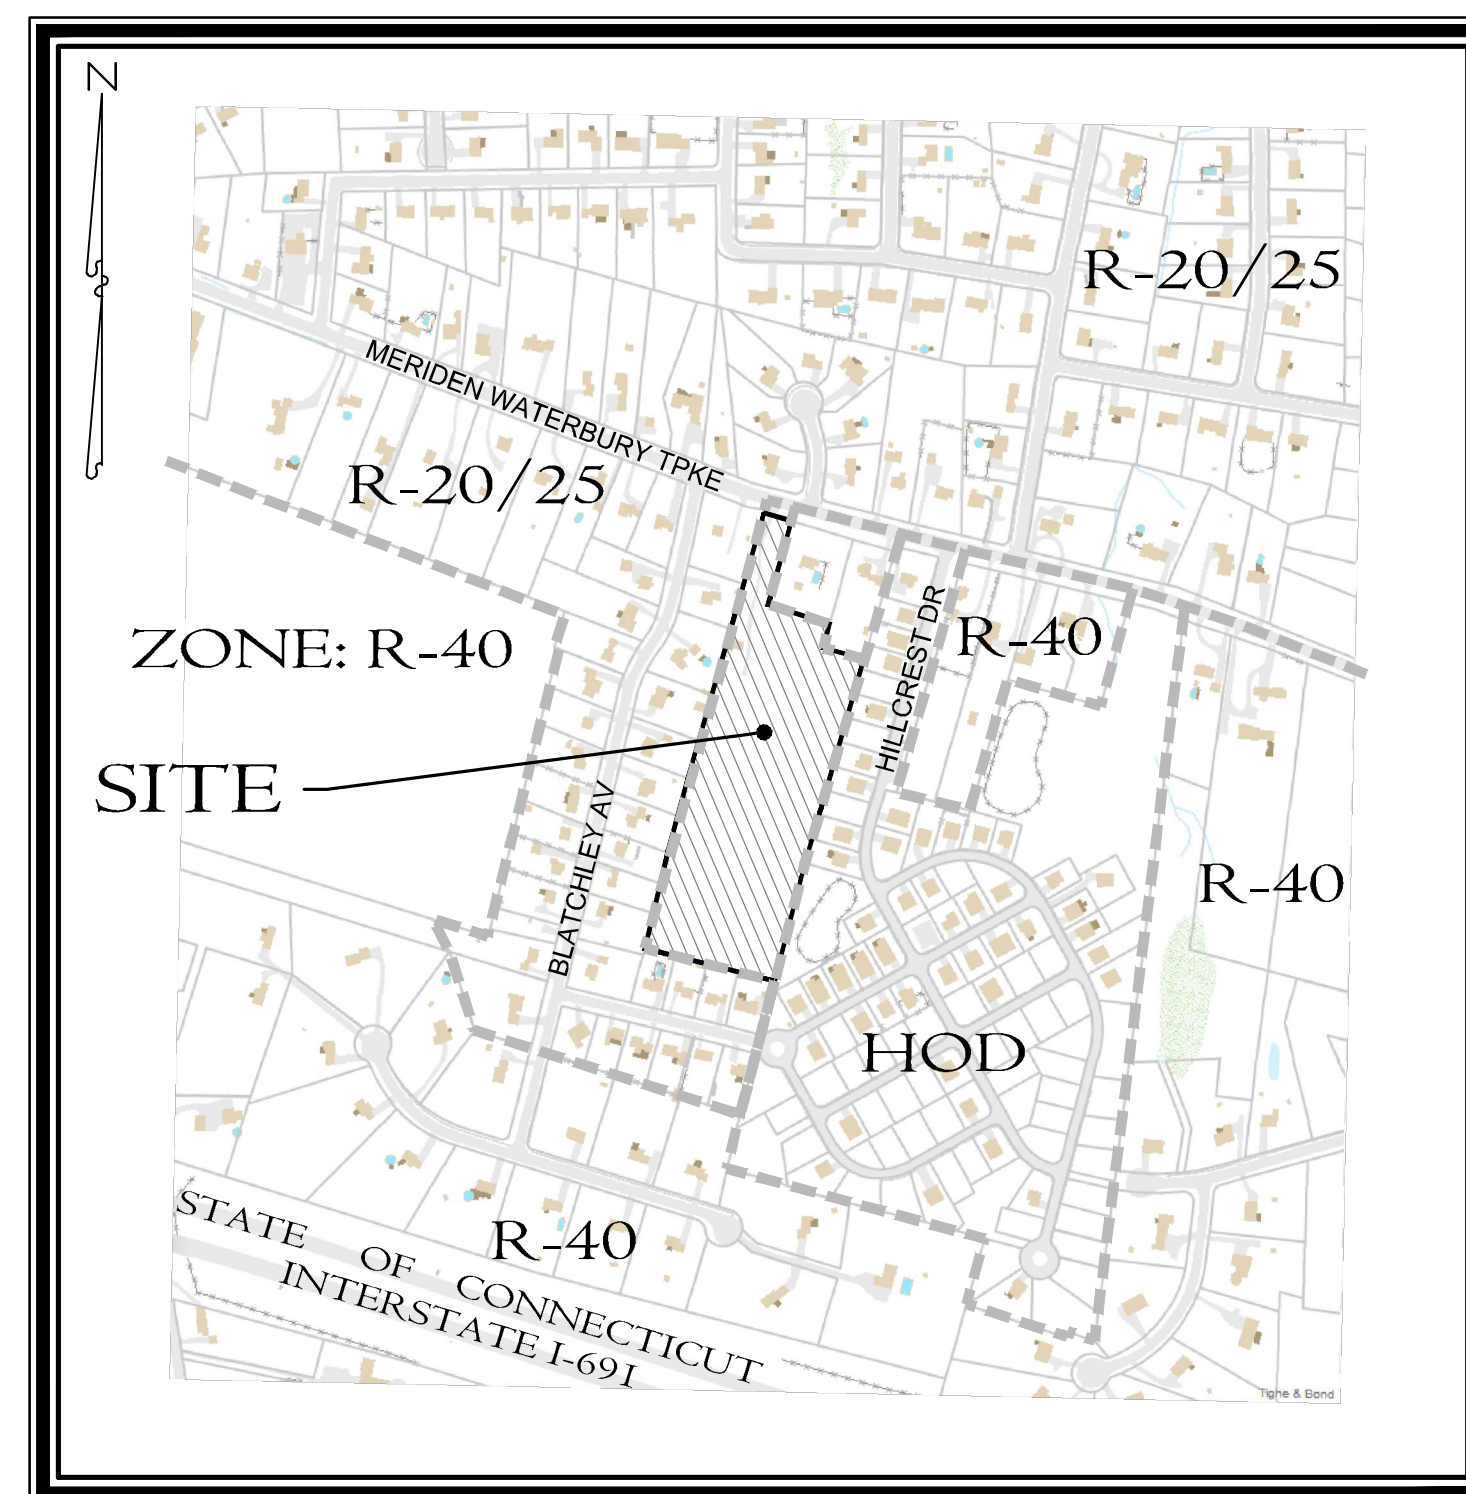

KEY MAP

SCALE: 1"=500'

Sheet Index:

S1	Property & Topographic Survey Map
C1	Site Layout & Landscaping Plan
C2	Site Grading & Drainage Plan
C3	Site Sewer & Water Plan
P1	Plan and Profile - Highland Ridge Lane (Private)
ES1	Soil Erosion & Sedimentation Control Plan
D1	Details
D2	Details
D3	Details
DB1	Detention Basin Details

Applicant:

AA Denorfia Building & Development
133 Main Street
Southington, Connecticut

Property Owner:

Cecelia Docar
570 Meriden Waterbury Turnpike
Southington, Connecticut

Consultants:

Engineering & Surveying

Harry E. Cole & Son
P.O. Box 44 - 876 South Main Street
Plantsville, Connecticut 06489
Tel. (860) 628-4484 Fax (860) 620-0196

PREPARED FOR

AA Denorfia Building & Development



September 1, 2022

Revision Table

03	Oct. 31, 2022	Revised per Town Comments (Engineering Department Comments)
02	Oct. 20, 2022	Revised Detention Basin & Water Department Comments
01	Sept. 26, 2022	Revised per Town Comments
	September 1, 2022	First Submittal Set

#2235

BLANCHLEY AVENUE
MERIDEN WATERBURY TURNPIKE
(STATE OF CONNECTICUT - ROUTE 322)

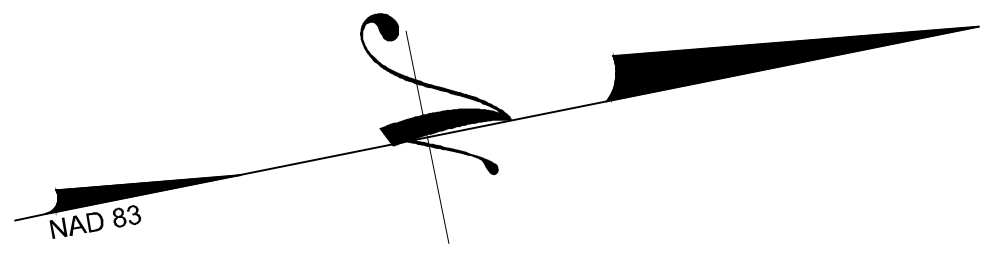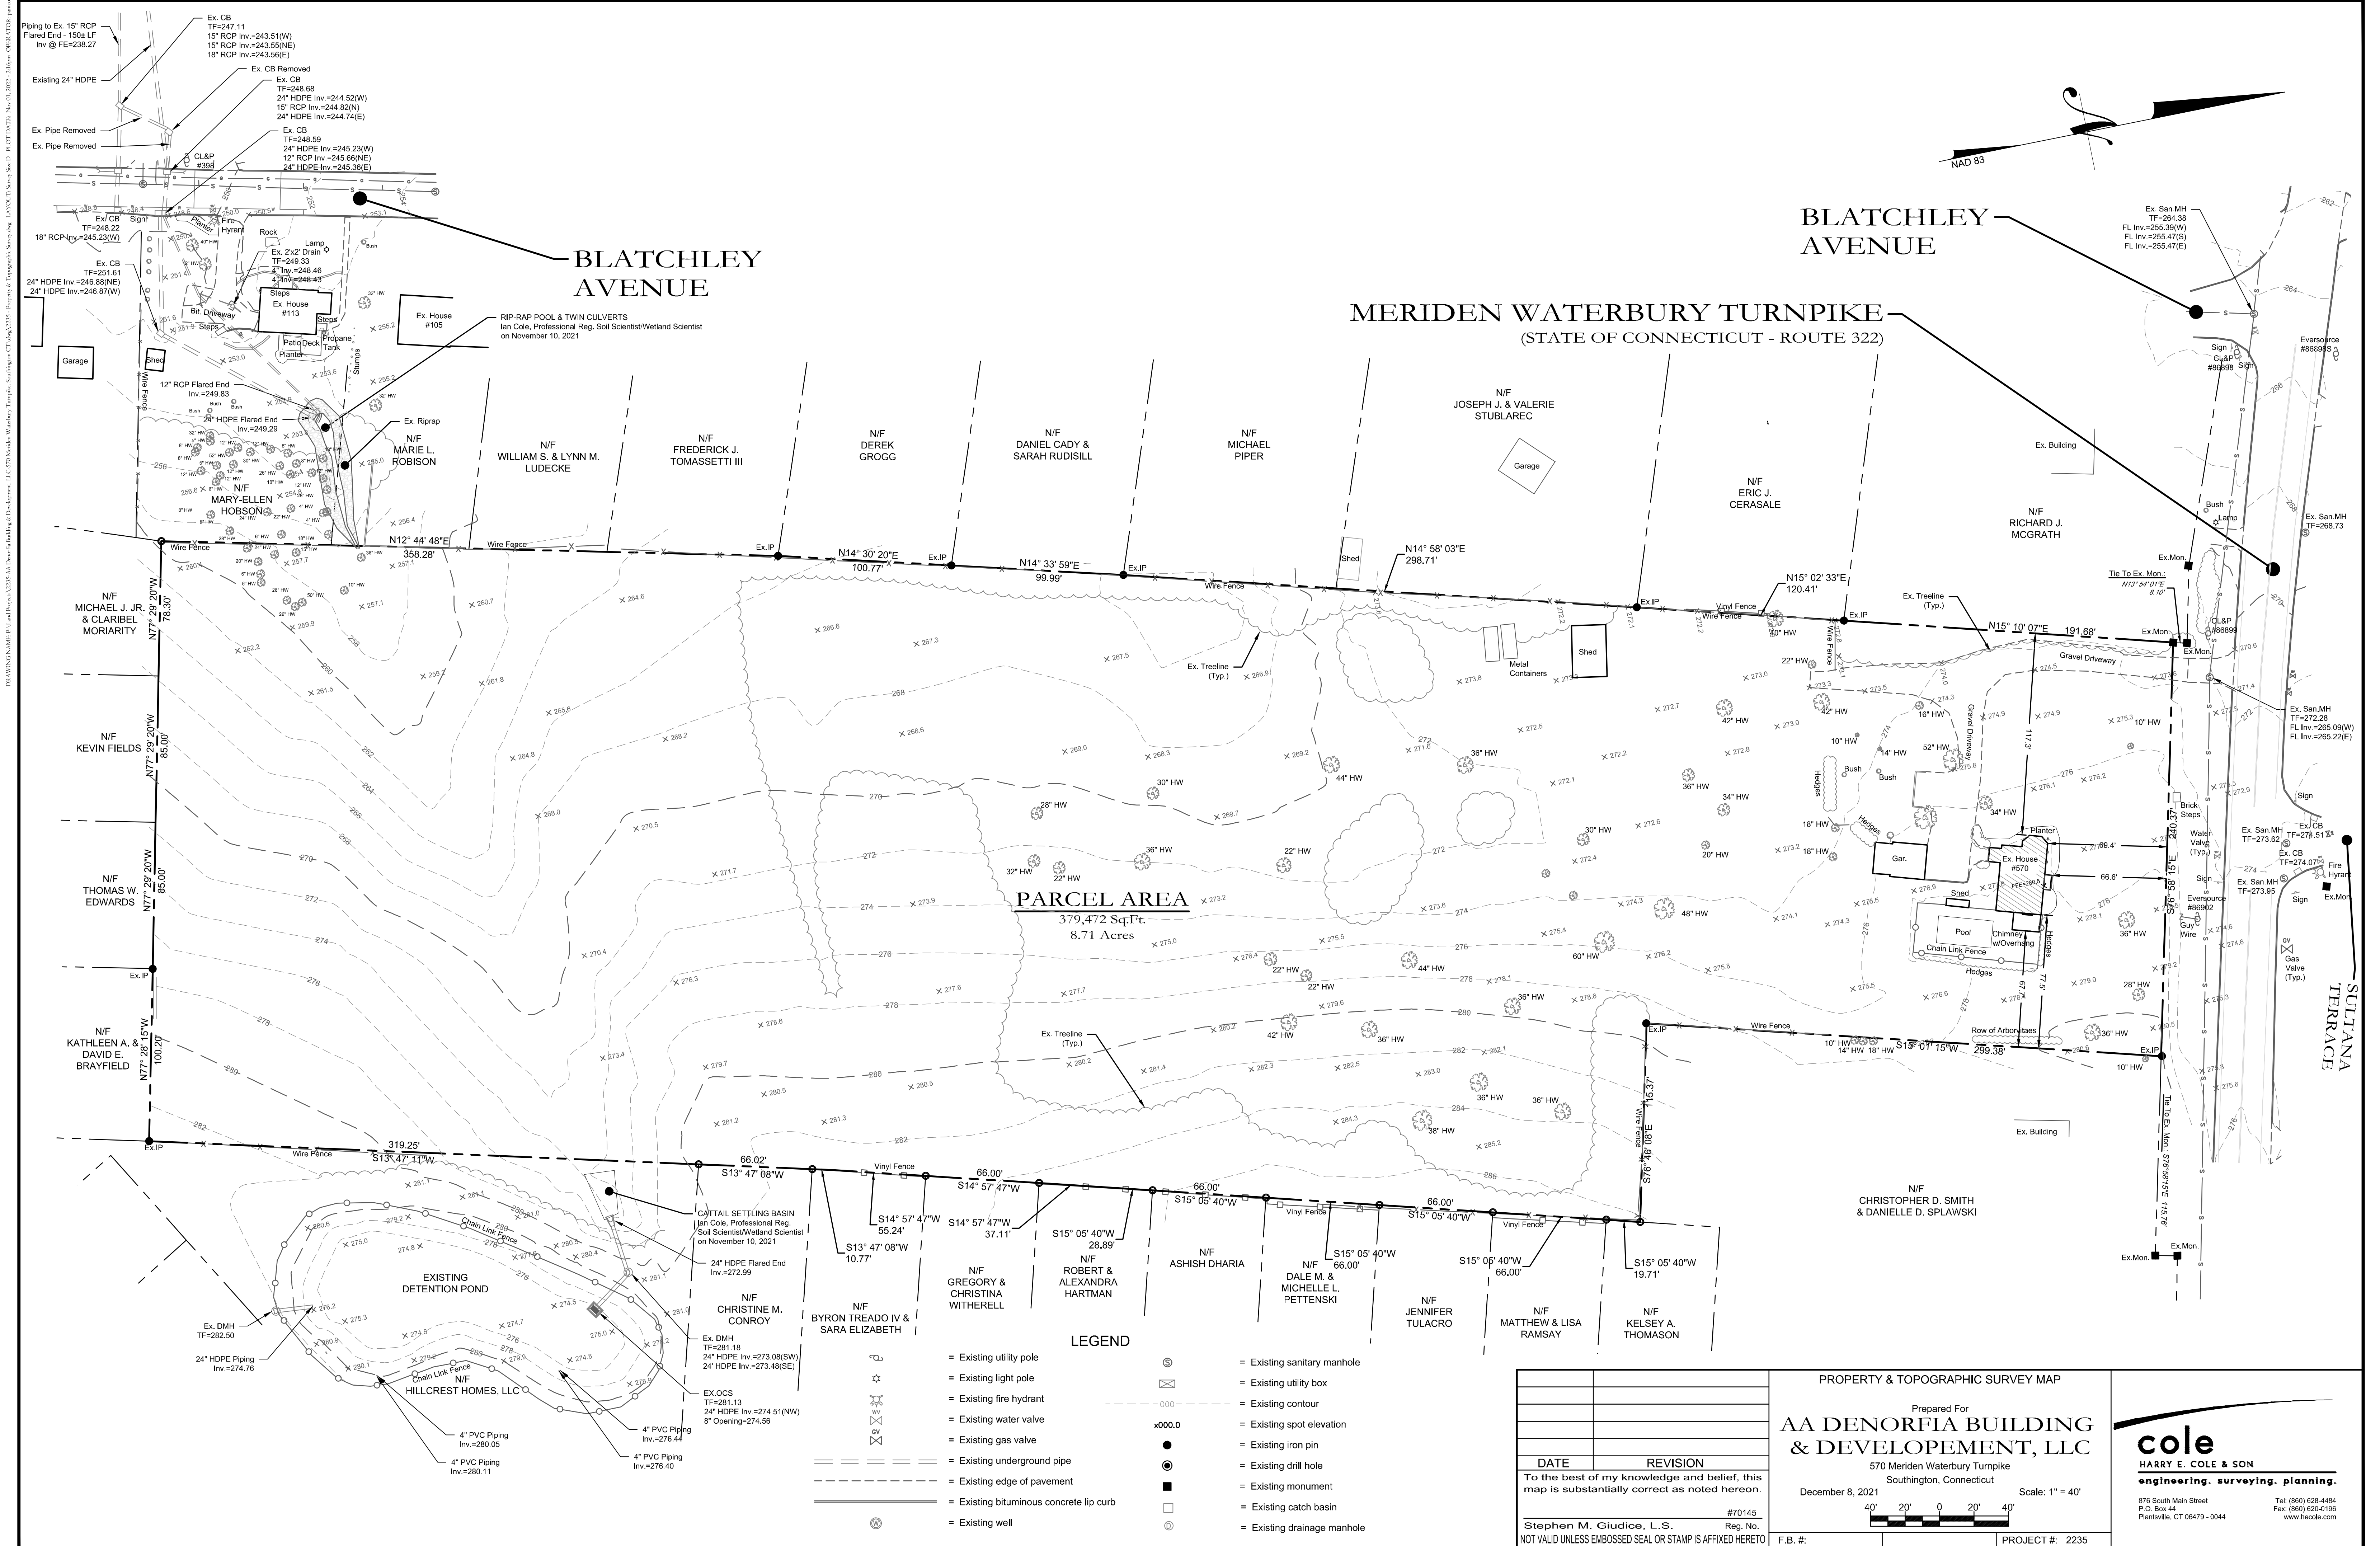

BLATCHLEY AVENUE

MERIDEN WATERBURY TURNPIKE
(STATE OF CONNECTICUT - ROUTE 322)

BLATCHLEY AVENUE

PARCEL AREA
379,472 Sq.Ft.
8.71 Acres

CATTLE SETTLING BASIN
Ian Cole, Professional Reg. Soil Scientist/Wetland Scientist
on November 10, 2021

EXISTING DETENTION POND

LEGEND

- Existing utility pole
Existing sanitary manhole
Existing light pole
Existing utility box
Existing fire hydrant
Existing contour
Existing water valve
Existing spot elevation
Existing gas valve
Existing iron pin
Existing underground pipe
Existing drill hole
Existing edge of pavement
Existing monument
Existing bituminous concrete lip curb
Existing catch basin
Existing well
Existing drainage manhole

Table with 2 columns: DATE, REVISION. Includes signature of Stephen M. Giudice, L.S. and registration information.

PROPERTY & TOPOGRAPHIC SURVEY MAP
Prepared For
AA DENORFIA BUILDING & DEVELOPMENT, LLC
7570 Meriden Waterbury Turnpike
Southington, Connecticut
December 8, 2021
Scale: 1" = 40'

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HARRY E. COLE & SON
engineering. surveying. planning.
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Tel: (860) 628-4484
Fax: (860) 628-0196
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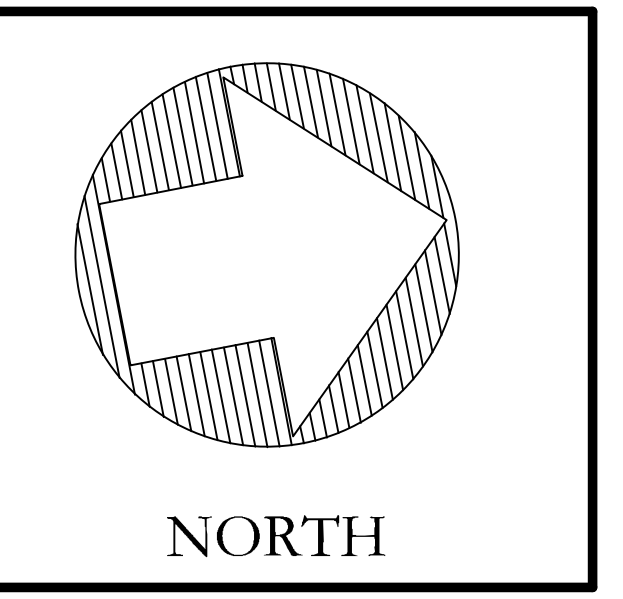
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PLANT LIST				
SYM.	QTY.	SCIENTIFIC NAME	COMMON NAME	CONDITION
STREET TREES				
[Symbol]	22	ACER RUBRUM	RED MAPLE	8 FEET IN HEIGHT & 2.5" CALIPER
		PRUNUS AMERICANA	AMERICAN PLUM	
		PRUNUS SARGENTII (flowering)	SARGENT CHERRY	
		TILIA CORDATA	LITTLE LEAF LINDEN	


PLANT LIST				
SYM.	QTY.	SCIENTIFIC NAME	COMMON NAME	CONDITION
STREET SHADE TREES				
[Symbol]	3	ACER RUBRUM	RED MAPLE	2" CALIPER
		ACER SACCHARUM	SUGAR MAPLE	
		PRUNUS AMERICANA	AMERICAN PLUM	
		PRUNUS SARGENTII (flowering)	SARGENT CHERRY	
SCREENING TREES				
[Symbol]	5	CUPRESSUS X LEYLANDII	LEYLAND CYPRESS	6 FT
		PICEA RUBENS	RED SPRUCE	6 FT
		TSUGA CANADENSIS	EASTERN HEMLOCK	6 FT
SHRUBS				
[Symbol]	20	ILEX VERTICILLATA	COMMON WINTERBERRY	8&B, 18-24" HT.
		ARONIA ARBUTIFOLIA	RED CHOKEBERRY	3 GAL, HEAVY, FULL
		RHODODENDRON CANADENSE	RHODODERON	3 GAL, HEAVY, FULL
		VIBURNUM CASSINOIDES	WITHERED VIBURNUM	3 GAL, HEAVY, FULL
		VACCINIUM CORYMBOSUM	HIGHBUSH BLUEBERRY	2-3 FT
		JUNIPERUS COMMUNIS	COMMON JUNIPER	2-3 FT

LEGEND

[Symbol]	= Existing utility pole	[Symbol]	= Existing edge of pavement	[Symbol]	= Existing contour
[Symbol]	= Existing light pole	[Symbol]	= Proposed curbing	[Symbol]	= Existing spot elevation
[Symbol]	= Proposed Light	[Symbol]	= Existing/Proposed well	[Symbol]	= Existing contour
[Symbol]	= Existing fire hydrant	[Symbol]	= Existing catch basin	[Symbol]	= Proposed spot elevation
[Symbol]	= Proposed fire hydrant	[Symbol]	= Existing drainage manhole	[Symbol]	= Proposed contour
[Symbol]	= Existing water valve	[Symbol]	= Existing sanitary manhole	[Symbol]	= Deep test location
[Symbol]	= Existing gas valve	[Symbol]	= Existing catch basin	[Symbol]	= Percolation test location
[Symbol]	= Existing underground pipe	[Symbol]	= Proposed manhole	[Symbol]	= Grade to drain
[Symbol]	= Existing treeline	[Symbol]	= Existing utility box	[Symbol]	= Proposed Riprap
[Symbol]		[Symbol]	= Proposed sidewalk ramp	[Symbol]	= Proposed Drainage Pipe




- STREET TREES REQUIRE MIN. OF 2.5" CALIPER. STREET TREE LOCATIONS ARE INDICATED ON THE PLAN.
- THERE SHALL BE 1 TREE PER 50 FEET OF ROADWAY (SPREAD TREES OUT TO APPROX. 50 FT ON CENTER)
- 1,100 FEET OF ROADWAY = 22 TREES
- THE ABOVE LIST DOES NOT INCLUDE ANY SPECIES LISTED ON THE CONNECTICUT INVASIVE PLANT LIST AND NO PLANT ON THIS LIST SHALL BE PLANTED ON SITE.

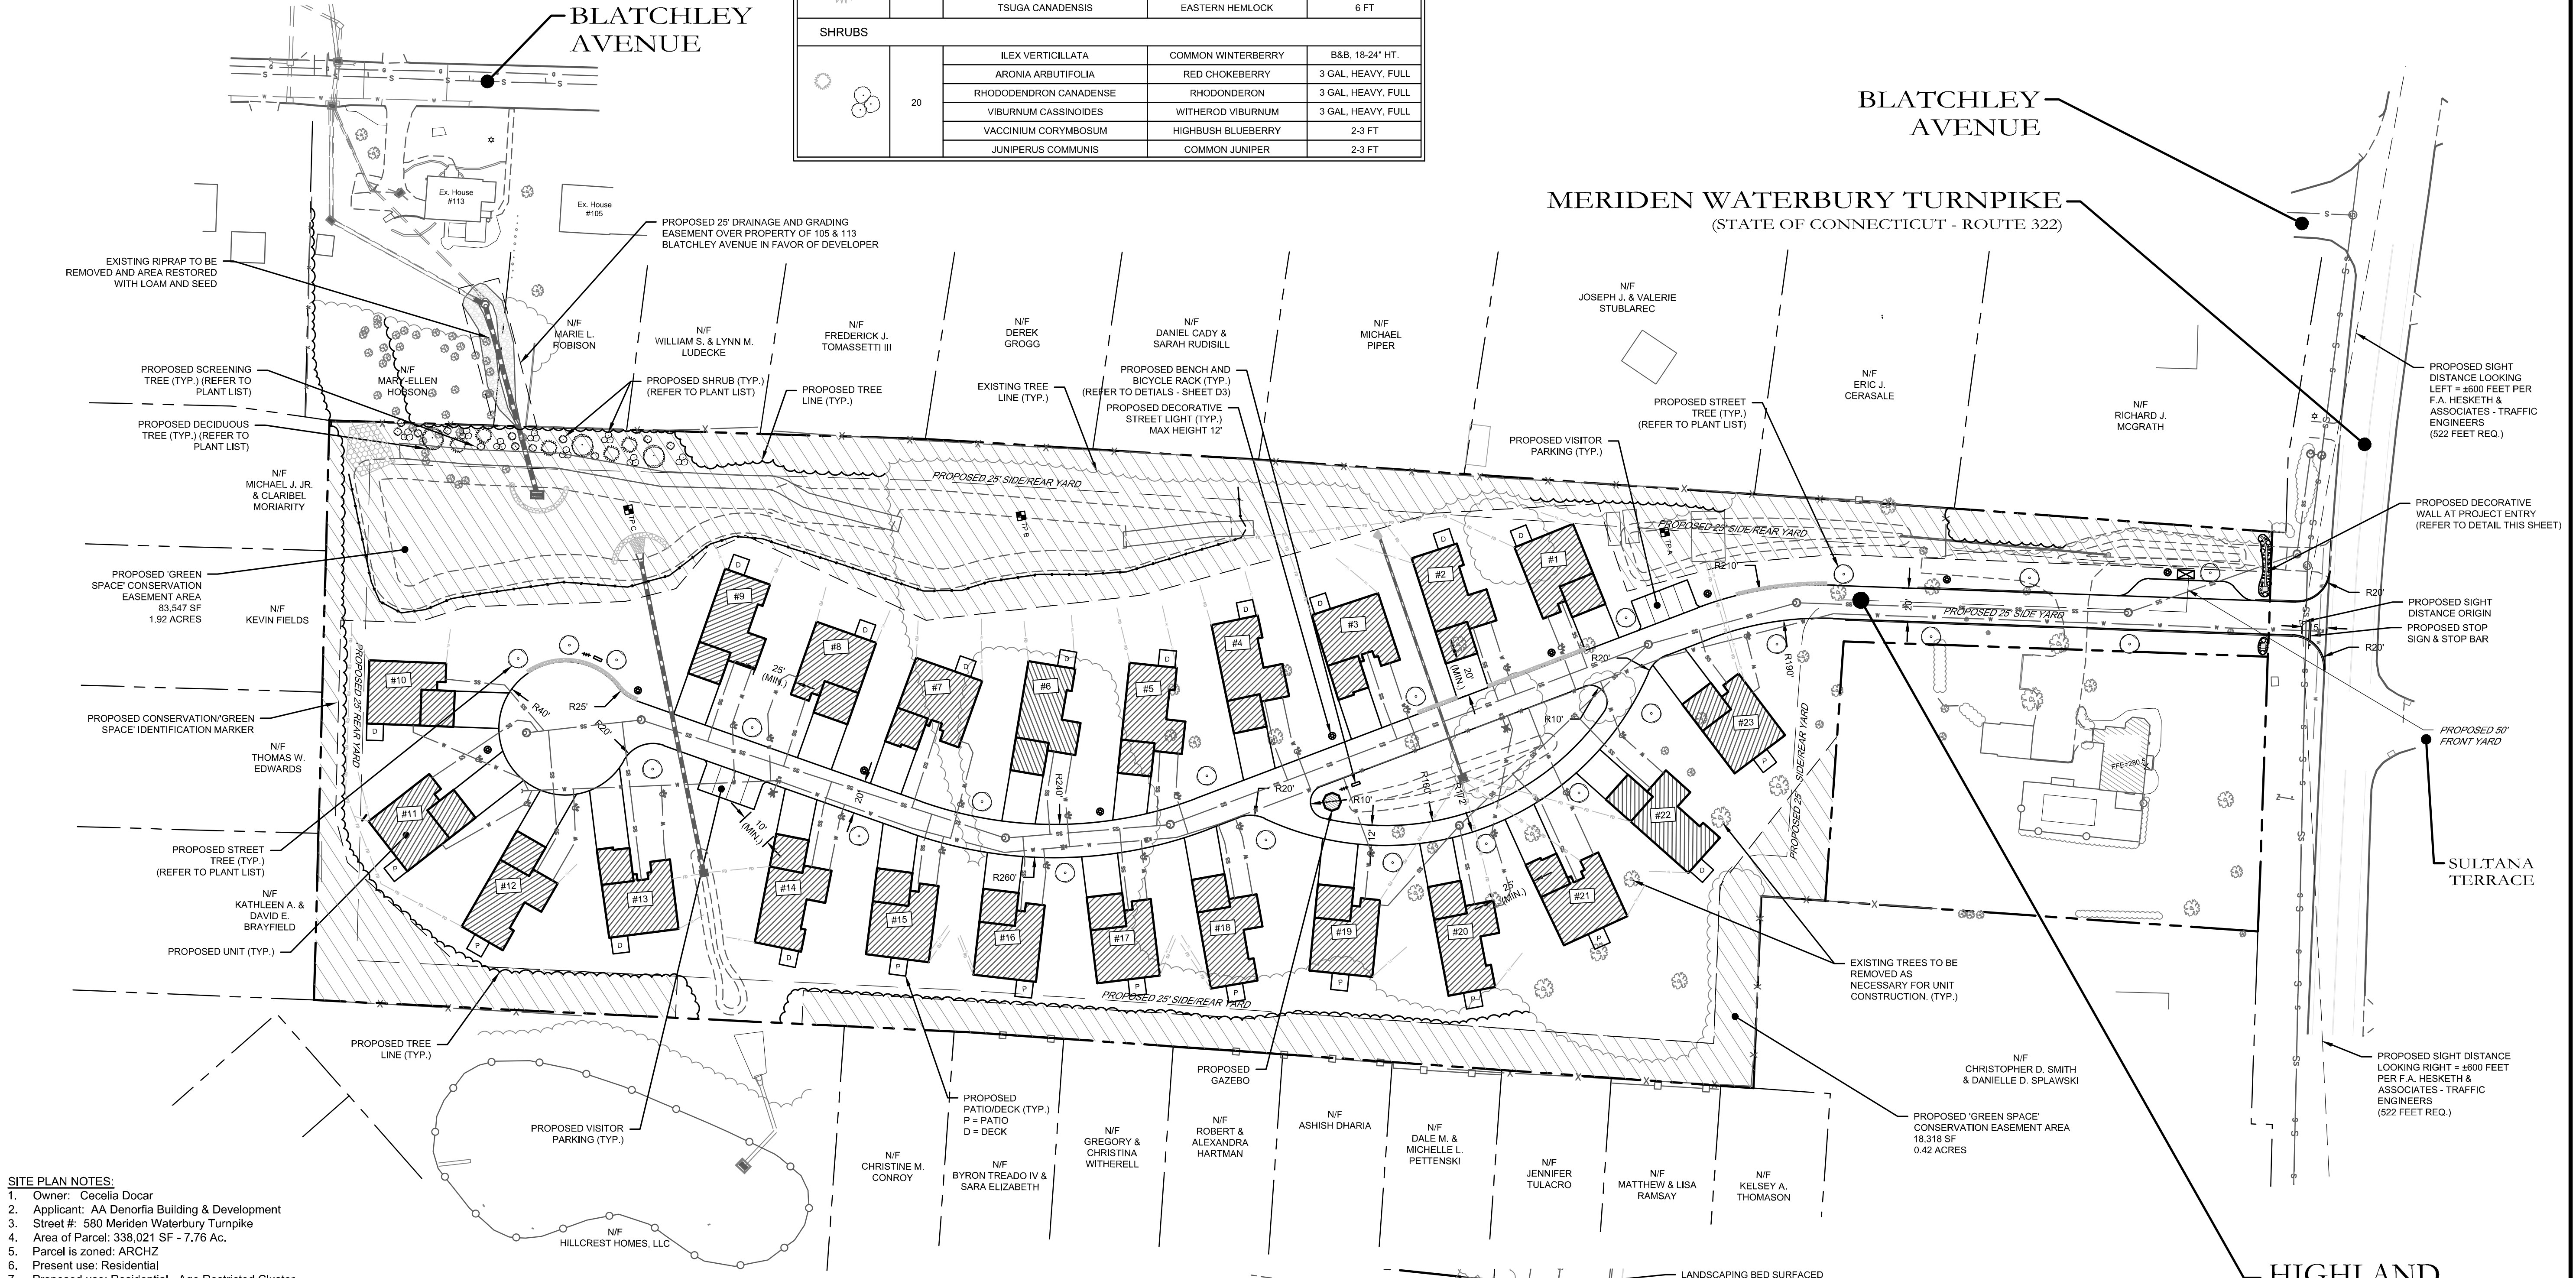

- #### SITE PLAN NOTES:
- Owner: Cecelia Docar
 - Applicant: AA Denorfia Building & Development
 - Street #: 580 Meriden Waterbury Turnpike
 - Area of Parcel: 338,021 SF - 7.76 Ac.
 - Parcel is zoned: ARCHZ
 - Present use: Residential
 - Proposed use: Residential - Age Restricted Cluster
 - No Wetlands are present per the Town of Southington Wetland Map.
 - Site to be serviced by town water and sewer.
 - All work in connection with this plan shall be completed within five years of the date of approval, or the approval is no longer valid.
 - Erosion and Sedimentation control shall conform to the "Connecticut Guidelines for Soil Erosion and Sediment Control" dated May 2002, and amended to date.
 - All site work shall conform to specifications as outlined in C.D.O.T. Form 818, dated 2020 and amended to date.
 - Any regulated activity in a designated Inland Wetland not a part of this plan shall require a separate Inland Wetland Permit.
 - All areas disturbed by construction to be restored with 4" of loam and seeded.
 - All exterior light fixtures shall be low intensity LED, Dark Sky Compliant, fully shielded fixtures. Light poles shall have a maximum height of 12 feet.
 - All Catch Basins/Inlets shall be cleaned prior to occupancy.
 - Underground fuel tanks are prohibited.
 - Town of Southington Planning and Engineering Departments to be notified at (860)-276-6248 and (860)-276-6231, 24 hours before site grading begins.
 - Prior to any excavation, contractor to notify "CALL BEFORE YOU DIG," 1-800-922-4455.
 - All existing utilities are from best available information, contractor to verify all locations, dimensions, and elevations prior to construction. Notify Engineer of any discrepancies.
 - No floor drains are proposed. Floor drains are not allowed without obtaining Connecticut DEEP permits.
 - Building permit required for construction of retaining walls over 3-ft tall. Design of retaining walls shall be provided by structural/geotechnical engineer prior to construction of walls.
 - All refuse to be collected by private company and all refuse containers to be store inside of units.

ZONING INFORMATION		
ITEM	REQUIRED	PROVIDED
ZONE	ARCHZ	ARCHZ
PROPOSED USE	Age Restricted Cluster Housing	Age Restricted Cluster Housing
LOT AREA	5 Acres	7.76 Acres
LOT FRONTAGE	75 ft	75 ft
FRONT YARD SETBACK	50 ft	> 100 ft
SIDE & REAR YARD SETBACK	25 ft	25.25 ft
MAX. BUILDING HEIGHT	32 ft	< 32 ft
MAX. IMPERVIOUS COVERAGE	50%	< 50%
MAX. DENSITY	5 Units per Acre	< 3 Units per Acre
GREEN SPACE	20% (1.72 Acres)	30% (2.34 Acres)

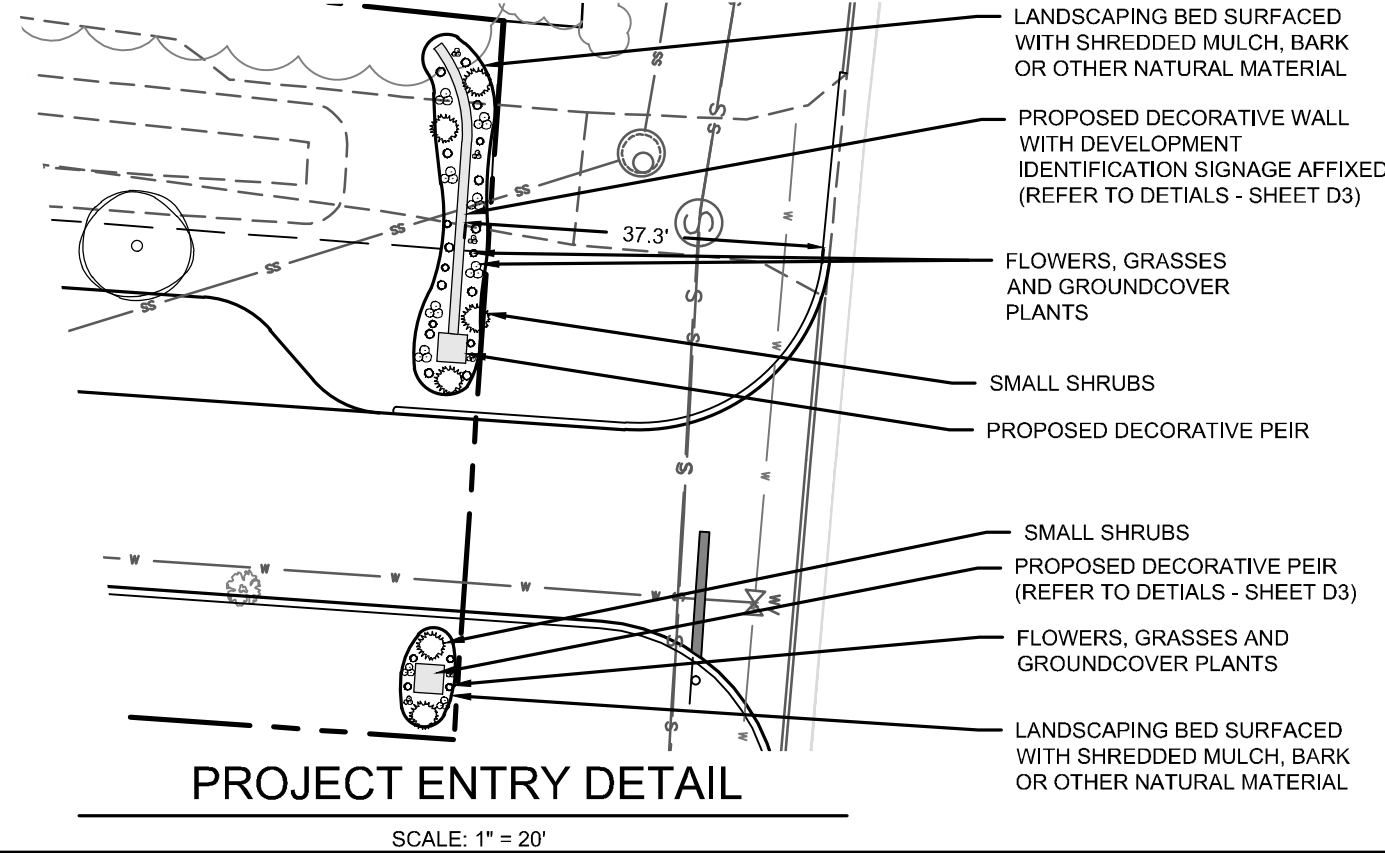

#13653
Barton N. Bovee P.E. Reg. No.
NOT VALID UNLESS EMBOSSED SEAL OR STAMP IS AFFIXED HERETO

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engineering. surveying. planning.

876 South Main Street Tel: (860) 628-4484
P.O. Box 44 Fax: (860) 620-0196
Plainville, CT 06479 - 0044 www.heccole.com

PROJECT NAME:
HIGHLAND RIDGE ACTIVE ADULT COMMUNITY

580 Meriden Waterbury Turnpike
Southington, Connecticut

PREPARED FOR:
AA DENORFIA BUILDING & DEVELOPMENT

Sheet Description:
SITE LAYOUT & LANDSCAPING

Scale: 1"=50'
50' 25' 0' 25' 50'

Date: September 1, 2022	Project #: 2235	F.B. #:
Drawn By: BTP	Approved By: BNB	
Revisions:		
Date:	Descriptions:	
Sept. 26, 2022	Revised per Town Comments	
Oct. 20, 2022	Revised Detention Basin & Water	
Oct. 31, 2022	Revised per Town Comments	
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Sheet #:
C1



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UNIT #	CONCEPTUAL ELEVATIONS		
	FINISHED FLOOR	GARAGE SLAB	BASEMENT SLAB
1	274.5	273.0	265.5
2	275.5	272.0	266.5
3	275.5	274.0	266.5
4	277.5	276.0	268.5
5	279.5	278.0	270.5
6	279.5	278.0	270.5
7	278.0	276.5	269.0
8	277.7	276.2	268.7
9	275.5	275.0	267.2
10	276.5	275.0	267.2
11	278.5	277.0	269.2
12	278.5	277.0	269.2
13	277.5	276.0	268.2
14	279.5	278.0	270.2
15	280.5	279.0	271.2
16	281.5	280.0	272.2
17	281.5	280.0	272.2
18	281.5	280.0	272.2
19	281.5	280.0	272.2
20	283.5	282.0	274.2
21	281.5	280.0	272.2
22	279.5	278.0	270.2
23	275.5	274.0	266.5

THE DEPICTED HOUSES AND ASSOCIATED ELEVATIONS ARE CONCEPTUAL ONLY. ADJUSTMENTS TO THE HOUSE LOCATION, SIZE AND SHAPE MAY REQUIRE ADJUSTMENTS TO THE ELEVATIONS. DISREGARD ELEVATIONS IN THE BASEMENT MAY NECESSITATE ADJUSTMENTS TO THE BASEMENT SLAB ELEVATION. FURTHERMORE HOUSE DESIGN, PLACEMENT AND SIZE EXPLORATION MAY NECESSITATE CHANGES TO THE ELEVATION OF THE BASEMENT. EACH LOT WILL REQUIRE AN INDIVIDUAL PLOT PLAN DEPICTING THE FINAL HOUSE DESIGN AND ELEVATIONS.

LEGEND

	= Existing utility pole		= Existing edge of pavement
	= Existing light pole		= Proposed curbing
	= Proposed Light		= Existing/Proposed well
	= Existing fire hydrant		= Existing catch basin
	= Proposed fire hydrant		= Existing drainage manhole
	= Existing water valve		= Proposed spot elevation
	= Existing gas valve		= Proposed contour
	= Existing underground pipe		= Proposed spot elevation
	= Existing treeline		= Deep test location
			= Percolation test location
			= Grade to drain
			= Proposed Riprap
			= Proposed Drainage Pipe

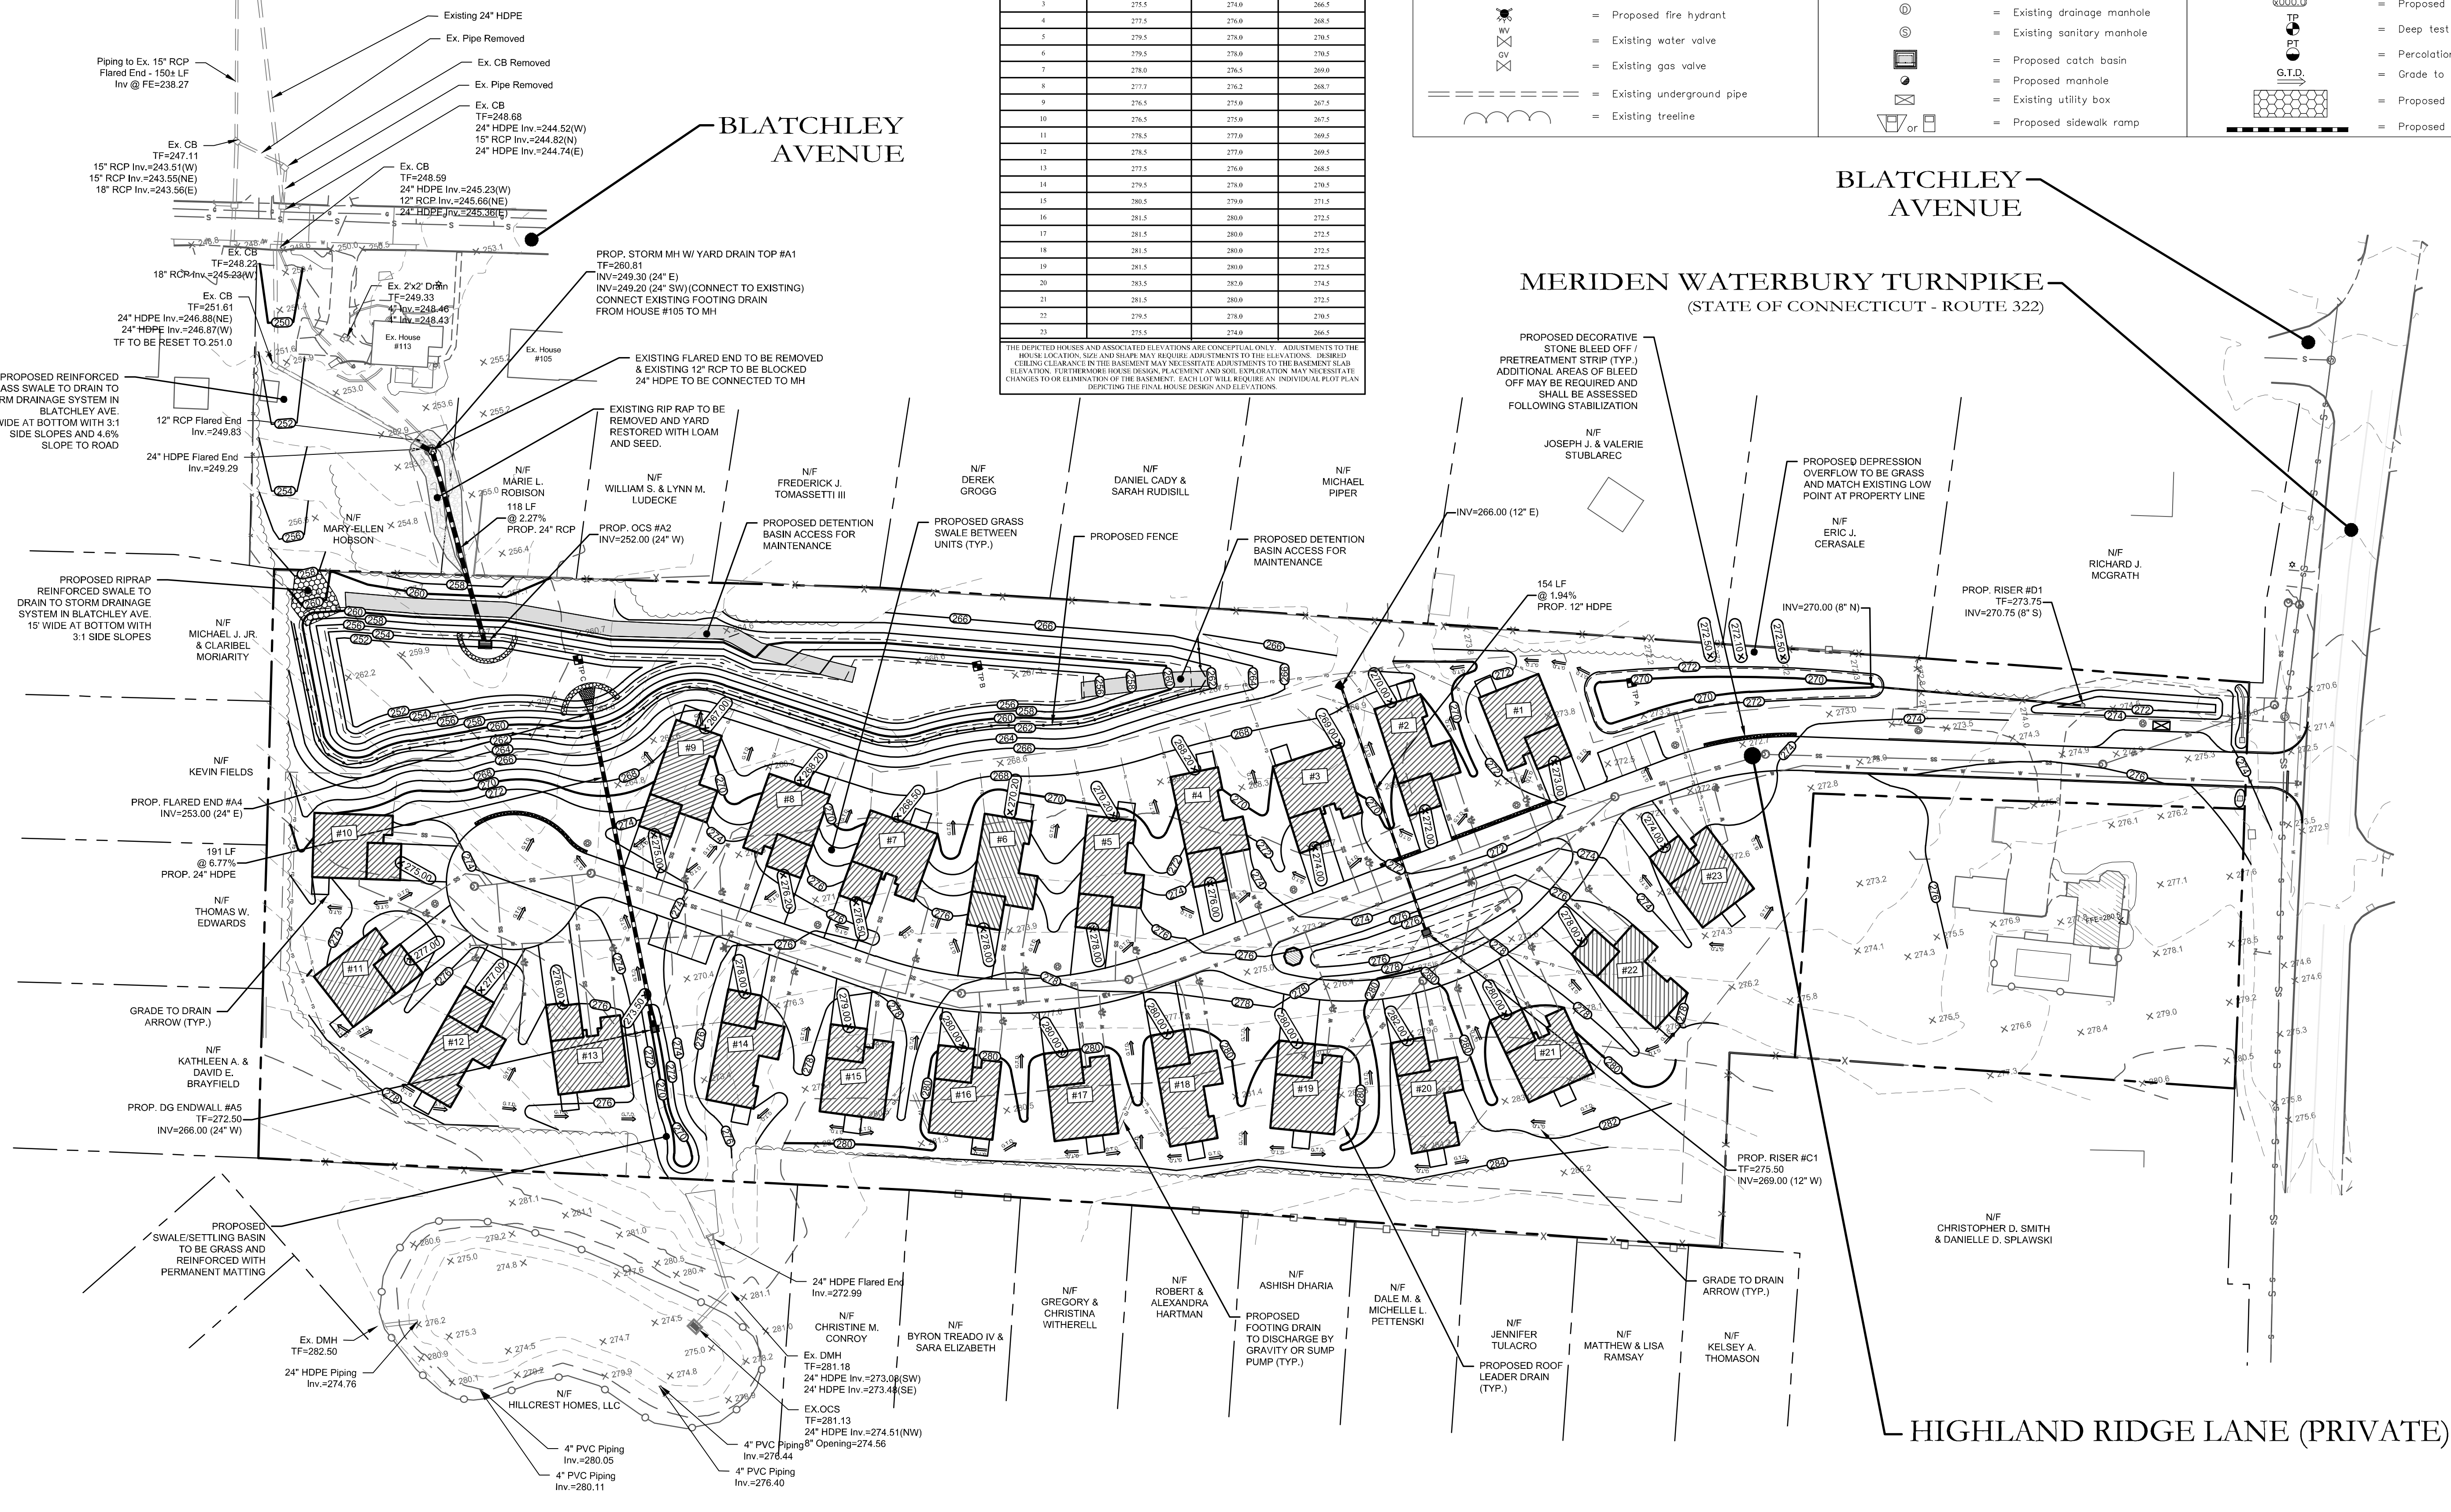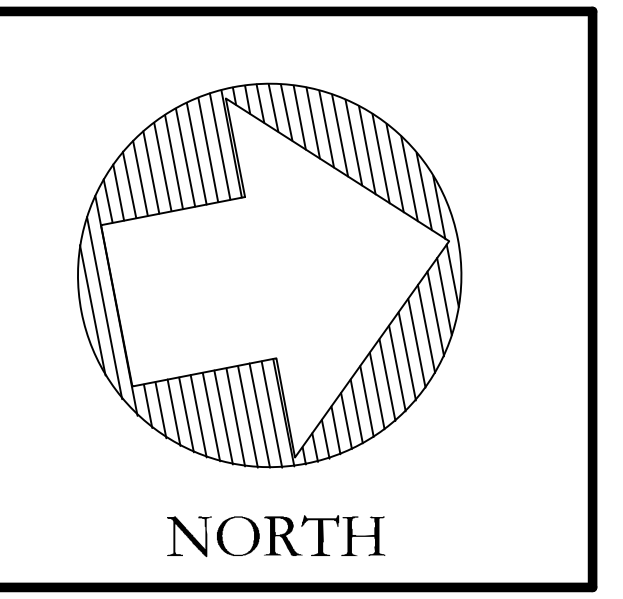

- PLAN NOTES:**
- Additional notes located on Sheet C1.
 - All site work shall conform to specifications as outlined in C.D.O.T. Form 818, dated 2020 and amended to date.
 - Maximum earth slopes shall be two feet horizontal to one foot vertical.
 - All areas disturbed by construction to be restored with 4" of loam and seeded.
 - Roof drains shall daylight to grass lawn areas.
 - All Catch Basins/Inlets shall be cleaned prior to occupancy.
 - Town of Southington Planning and Engineering Departments to be notified at (860)-276-6248 and (860)-276-6231, 24 hours before site grading begins.
 - Prior to any excavation, contractor to notify "CALL BEFORE YOU DIG." 1-800-922-4455.
 - All existing utilities are from best available information, contractor to verify all locations, dimensions, and elevations prior to construction. Notify Engineer of any discrepancies.
 - No floor drains are proposed. Floor drains are not allowed without obtaining Connecticut DEEP permits.
 - Building permit required for construction of retaining walls over 3-ft tall. Design of retaining walls shall be provided by structural/geotechnical engineer prior to construction of walls.

TEST PIT DATA

TP A		TP B		TP C	
Depth (in.)	Description	Depth (in.)	Description	Depth (in.)	Description
0 - 6	Topsoil	0 - 9	Topsoil	0 - 8	Topsoil
6 - 18	Orange/Brown FSL	9 - 27	Orange/Brown FSL	8 - 36	Brown FSL with rocks
18 - 60	Compact Red Boney FS with rocks and cobbles	27 - 50	Compact Red FSL with rocks and cobbles	36 - 65	Brown FSL with rocks and cobbles
	No Mottling Observed	50 - 108	Compact FSL		No Mottling Observed
	No Groundwater Observed		No Mottling Observed		No Groundwater Observed
	No Ledger Observed		No Groundwater Observed		No Ledger Observed
			No Ledger Observed		



#13653
Barton N. Bovee P.E. Reg. No.
NOT VALID UNLESS EMBOSSED SEAL OR STAMP IS AFFIXED HERETO

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P.O. Box 44 Fax: (860) 620-0196
Plainville, CT 06479-0044 www.hecole.com

PROJECT NAME:
HIGHLAND RIDGE ACTIVE ADULT COMMUNITY

580 Meriden Waterbury Turnpike
Southington, Connecticut

PREPARED FOR:
AA DENORFIA BUILDING & DEVELOPMENT

Sheet Description:
SITE GRADING & DRAINAGE PLAN

Scale: 1"=50'

Date: September 1, 2022	F.B. #:
Project #: 2235	Approved By: BNB
Drawn By: BTP	Revisions:
	Date: Descriptions:
	Sept. 26, 2022 Revised per Town Comments
	Oct. 20, 2022 Revised Detention Basin & Water
	Oct. 31, 2022 Revised per Town Comments

Sheet #:
C2

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MERIDEN WATERBURY TURNPIKE
(STATE OF CONNECTICUT - ROUTE 322)

HIGHLAND RIDGE LANE (PRIVATE)




FOOTING DRAINS TO DISCHARGE BY GRAVITY OR SUMP PUMP TO DAYLIGHT OR STORMWATER COLLECTION SYSTEM THE REQUIREMENT AND DISCHARGE METHOD OF FOOTING DRAINS SHALL BE EVALUATED WITH EACH PLOT PLAN. USE OF BACKFLOW CHECK VALVES AND PUMP CONNECTIONS IS RECOMMENDED TO MINIMIZE THE POTENTIAL OF BACKFLOWS FROM THE DRAINAGE SYSTEM TO FOUNDATION DRAINS.

CONSTRUCT DETENTION BASIN, INCLUDING BERMS AND FOREBAYS, PRIOR TO ANY OTHER CONSTRUCTION ACTIVITIES. BASIN SHALL BE USED AS TEMPORARY SEDIMENTATION BASIN AND DEWATERING BASIN DURING CONSTRUCTION. EXCESS SILT AND MATERIAL SHALL BE REMOVED AFTER ESTABLISHING FINAL GRADES FOR THE SITE.


LEGEND

	= Existing utility pole		= Existing edge of pavement
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	= Existing gas valve		= Proposed catch basin
	= Existing underground pipe		= Proposed manhole
	= Existing treeline		= Existing utility box
			= Proposed sidewalk ramp

	= Existing contour
	= Existing spot elevation
	= Proposed contour
	= Proposed spot elevation
	= Deep test location
	= Percolation test location
	= Grade to drain
	= Proposed Riprap
	= Proposed Drainage Pipe

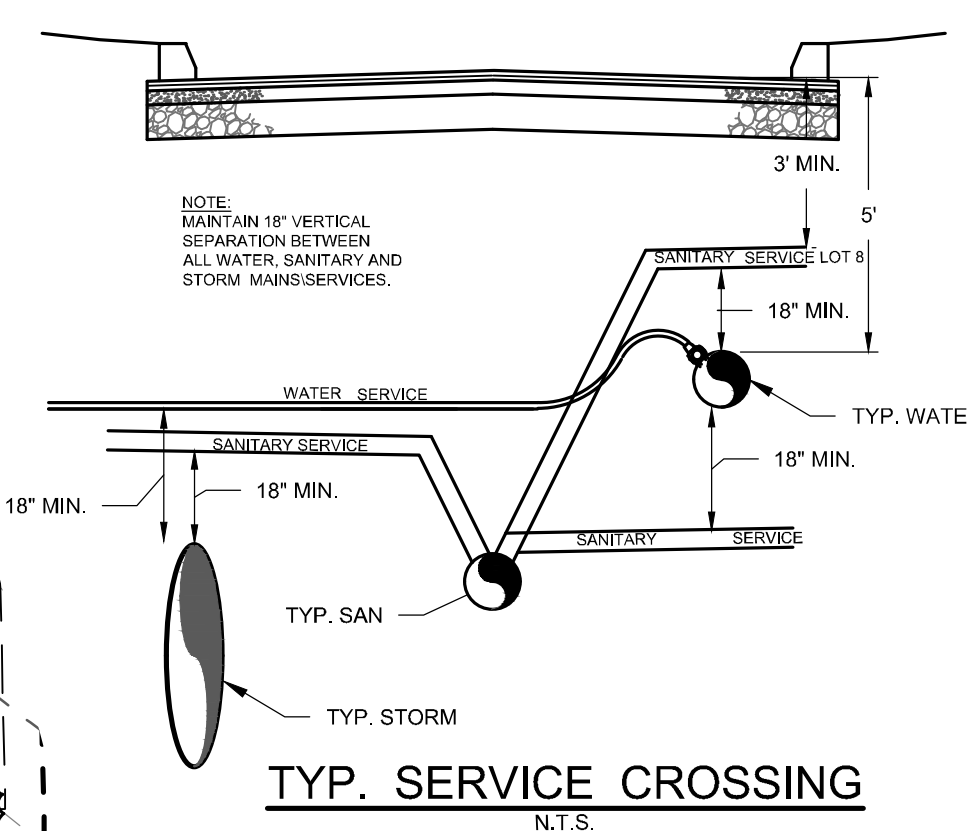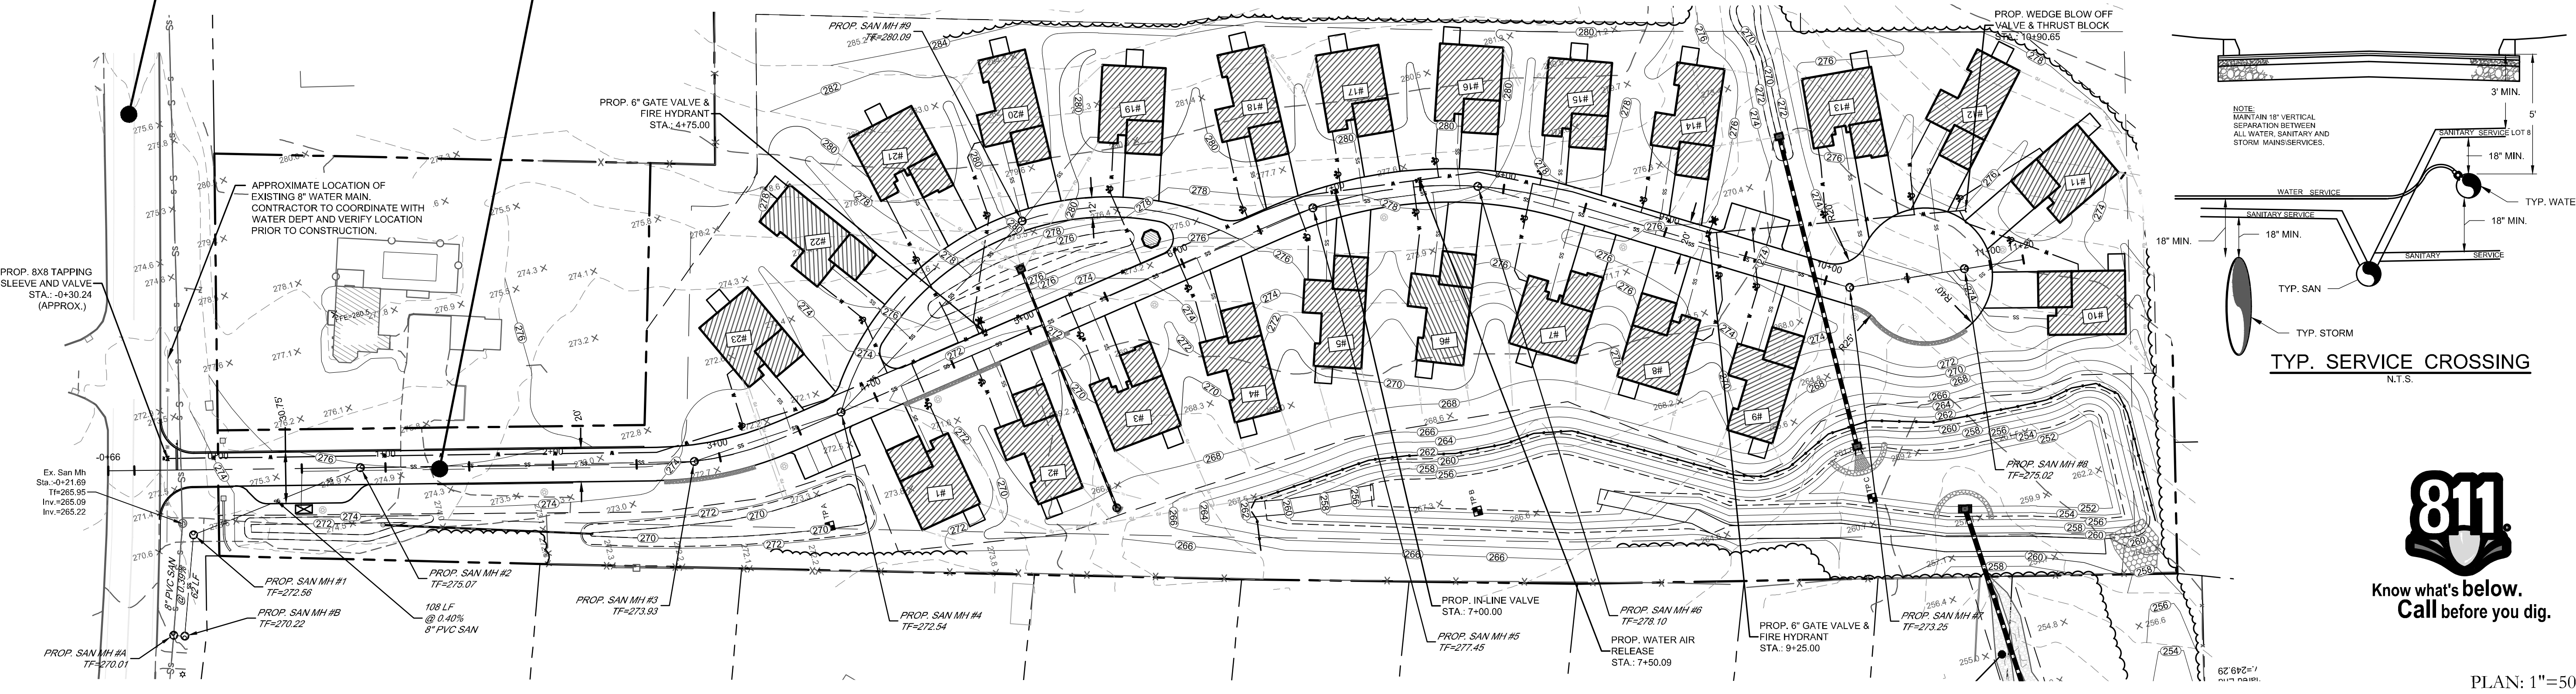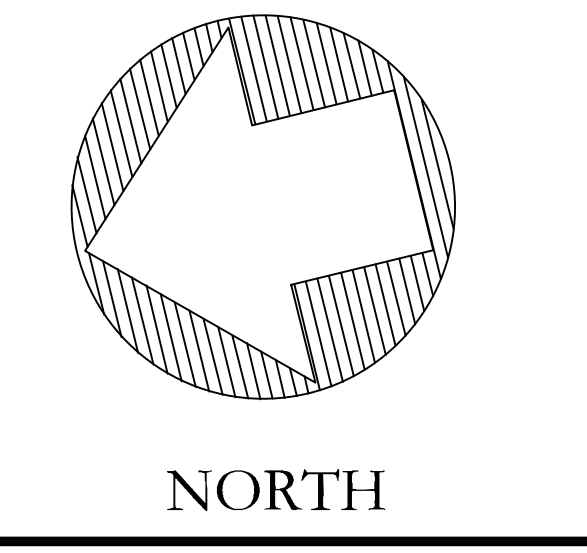

PLAN: 1"=50'
PROFILE: H/1"=50'
V/1"=5'

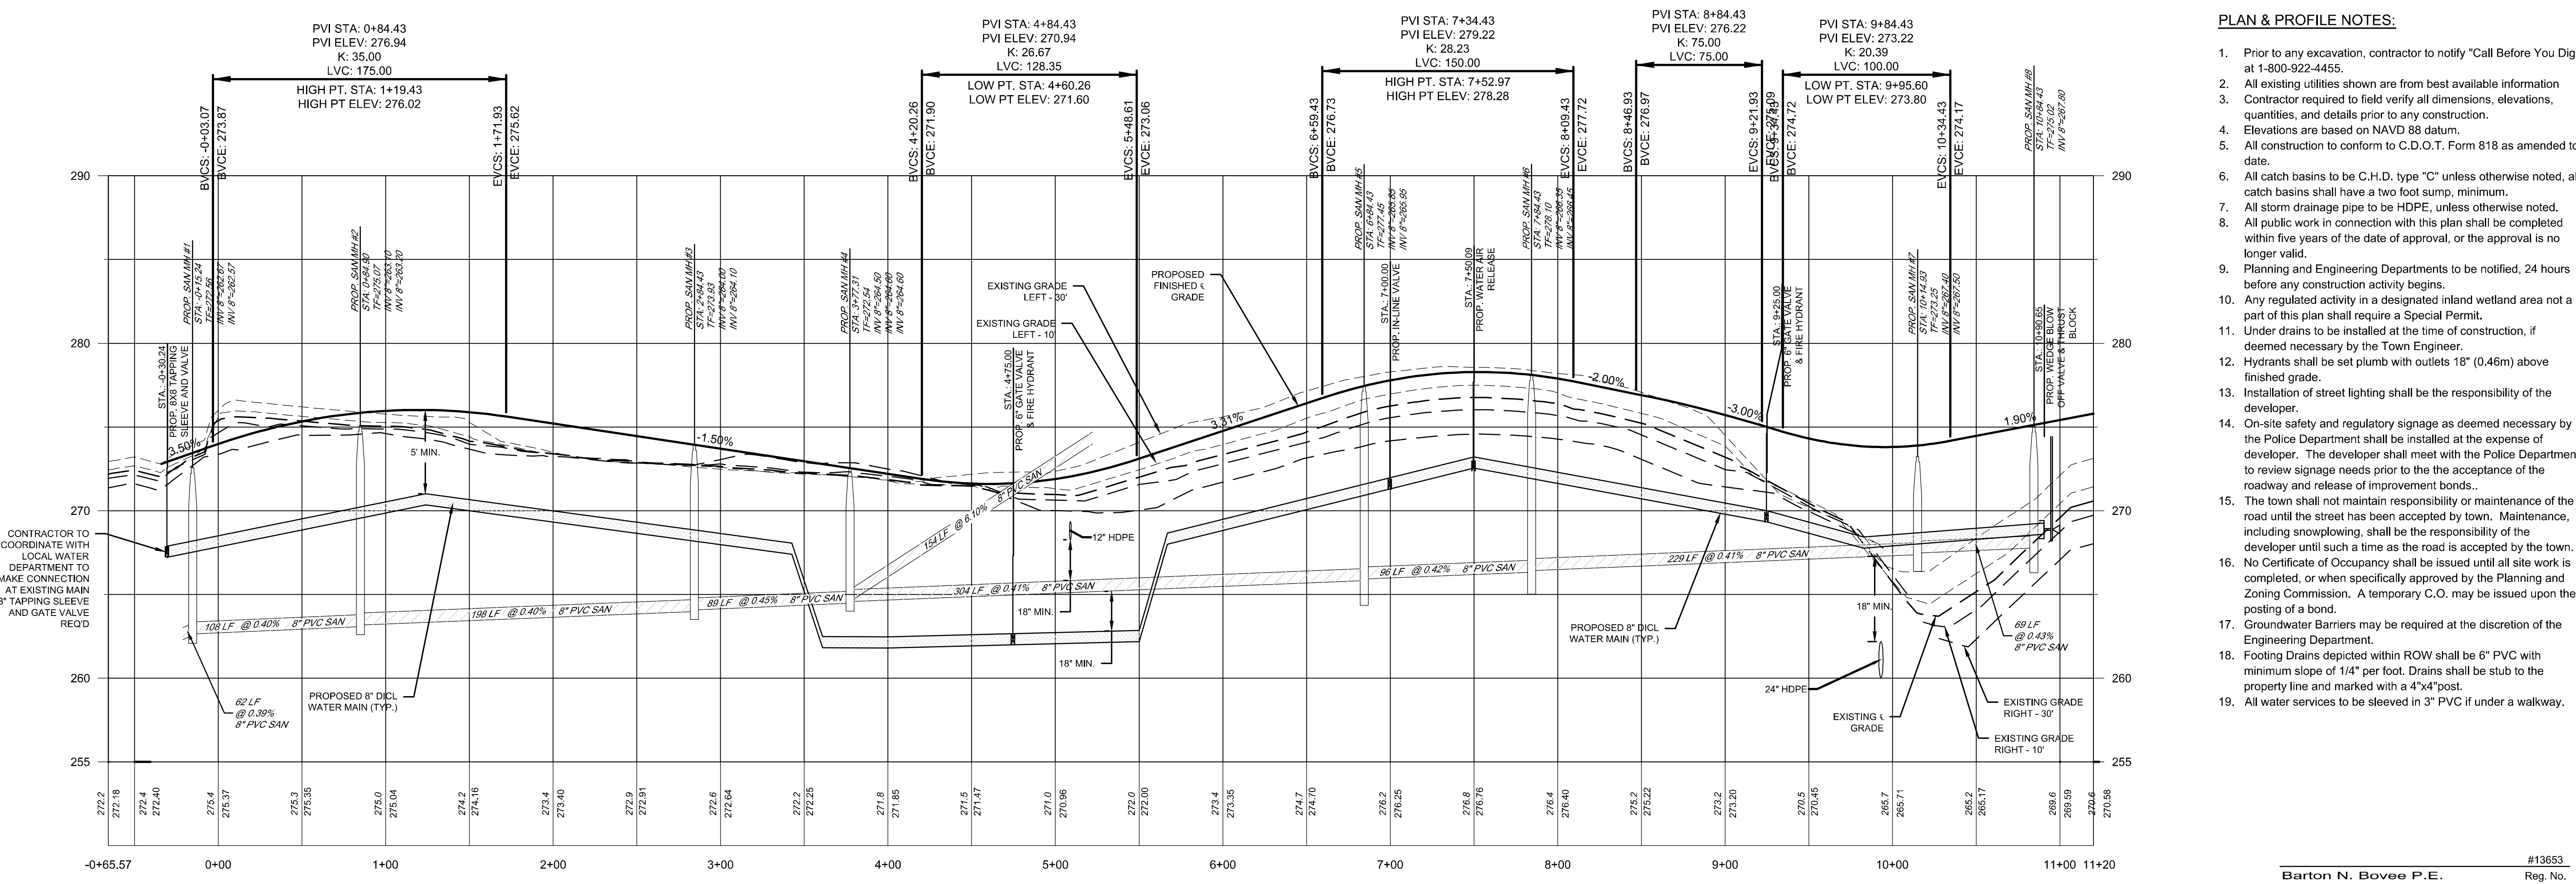

- PLAN & PROFILE NOTES:**
- Prior to any excavation, contractor to notify "Call Before You Dig" at 1-800-922-4455.
 - All existing utilities shown are from best available information.
 - Contractor required to field verify all dimensions, elevations, quantities, and details prior to any construction.
 - Elevations are based on NAVD 88 datum.
 - All construction to conform to C.D.O.T. Form 818 as amended to date.
 - All catch basins to be C.H.D. type "C" unless otherwise noted, all catch basins shall have a two foot sump, minimum.
 - All storm drainage pipe to be HDPE, unless otherwise noted.
 - All public work in connection with this plan shall be completed within five years of the date of approval, or the approval is no longer valid.
 - Planning and Engineering Departments to be notified, 24 hours before any construction activity begins.
 - Any regulated activity in a designated inland wetland area not a part of this plan shall require a Special Permit.
 - Under drains to be installed at the time of construction, if deemed necessary by the Town Engineer.
 - Hydrants shall be set plumb with outlets 18" (0.46m) above finished grade.
 - Installation of street lighting shall be the responsibility of the developer.
 - On-site safety and regulatory signage as deemed necessary by the Police Department shall be installed at the expense of developer. The developer shall meet with the Police Department to review signage needs prior to the acceptance of the roadway and release of improvement bonds.
 - The town shall not maintain responsibility or maintenance of the road until the street has been accepted by town. Maintenance, including snowplowing, shall be the responsibility of the developer until such a time as the road is accepted by the town.
 - No Certificate of Occupancy shall be issued until all site work is completed, or when specifically approved by the Planning and Zoning Commission. A temporary C.O. may be issued upon the posting of a bond.
 - Groundwater Barriers may be required at the discretion of the Engineering Department.
 - Footing Drains depicted within ROW shall be 6" PVC with minimum slope of 1/4" per foot. Drains shall be stub to the property line and marked with a 4"x4" post.
 - All water services to be sleeved in 3" PVC if under a walkway.

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engineering. surveying. planning.

876 South Main Street P.O. Box 44
Plainville, CT 06479 - 0044

Tel: (860) 628-4484
Fax: (860) 620-0196
www.hecole.com

PROJECT NAME:
HIGHLAND RIDGE ACTIVE ADULT COMMUNITY

580 Meriden Waterbury Turnpike
Southington, Connecticut

PREPARED FOR:
AA DENORFIA BUILDING & DEVELOPMENT

Sheet Description:
PLAN AND PROFILE HIGHLAND RIDGE LANE (PRIVATE)

Scale: 1"=50'

Date: September 1, 2022

Project #: 2235 F.B.#: ---


















Drawn By: BTP Approved By: BNB

Revisions:

Date:	Descriptions:
Sept. 26, 2022	Revised per Town Comments
Oct. 20, 2022	Revised Detention Basin & Water
Oct. 31, 2022	Revised per Town Comments
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Sheet #:
P1

#13653
Barton N. Bovee P.E. Reg. No.
NOT VALID UNLESS EMBOSSED SEAL OR STAMP IS AFFIXED HERETO

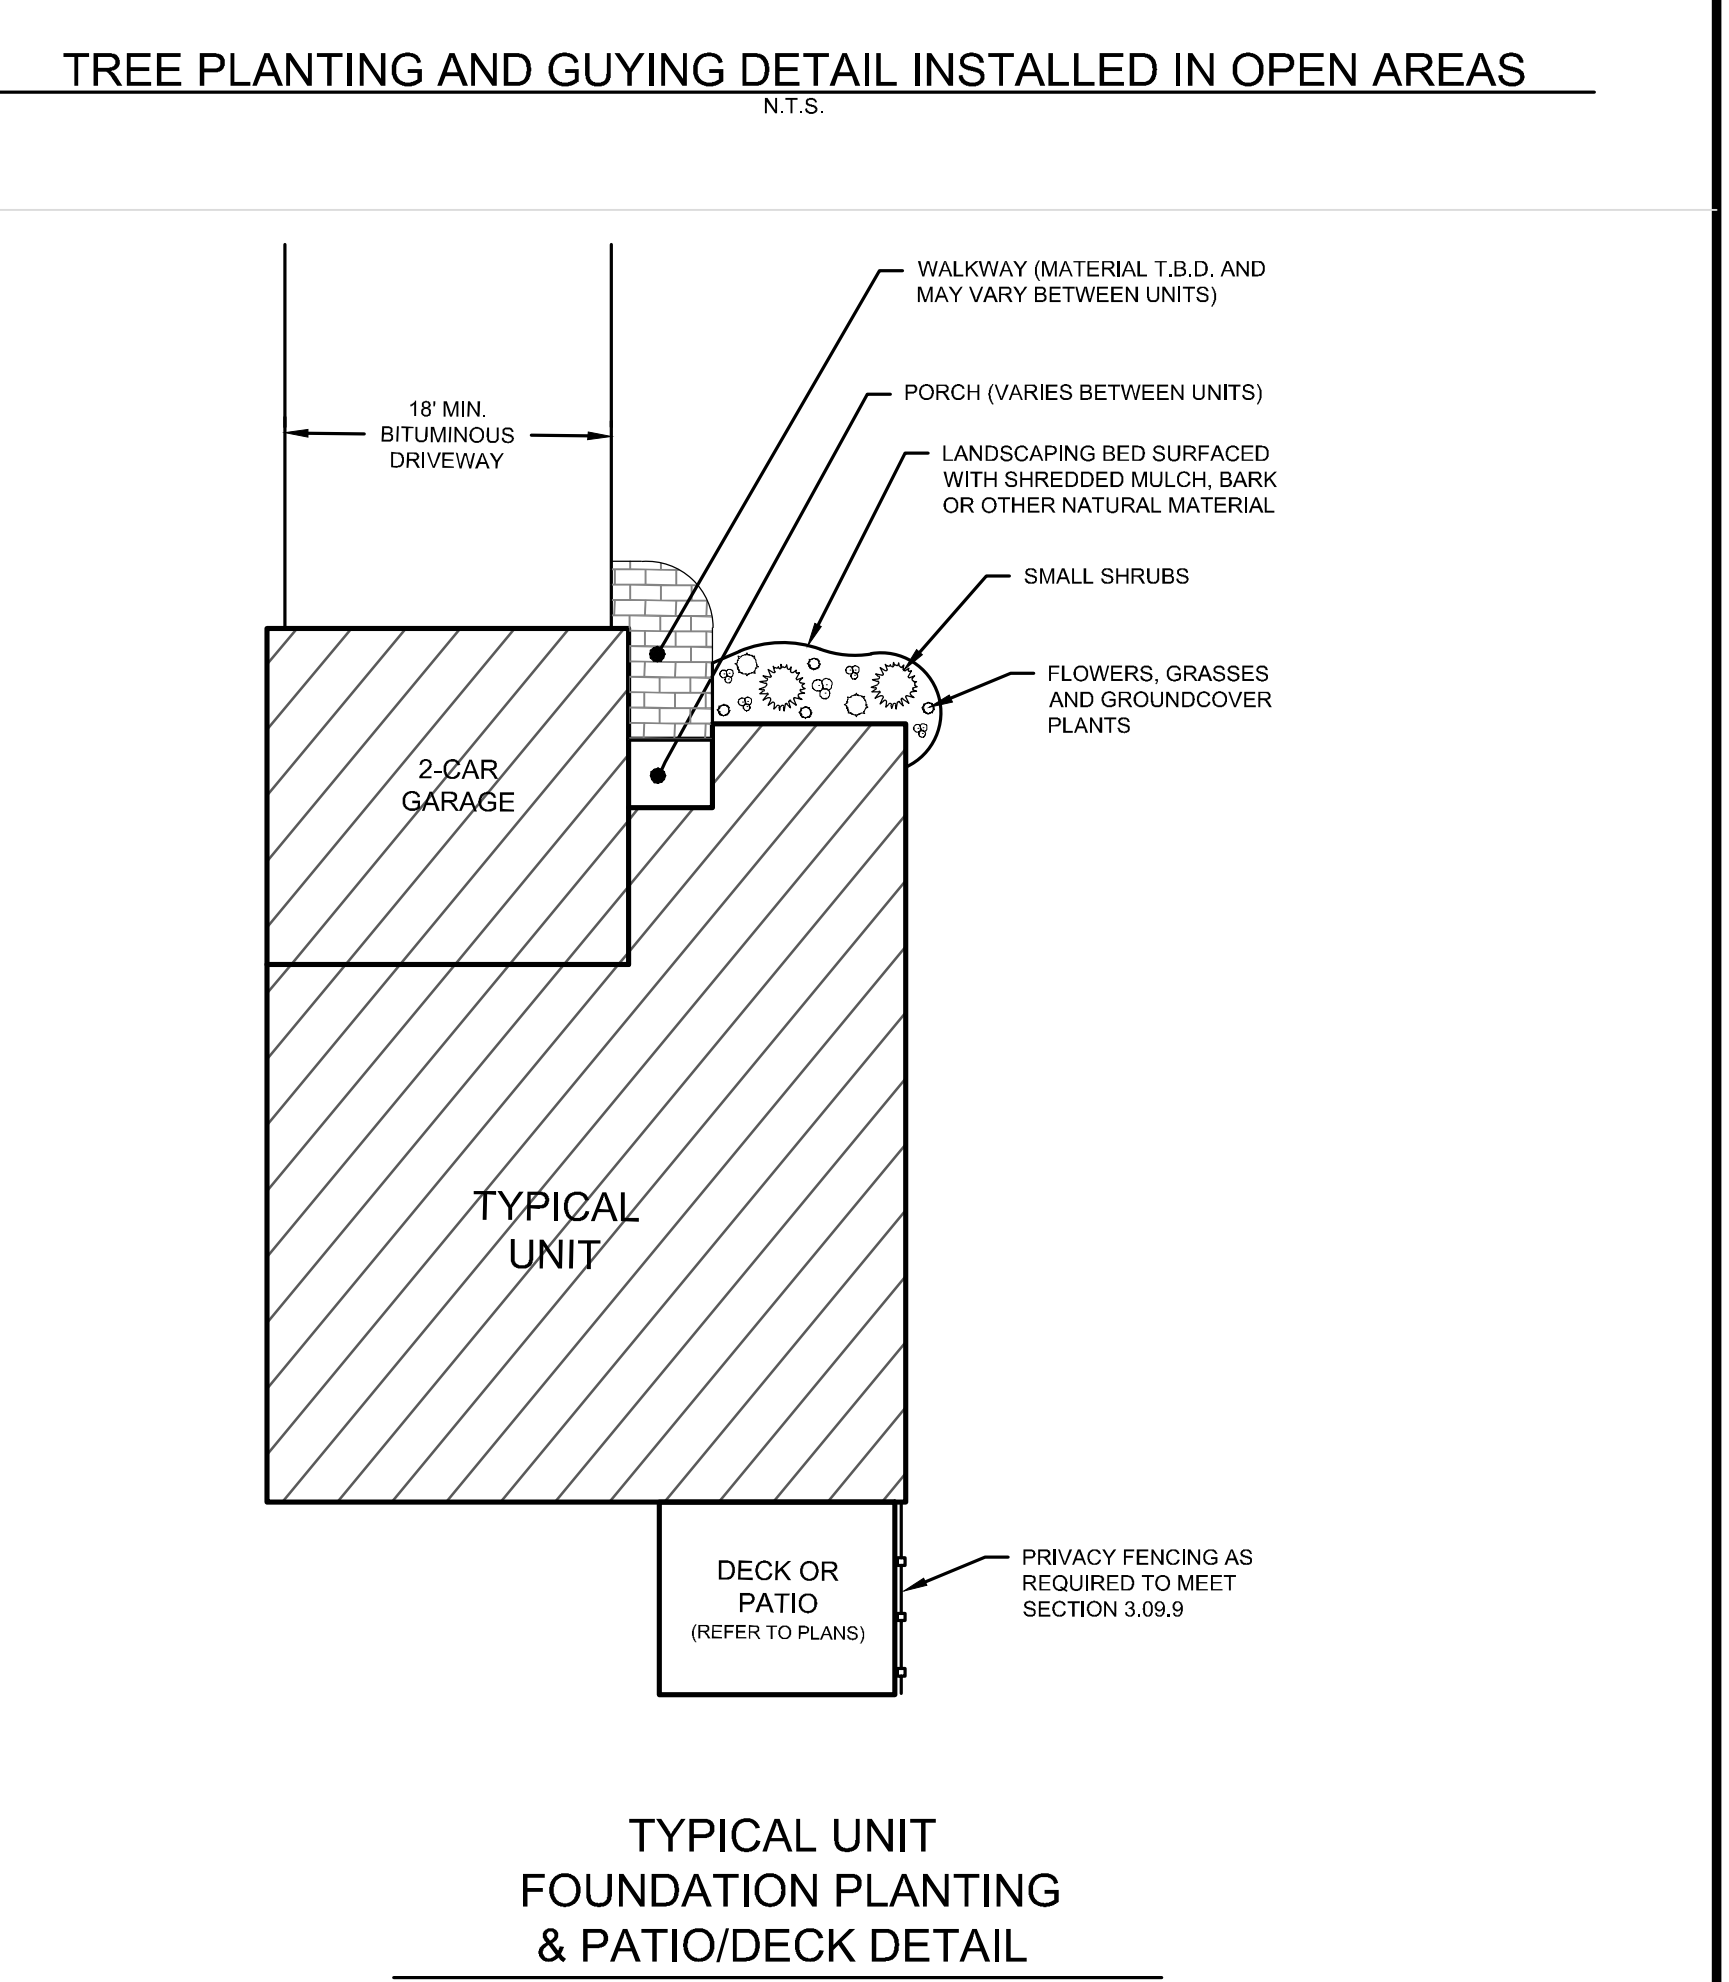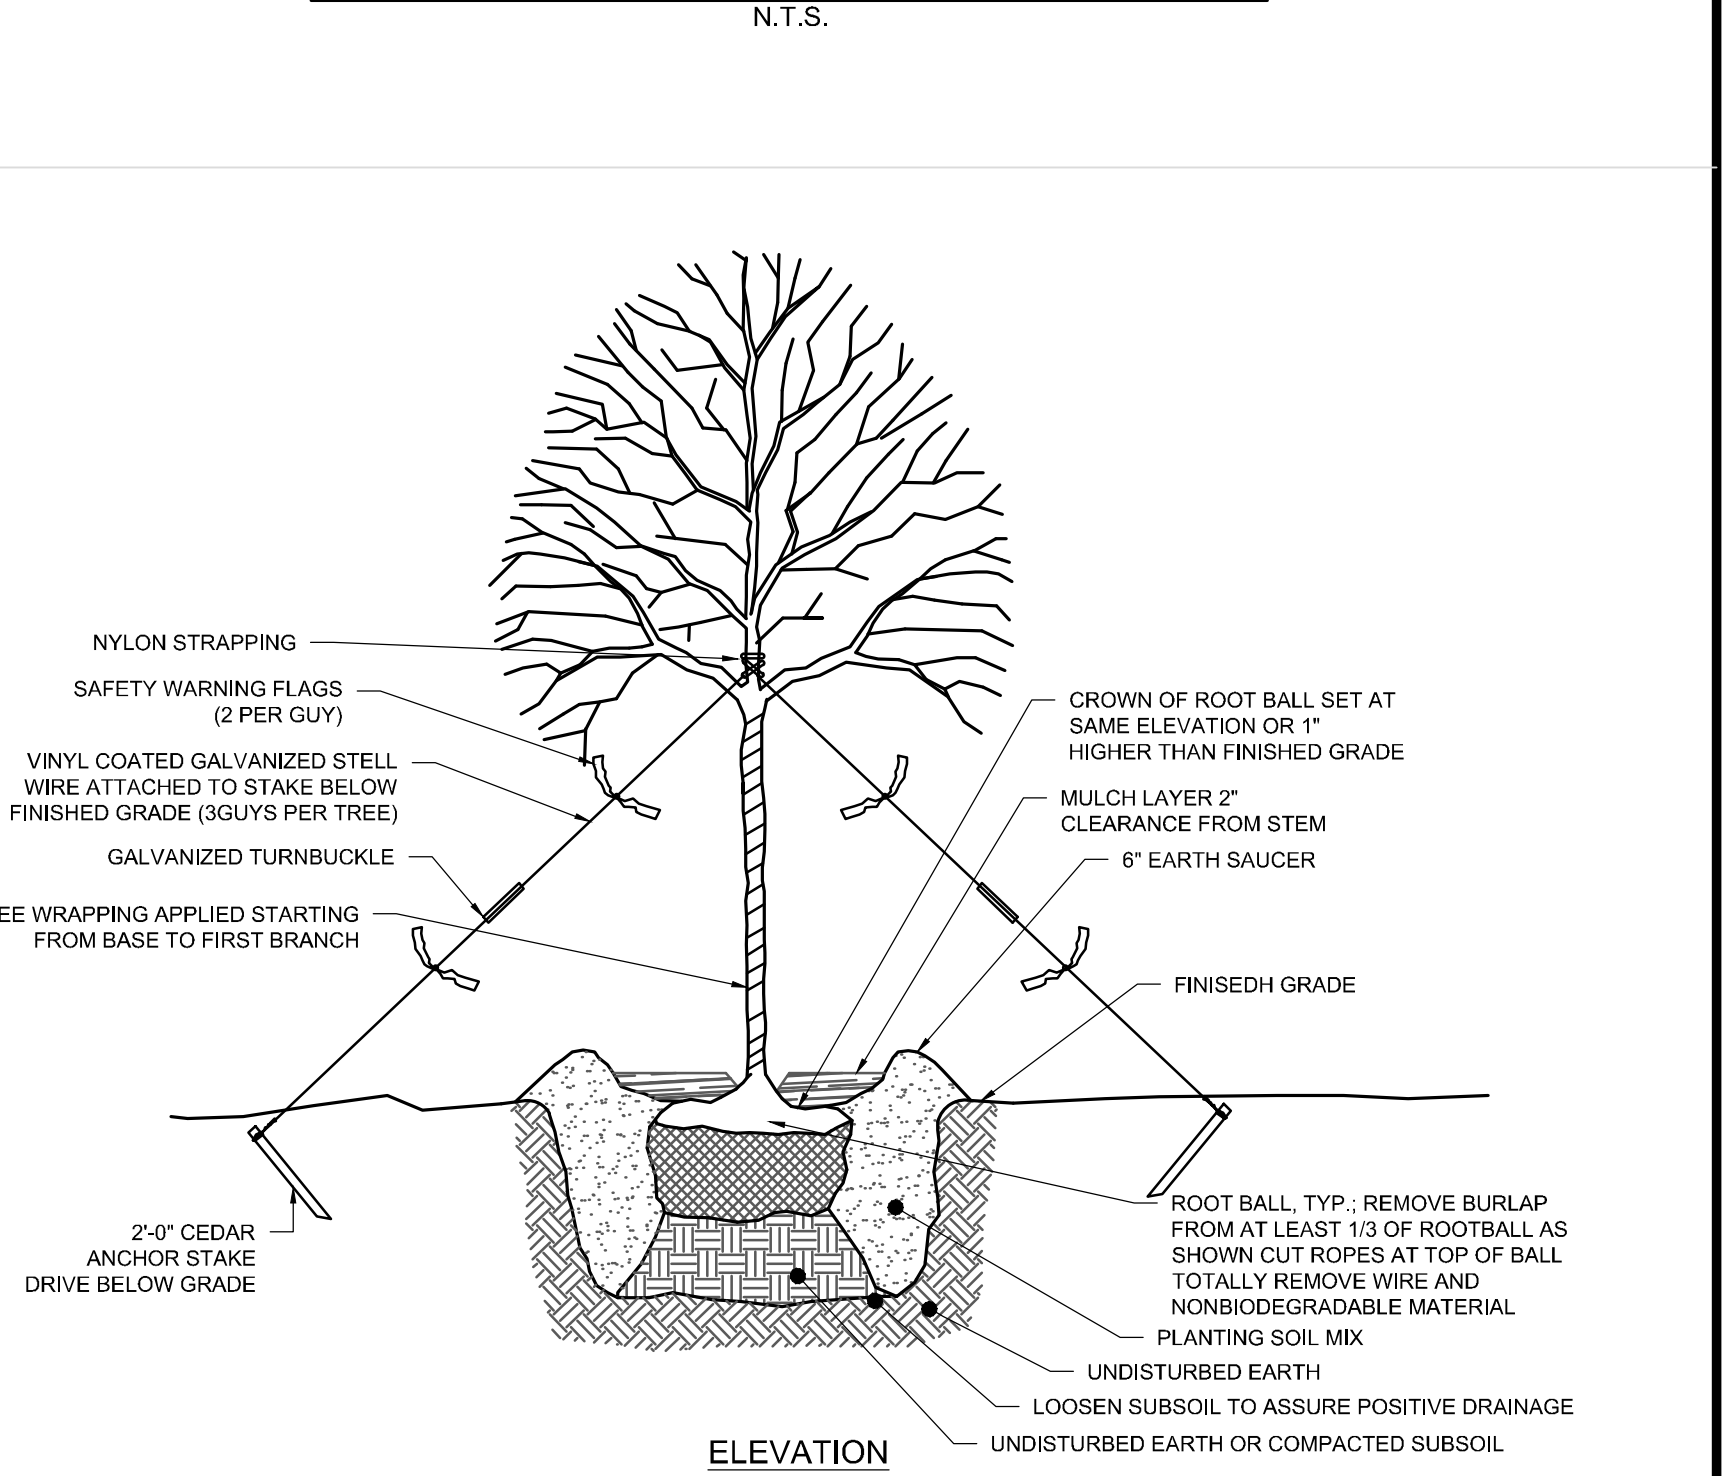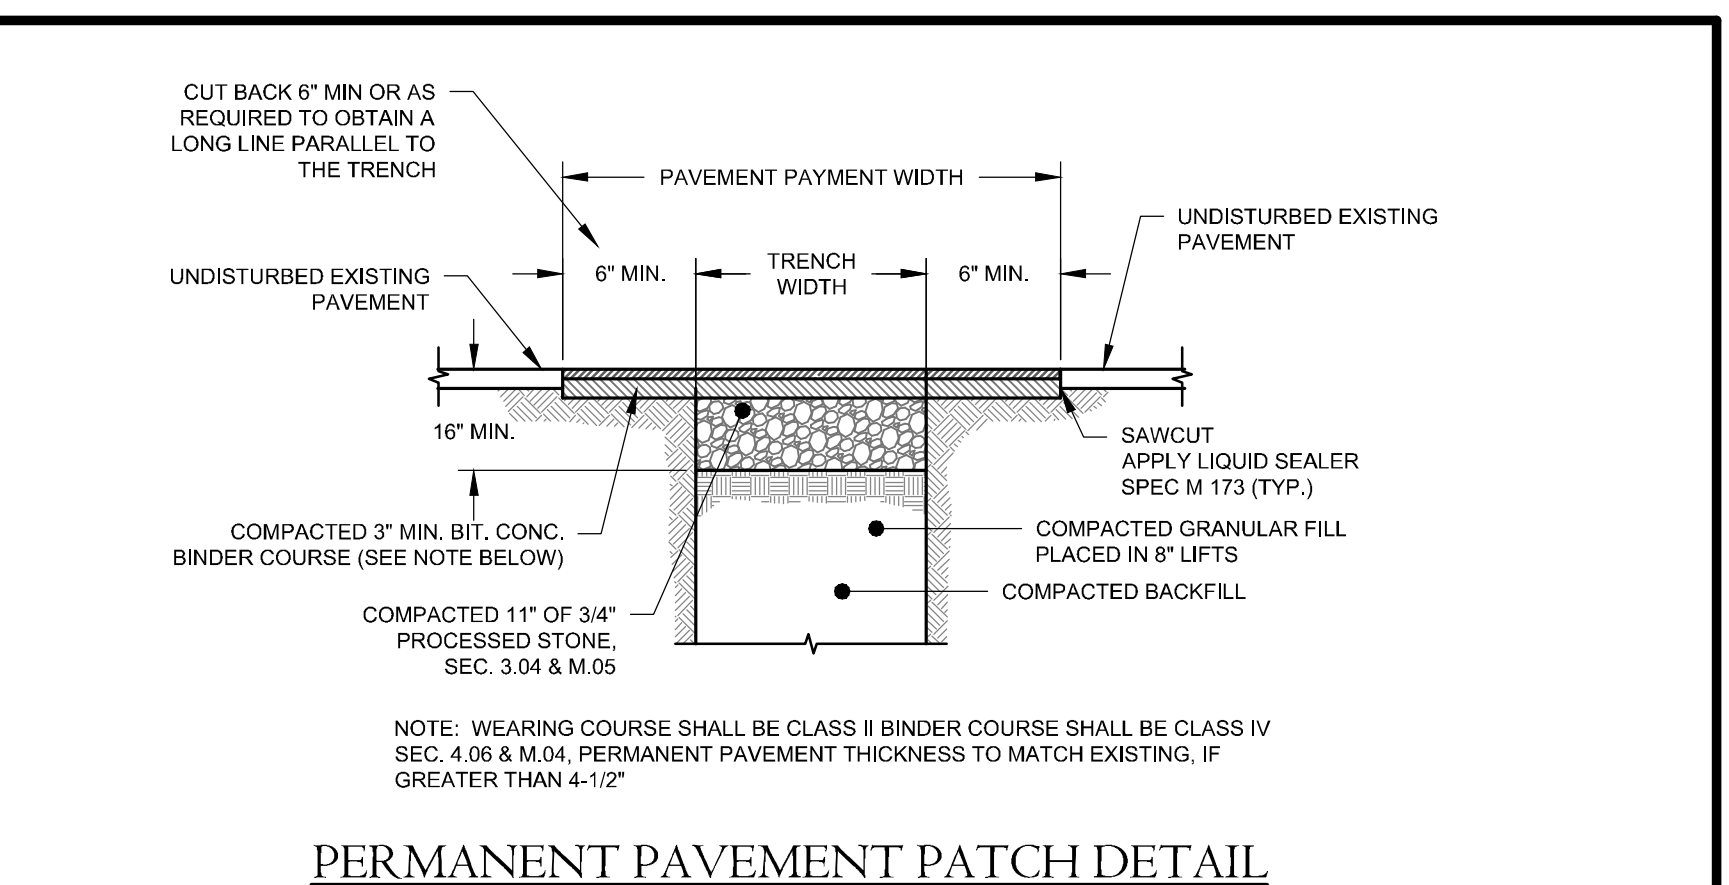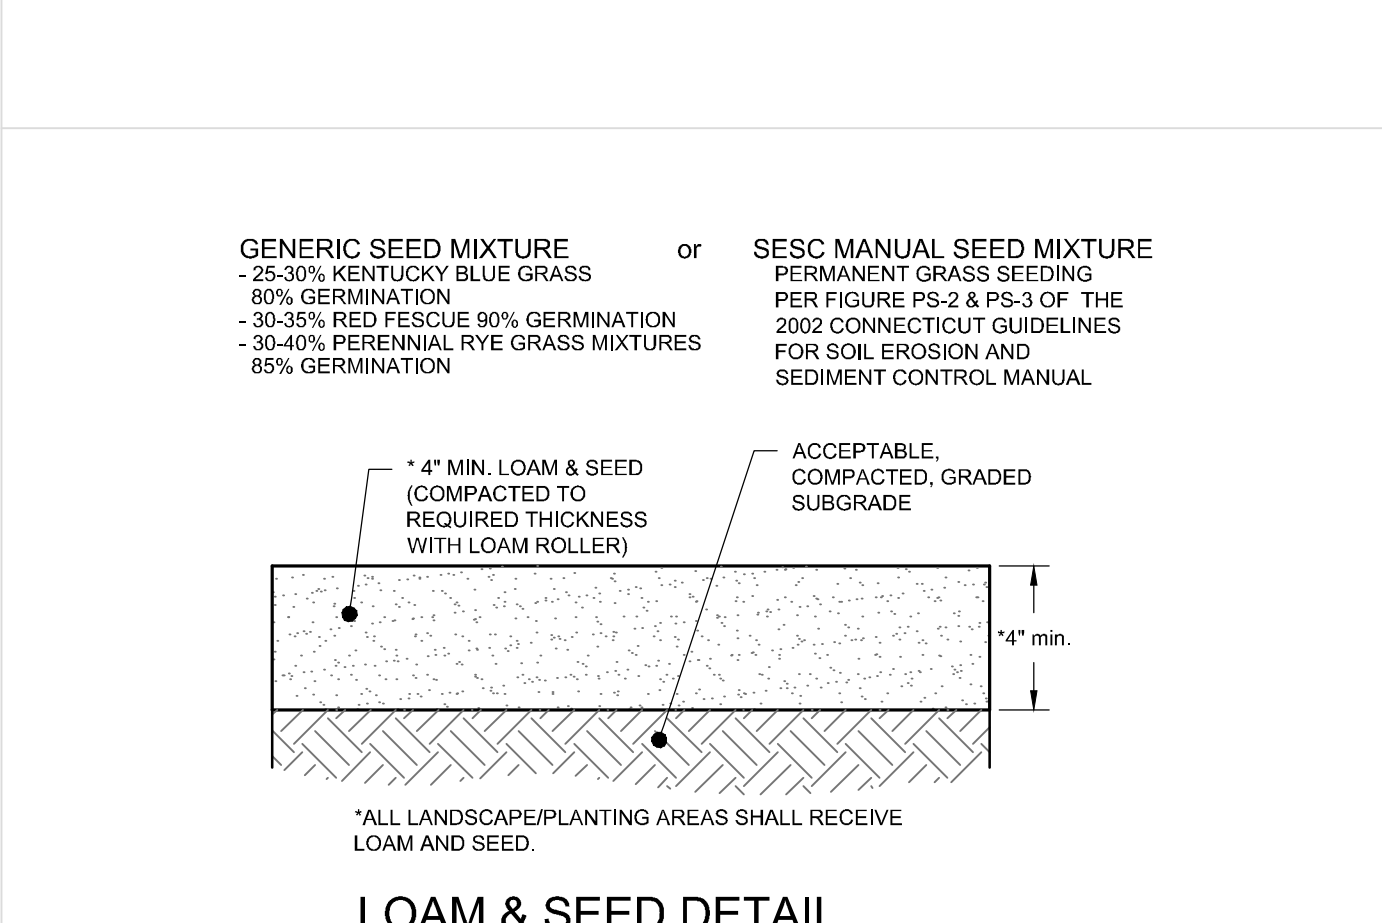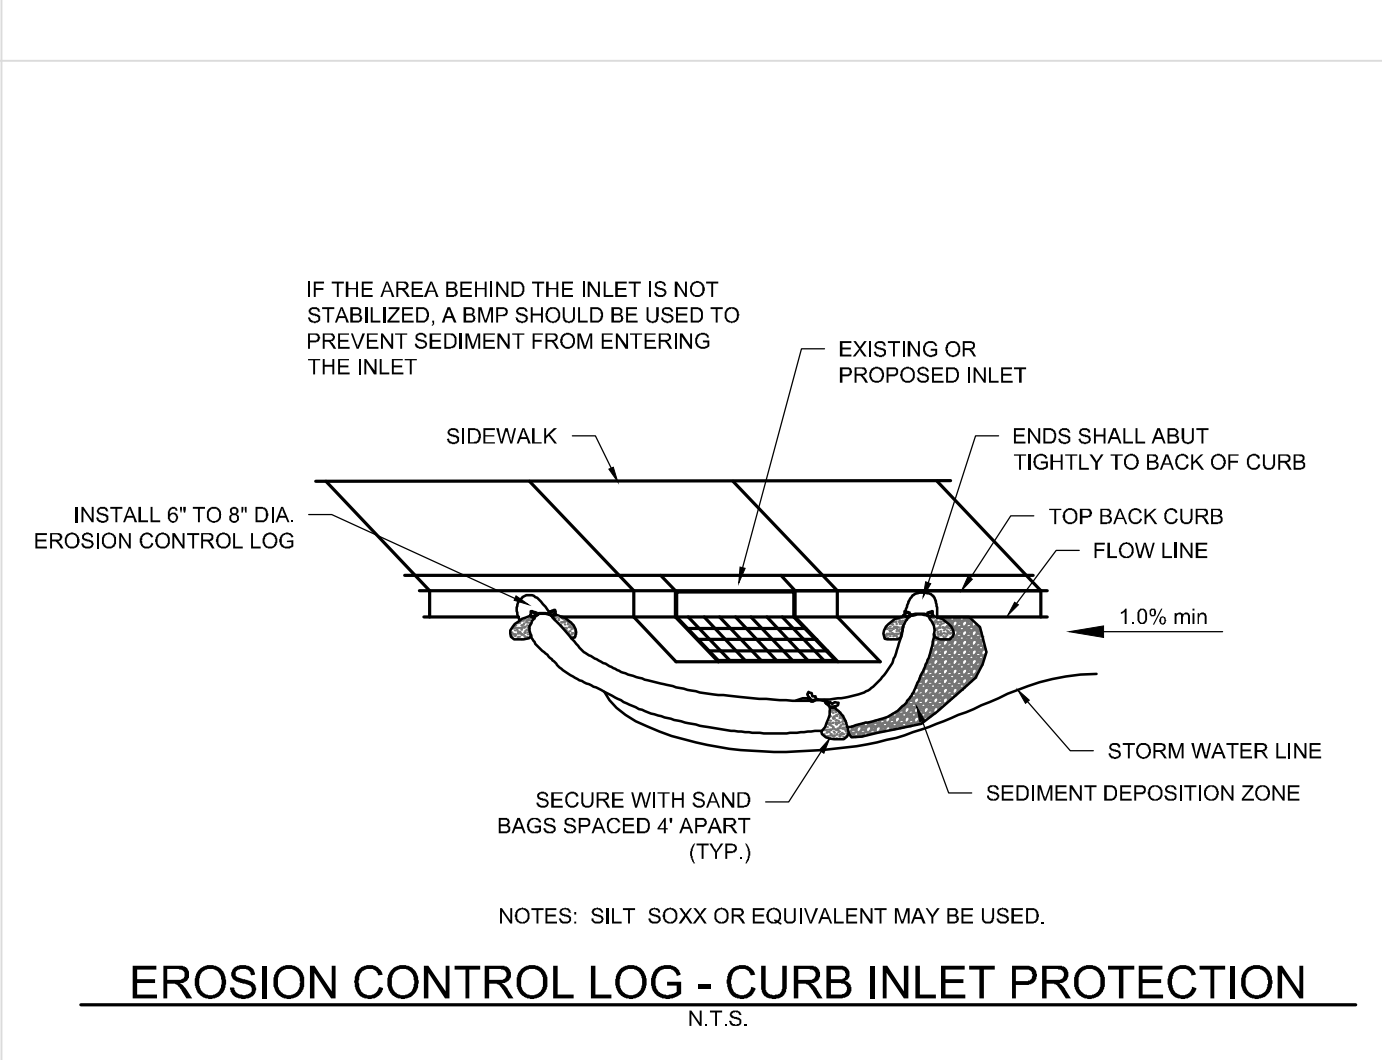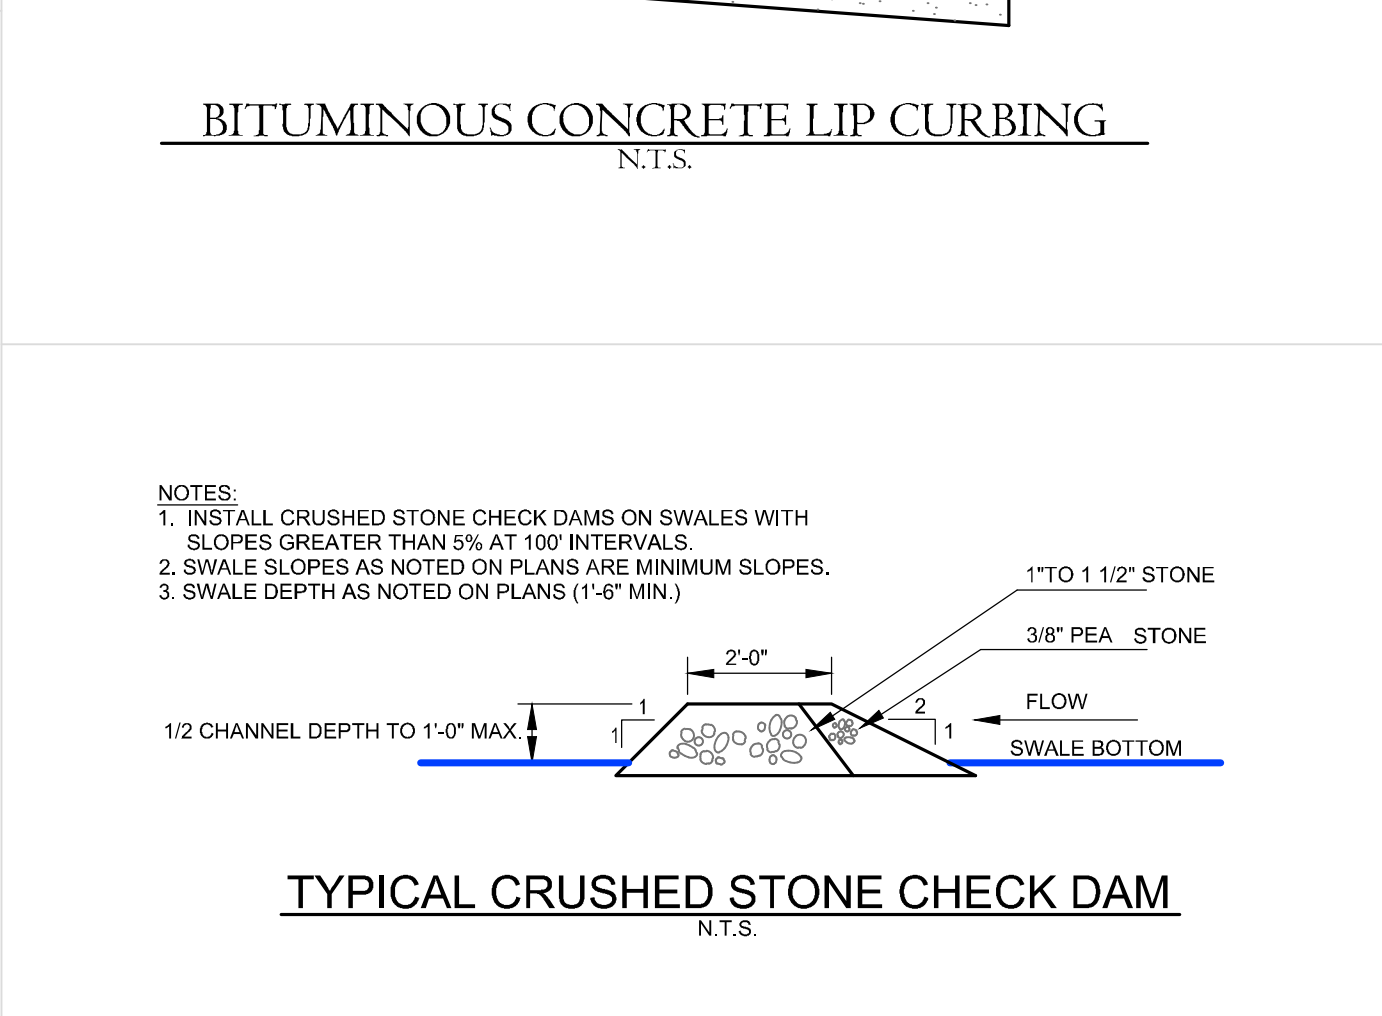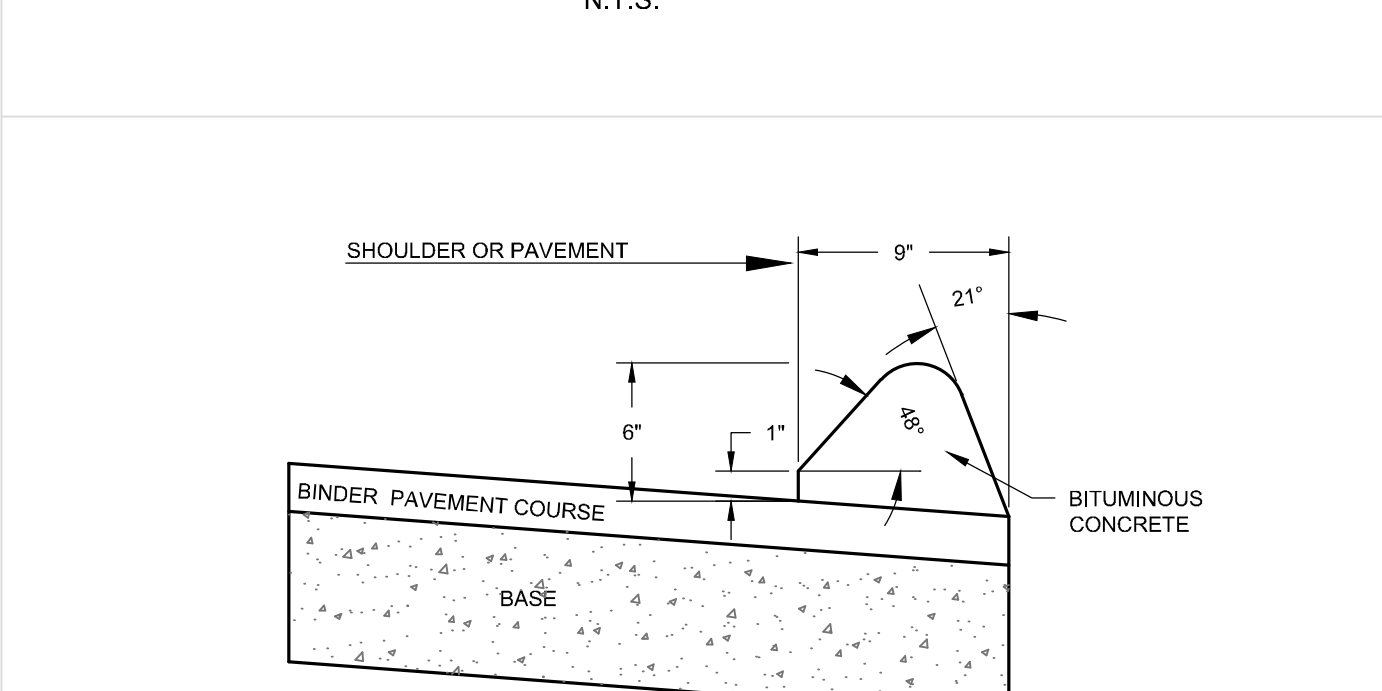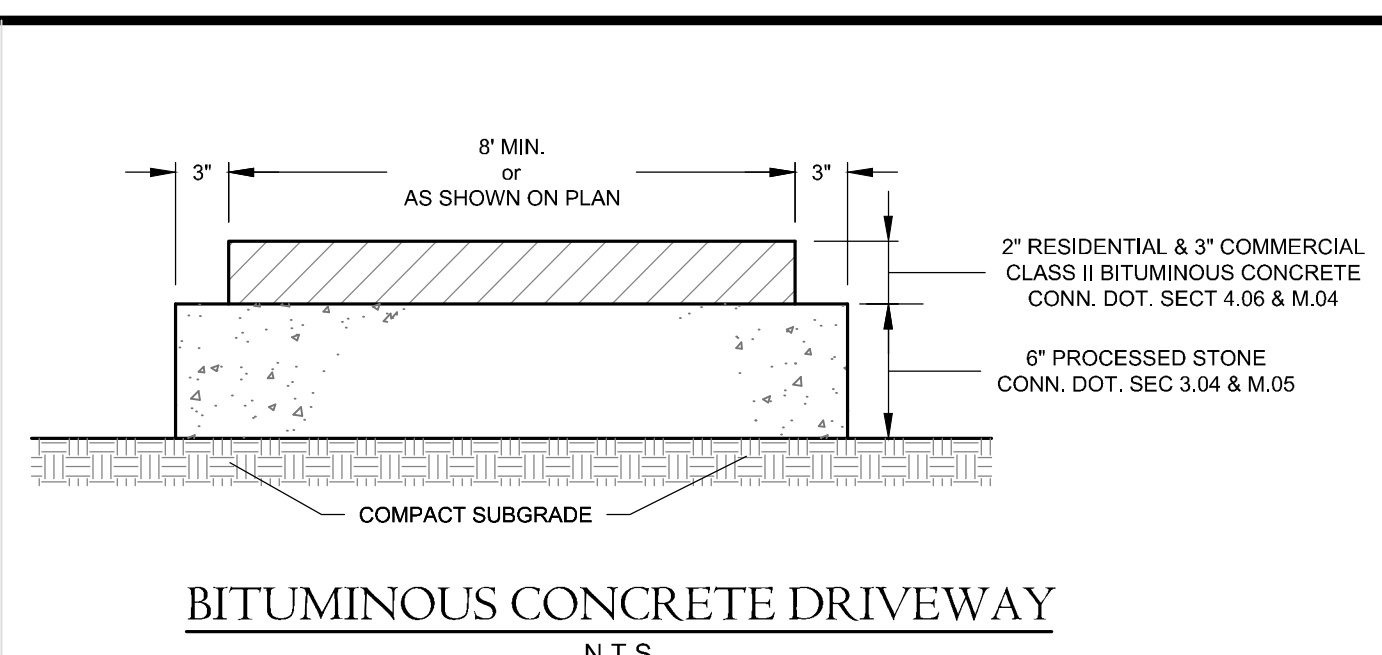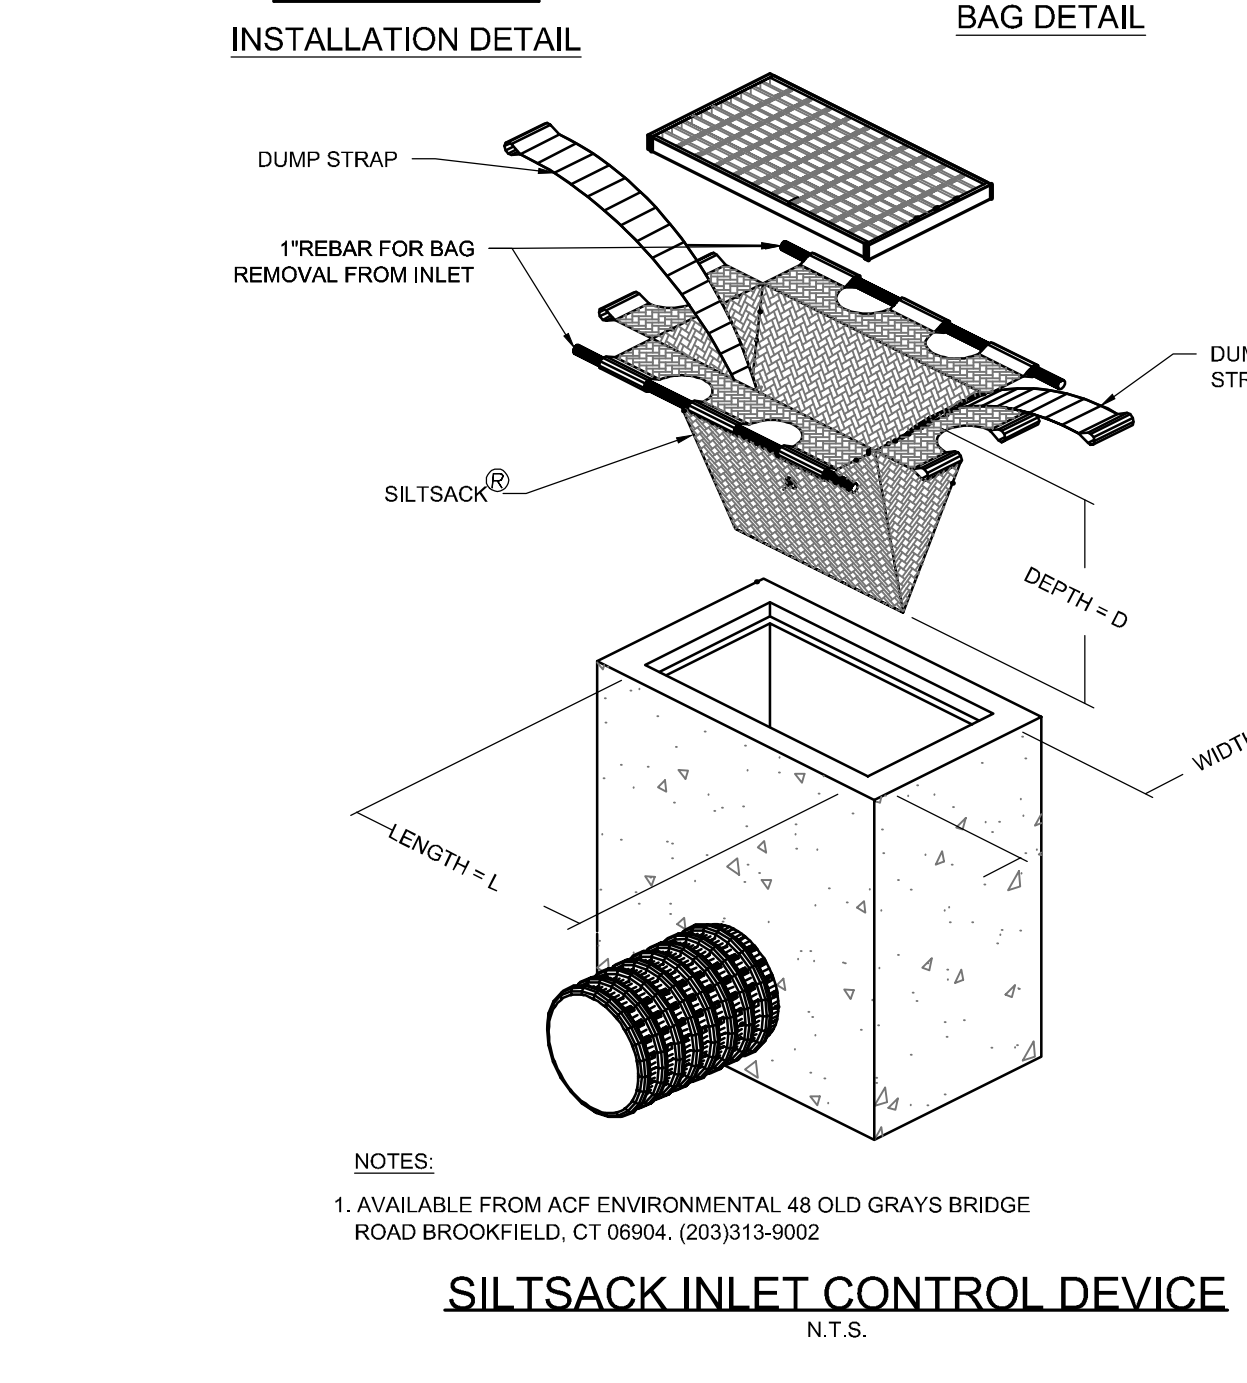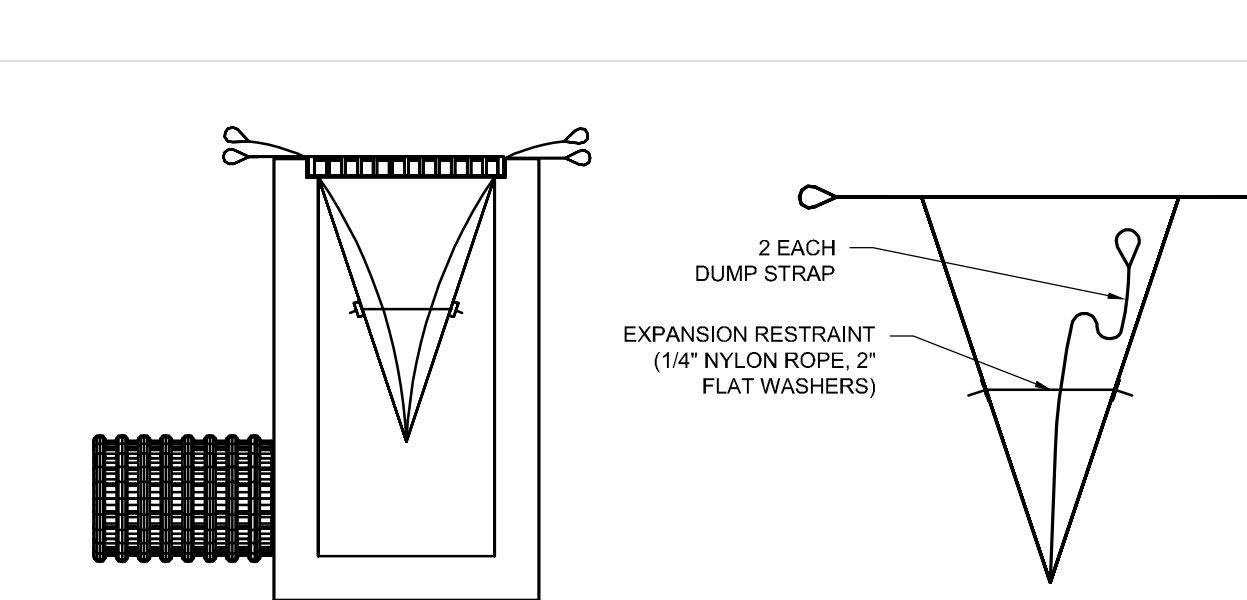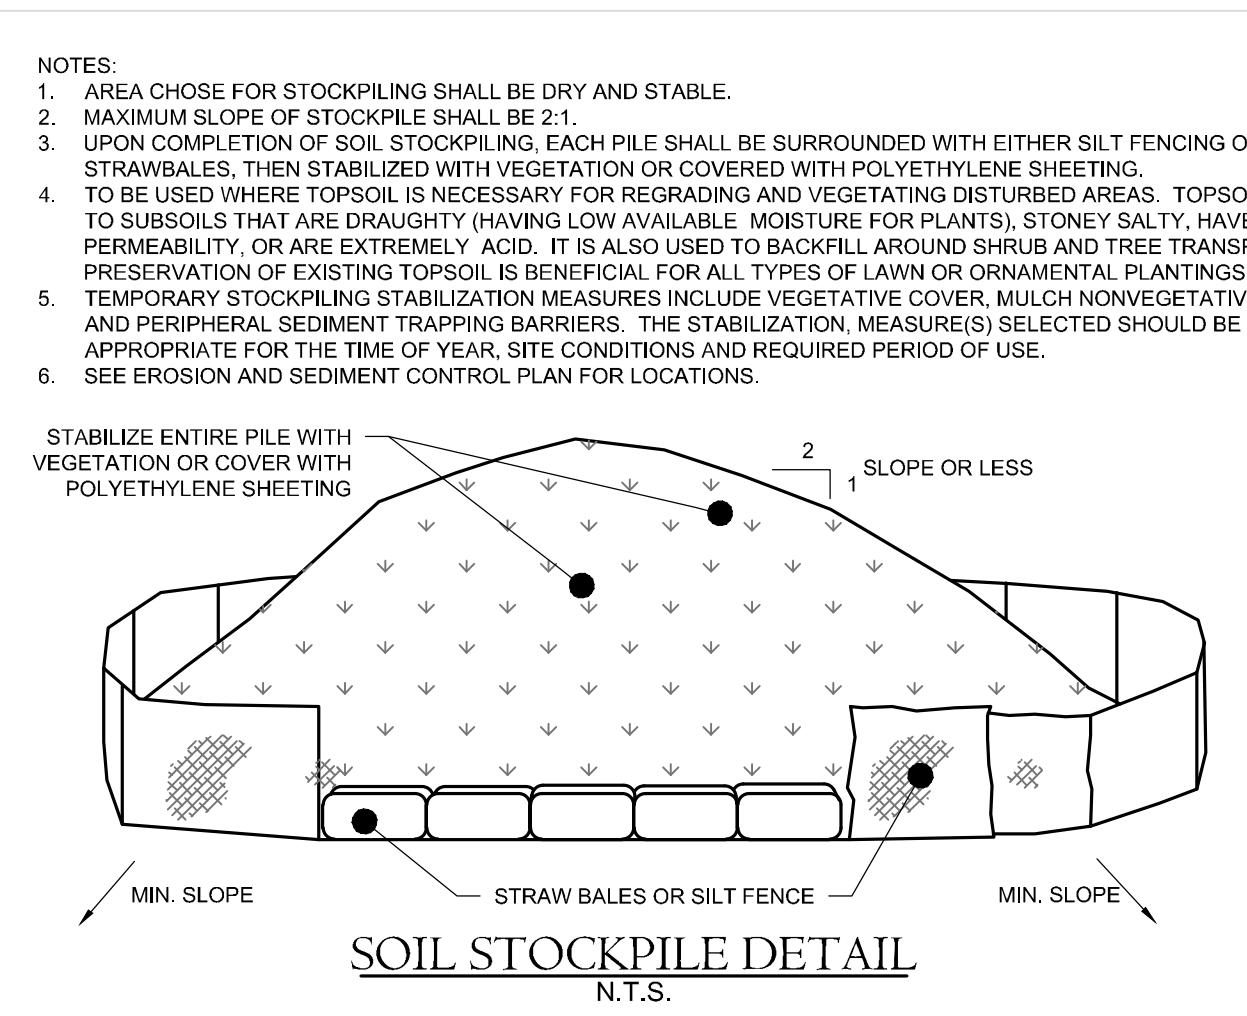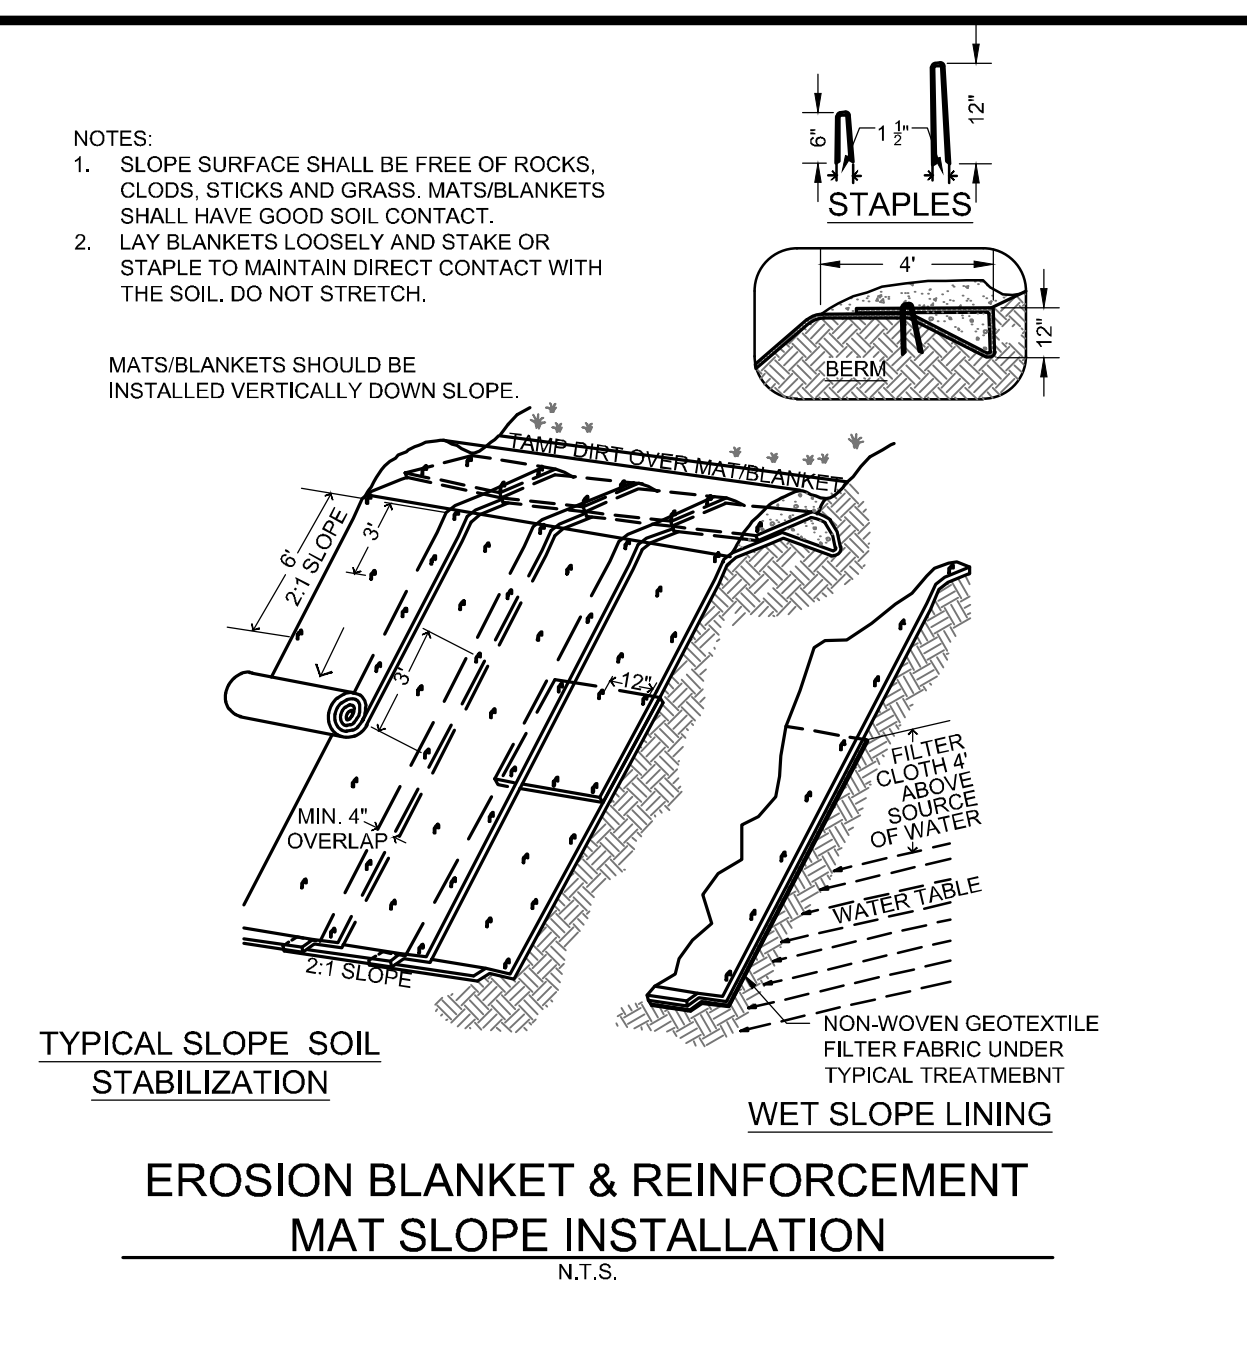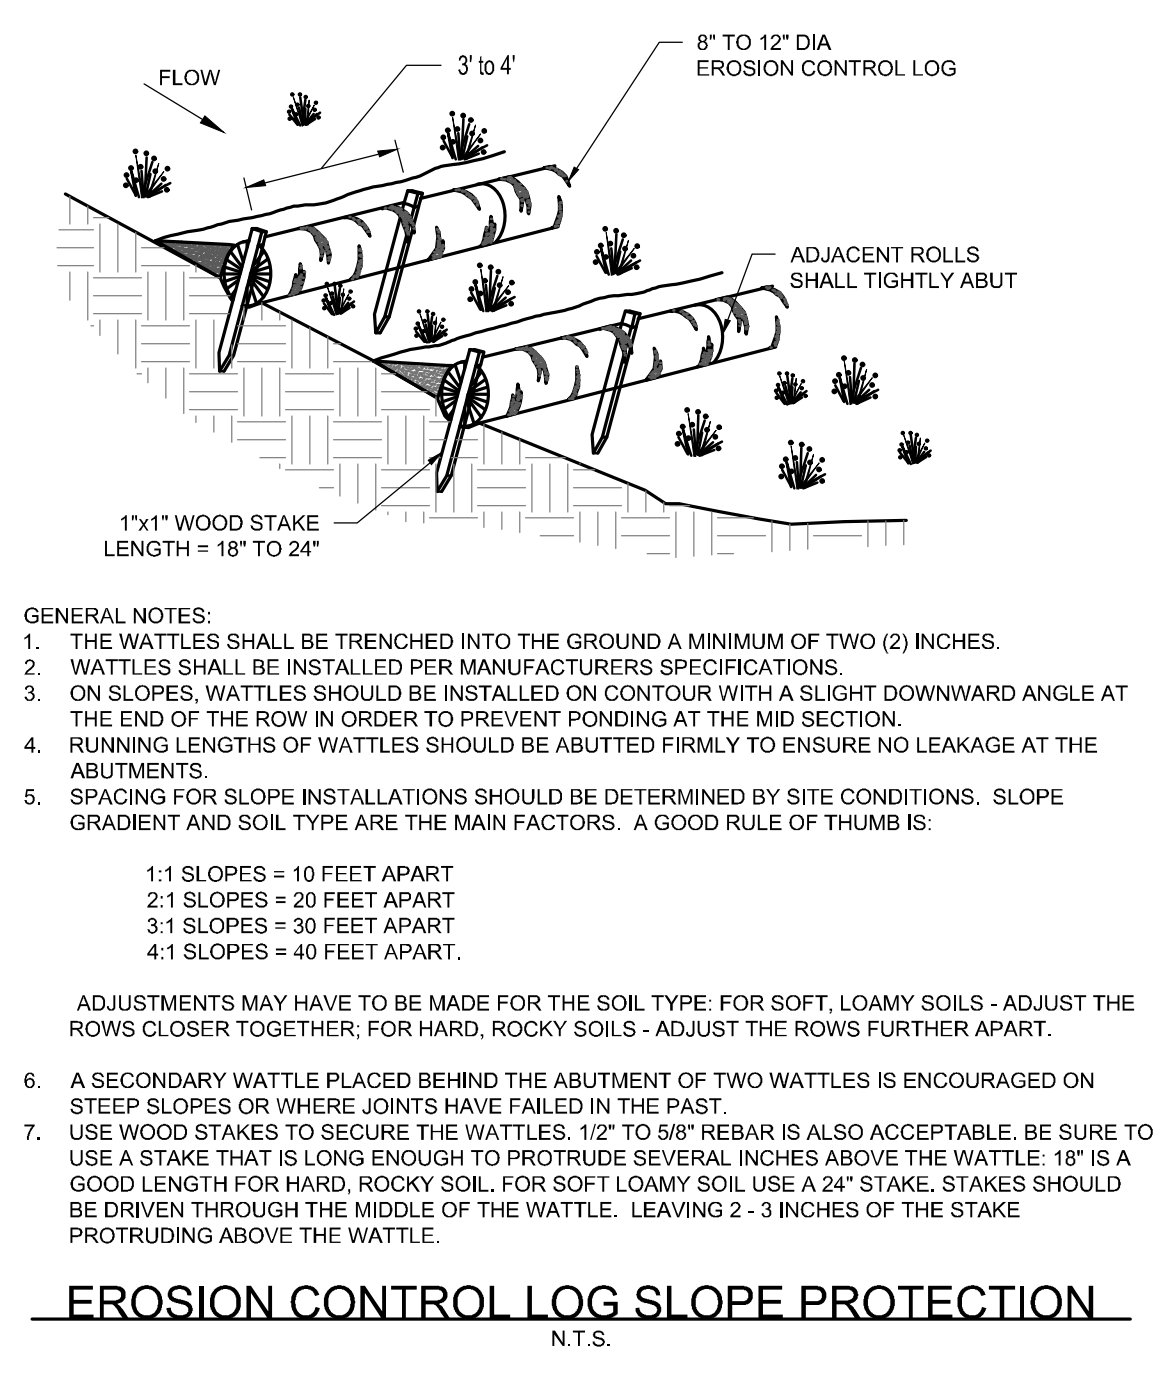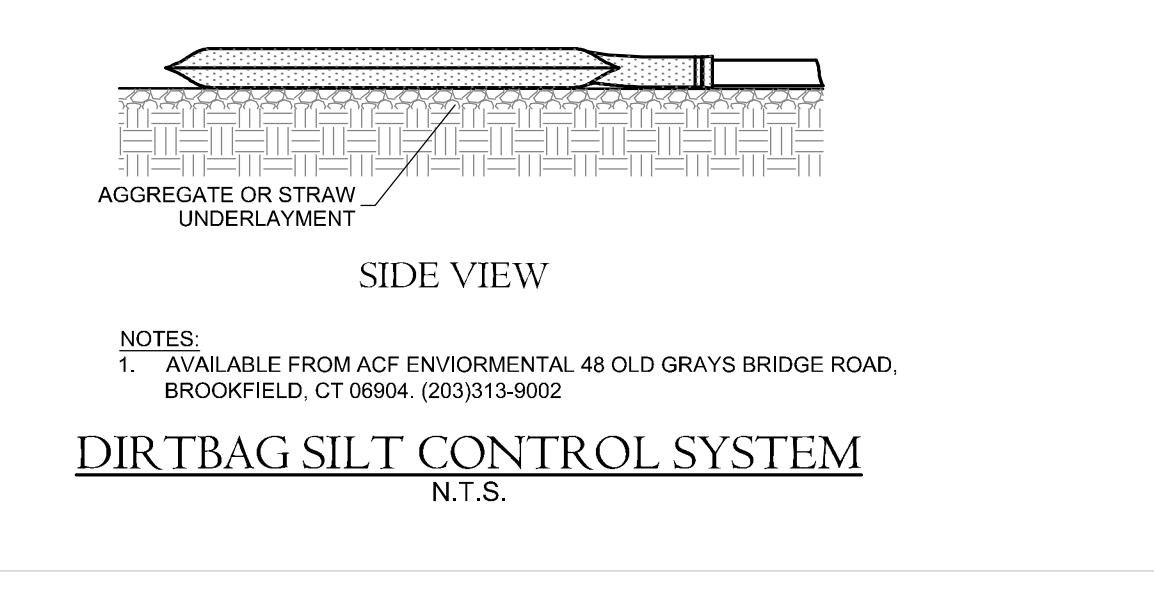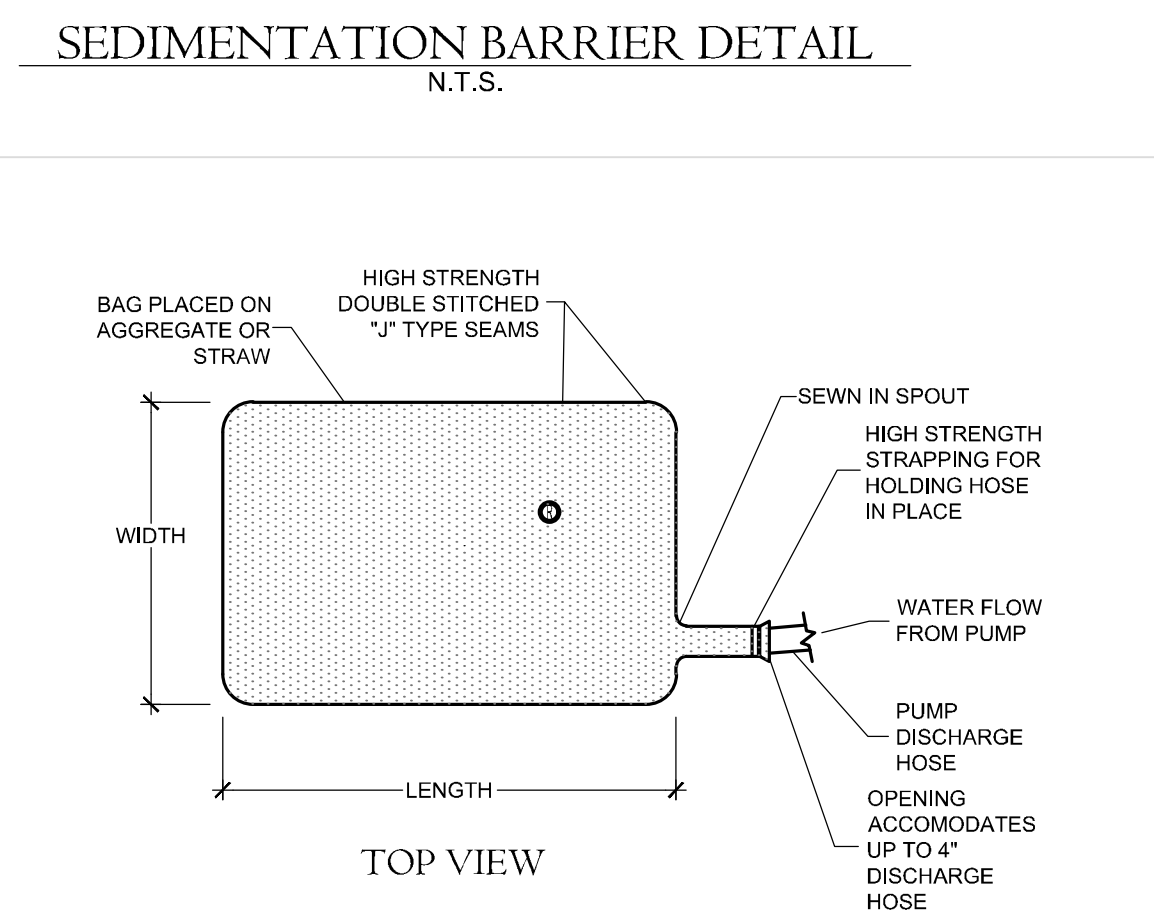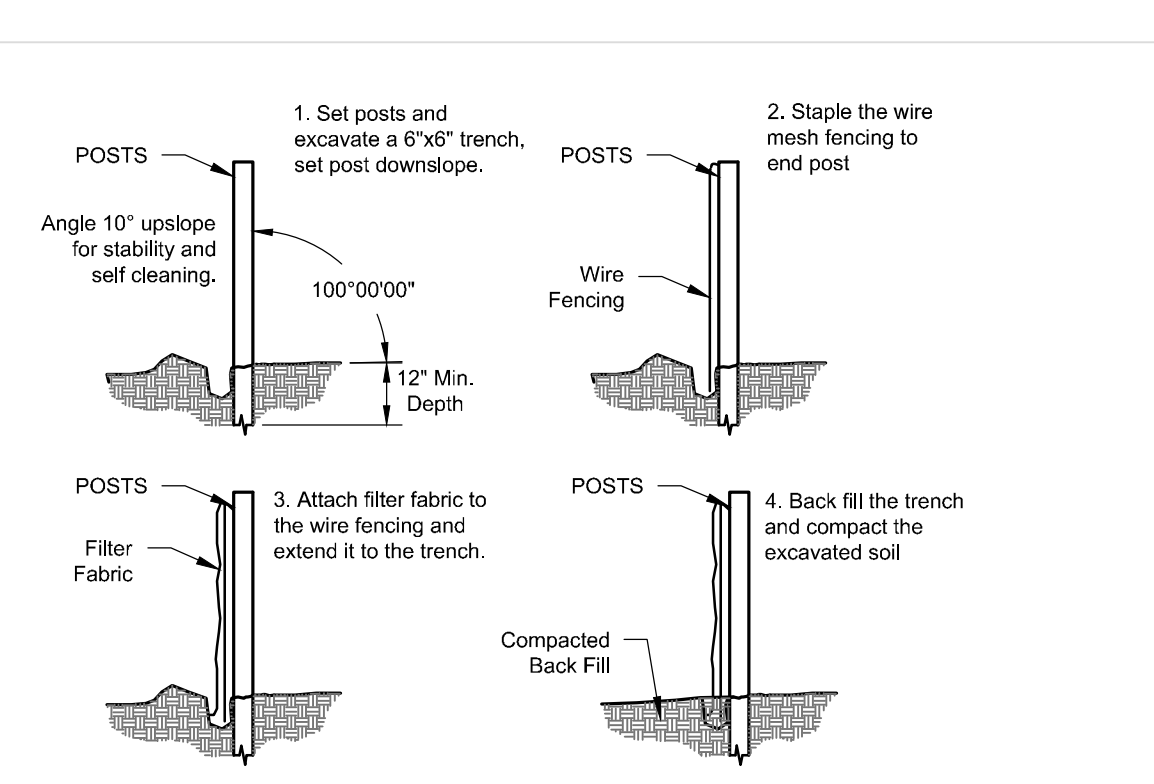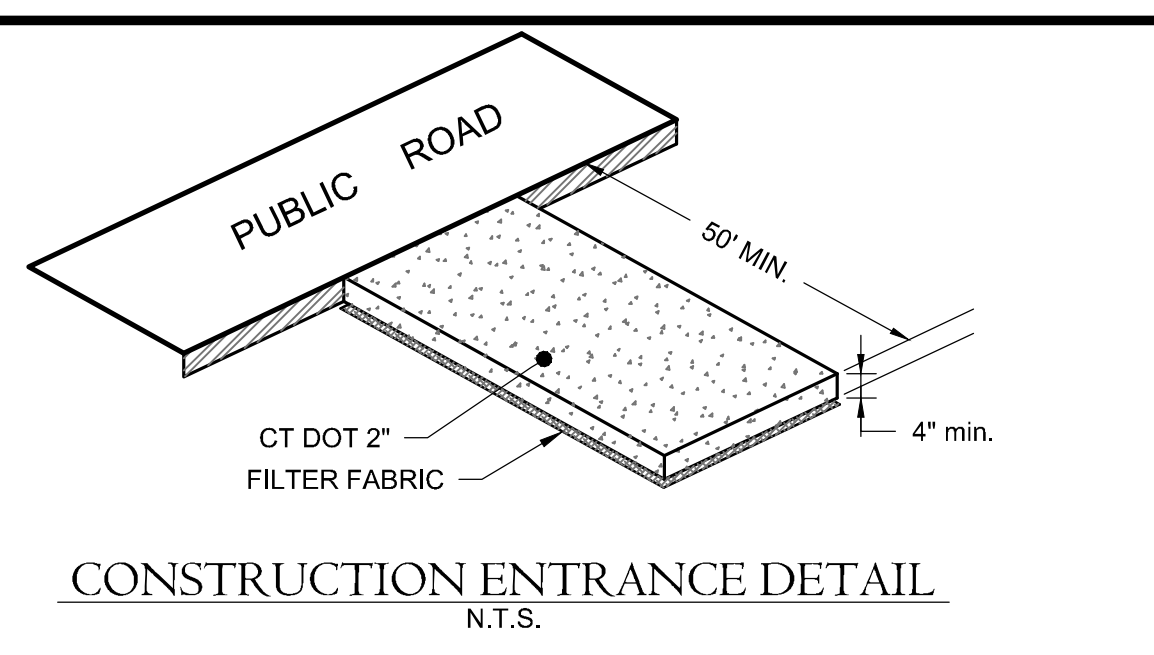

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PROJECT NAME:
**HIGHLAND RIDGE
ACTIVE ADULT
COMMUNITY**

580 Meriden Waterbury Turnpike
Southington, Connecticut

PREPARED FOR:
**AA DENORFIA
BUILDING &
DEVELOPMENT**

Sheet Description:
DETAILS

Scale: N.T.S.

Date: September 1, 2022


Project #: 2235 F.B.#: ---

Drawn By: BTP Approved By: MSL


Revisions:	
Date:	Descriptions:
Sept. 26, 2022	Revised per Town Comments
Oct. 20, 2022	Revised Detention Basin & Water
Oct. 31, 2022	Revised per Town Comments
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Sheet #:
D1

PROJECT NAME: P:\Land Project\2253AA\Drawings\Building & Development\LEED\07-Mech\Waterbury_Turnpike_Southington\CT\Proj\2253-103-1-DWG-CLEAN.dwg
 DATE: 08/21/2022 10:47:51 AM
 DRAWN BY: BTP
 CHECKED BY: BNB
 PROJECT NO: 2253AA

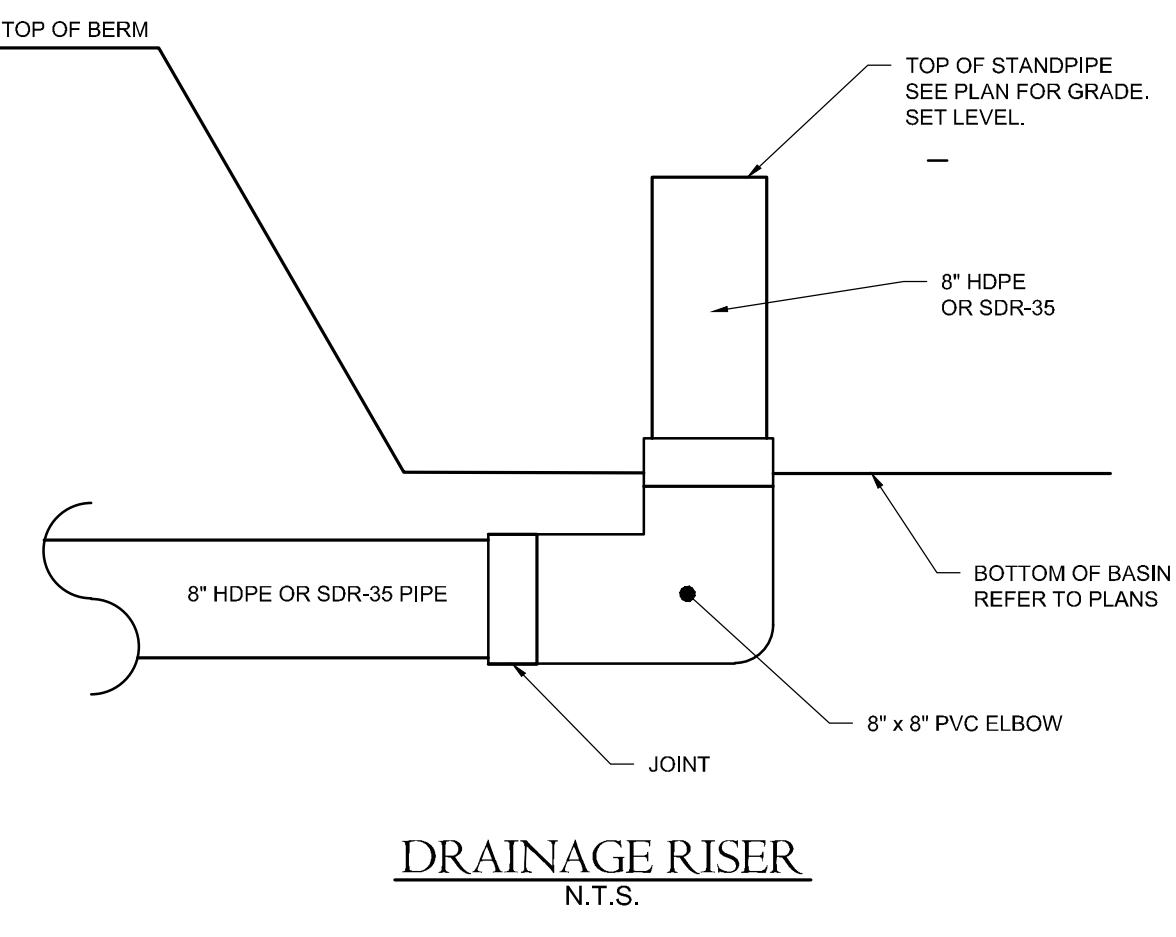


DRAINAGE RISER
N.T.S.

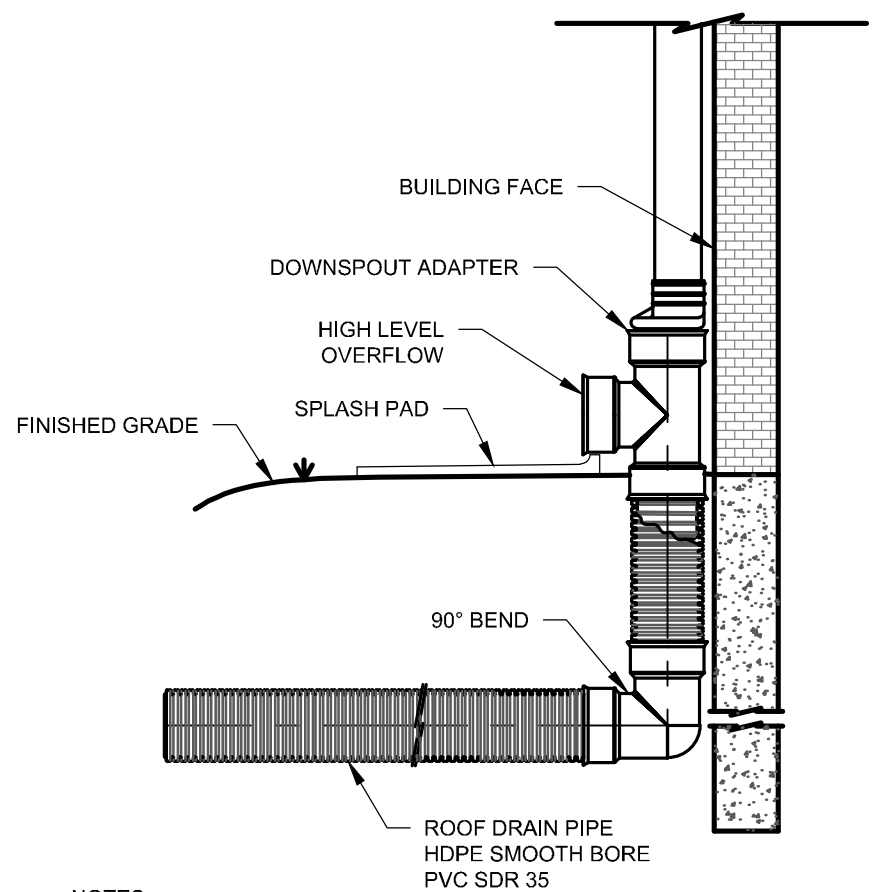

ROOF DRAIN WITH HIGH LEVEL OVERFLOW
N.T.S.

NOTES:
1. JOINTS SHALL BE WATERTIGHT


GENERAL NOTES:
1. JOINTS SHALL BE TONGUE AND GROOVE OR BELL AND SPIGOT AS REQUIRED TO CONFORM TO PIPE INSTALLED.
2. WALL THICKNESS SHALL CONFORM TO PIPE THICKNESS.

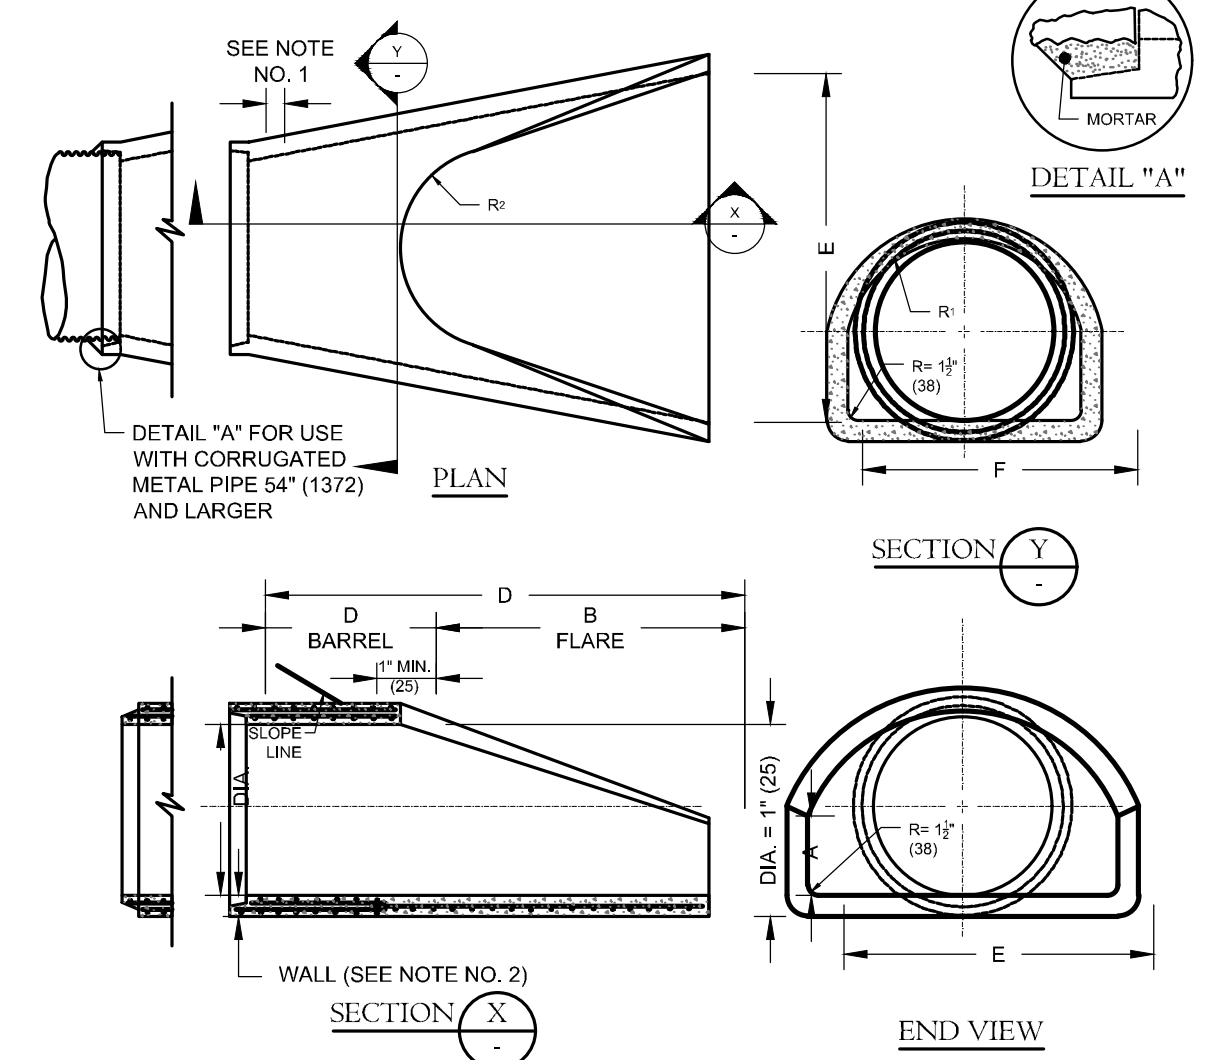

DIMENSIONS FOR REINFORCED CONCRETE CULVERT END										FLARE REINFORCEMENT	
DIA.	A	B	C	D	E	F	R ₁	R ₂	MIN. AREA OF LONGITUDINAL STEEL SQ. IN. PER FT.	MIN. AREA OF TRANSVERSE STEEL SQ. IN. PER FT.	MIN. AREA OF TRANSVERSE STEEL SQ. IN. PER FT.
12(305)	4(102)	2(476)	4(02124)	6(02185)	2(01650)	1(00750)	1(02360)	1(0220)	0.048	0.048	0.048
15(381)	6(152)	2(569)	3(01188)	6(11854)	2(01782)	1(02318)	1(02318)	1(1272)	0.064	0.064	0.064
18(457)	8(229)	2(698)	3(01188)	6(11854)	2(01914)	2(01737)	1(03384)	1(0350)	0.080	0.080	0.080
21(533)	9(229)	2(1189)	3(21865)	6(11854)	2(01186)	2(01300)	1(1320)	1(1320)	0.096	0.096	0.096
24(610)	9(241)	3(07115)	2(01762)	6(01186)	4(01219)	2(01364)	1(0427)	1(0360)	0.112	0.112	0.112
30(762)	1(07305)	4(01371)	1(07802)	6(11873)	5(01524)	3(01940)	1(0470)	1(0381)	0.144	0.144	0.144
36(914)	1(07381)	6(011600)	2(10285)	6(11248)	6(01243)	3(011214)	2(01018)	1(0366)	0.192	0.192	0.192
42(1067)	1(07334)	6(011600)	2(11088)	6(01248)	6(01181)	3(01099)	1(0366)	1(0366)	0.240	0.240	0.240
48(1218)	2(0740)	6(011600)	2(21660)	6(01248)	7(01214)	4(01435)	2(01724)	1(07559)	0.320	0.320	0.320
54(1372)	2(07686)	6(011600)	2(11889)	6(012540)	7(01228)	5(01184)	2(0184)	2(01810)	0.432	0.432	0.432
60(1524)	2(07938)	6(011600)	3(01891)	6(012615)	8(012438)	6(01184)	3(01810)	2(01810)	0.576	0.576	0.576


REINFORCED CONCRETE CULVERT END
N.T.S.

NOTES:
1. FOR UNSHEETED TRENCH WHERE PIPE O.D. IS 6\"/>

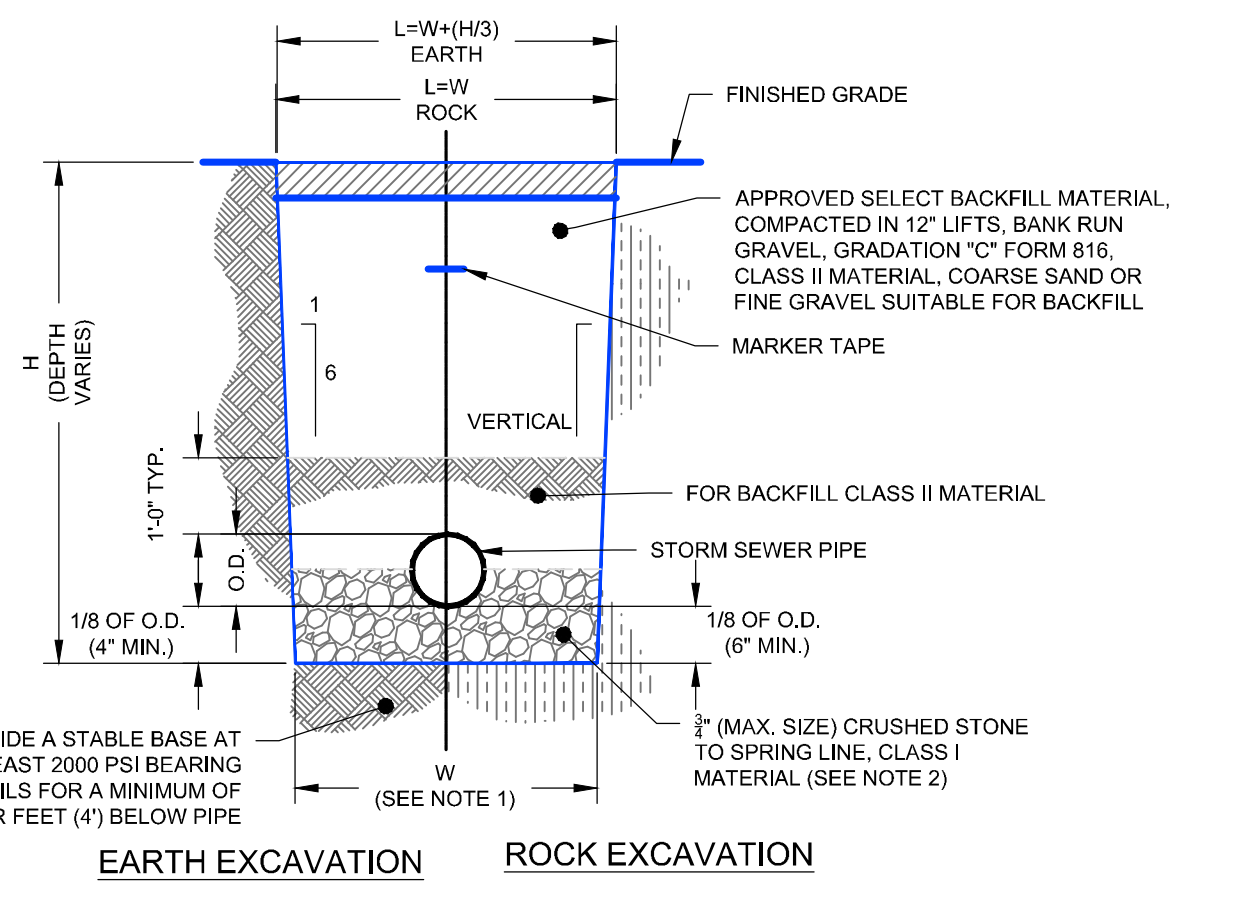


STORM CLASS 'C' TRENCH DETAIL
N.T.S.

NOTES:
1. SITE PREPARATION: GRADE SURFACE OF INSTALLATION AREAS SO GROUND IS SMOOTH AND COMPACT. REMOVE ALL ROCKS, ROOTS AND OTHER OBSTRUCTIONS FROM LYING IN DIRECT CONTACT WITH THE SOIL SURFACE AND THE MAT.
2. PROVIDE 4\"/>

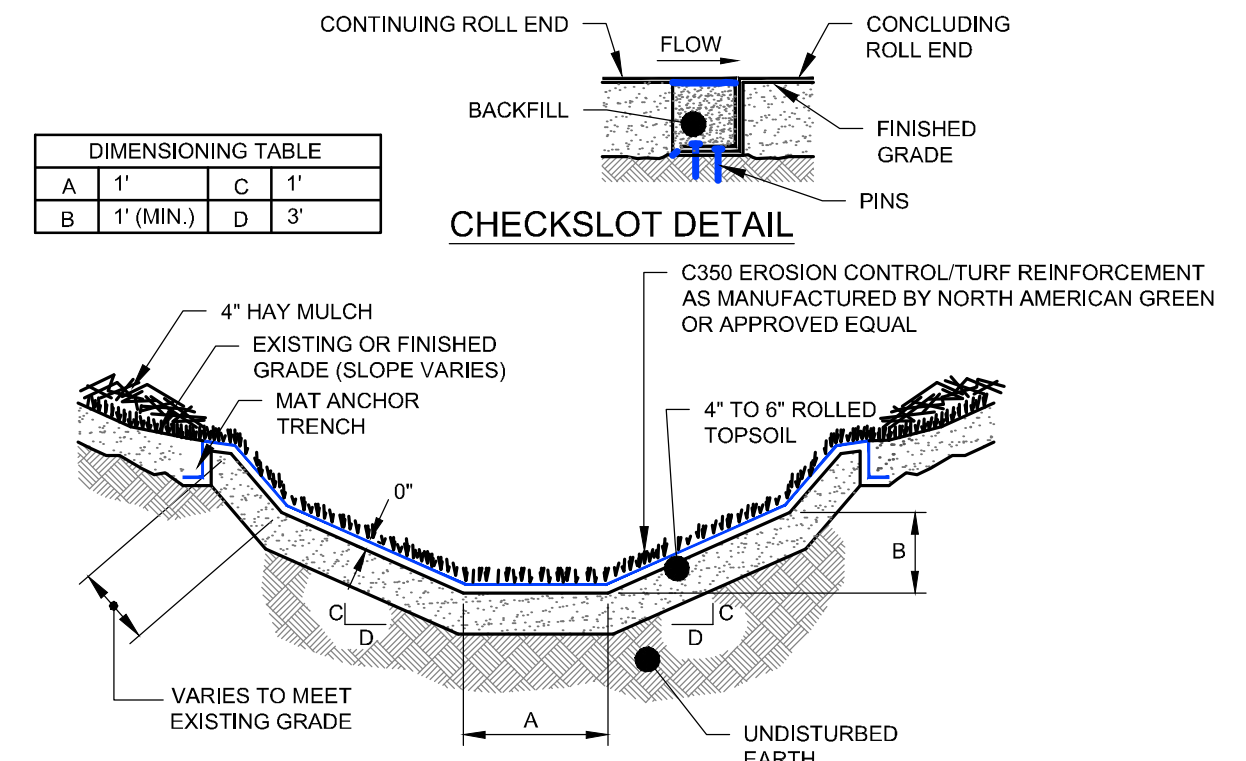



REINFORCED GRASS LINED SWALE DETAIL
N.T.S.

DIMENSIONING TABLE			
A	C	B	D
1'	1'	1'	3'

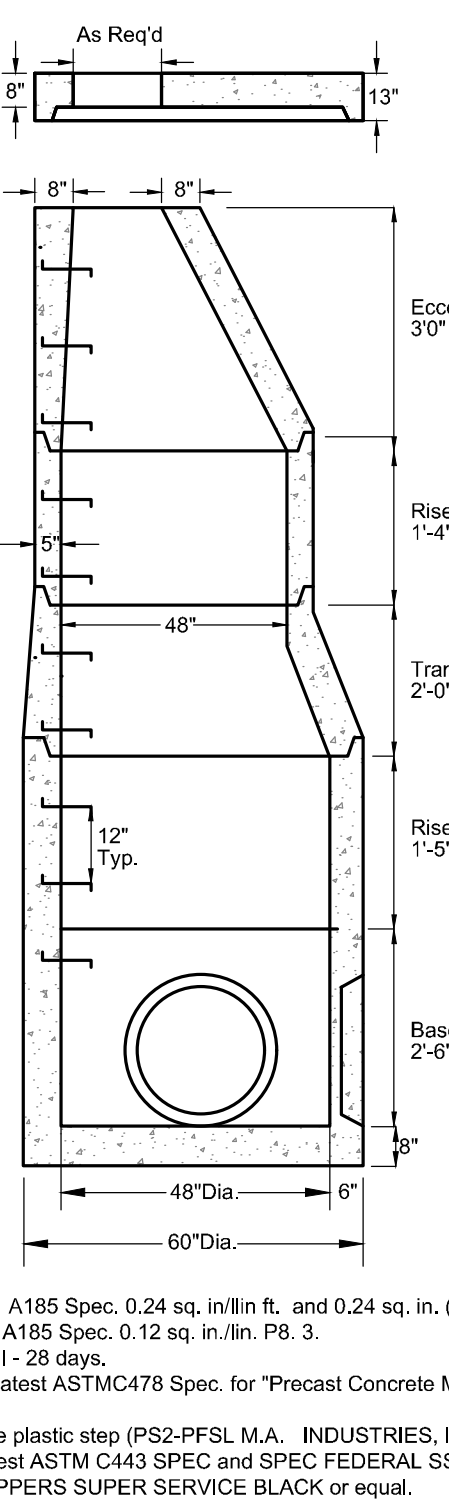

NOTES:
1. Reinforcing steel conforms to latest ASTM A193 Spec. 0.24 sq. in./in. ft. and 0.24 sq. in. (both ways) base bottom. Flat slab tops for AASHTO H20-44.
2. Reinforcing steel conforms to latest ASTM A193 Spec. 0.12 sq. in./in. Pb. 3.
3. Concrete compressive strength - 4,000 PSI - 28 days.
4. Manhole design specifications conform to latest ASTM C478 Spec. for "Precast Concrete Manhole Sections".
5. One pour monolithic base.
6. Steel Reinforced Copolymer Polypropylene plastic sheet (PS2-PFSL M.A. INDUSTRIES, INC.) conforms to latest ASTM C478 PARA-11.
7. Butyl Rubber Section Joint conforms to latest ASTM C443 SPEC and SPEC FEDERAL SS-S-210A.
8. When specified Manholes coated with KOPPERS SUPER SERVICE BLACK or equal.


STORMWATER PRECAST CONCRETE MANHOLE DETAIL
N.T.S.

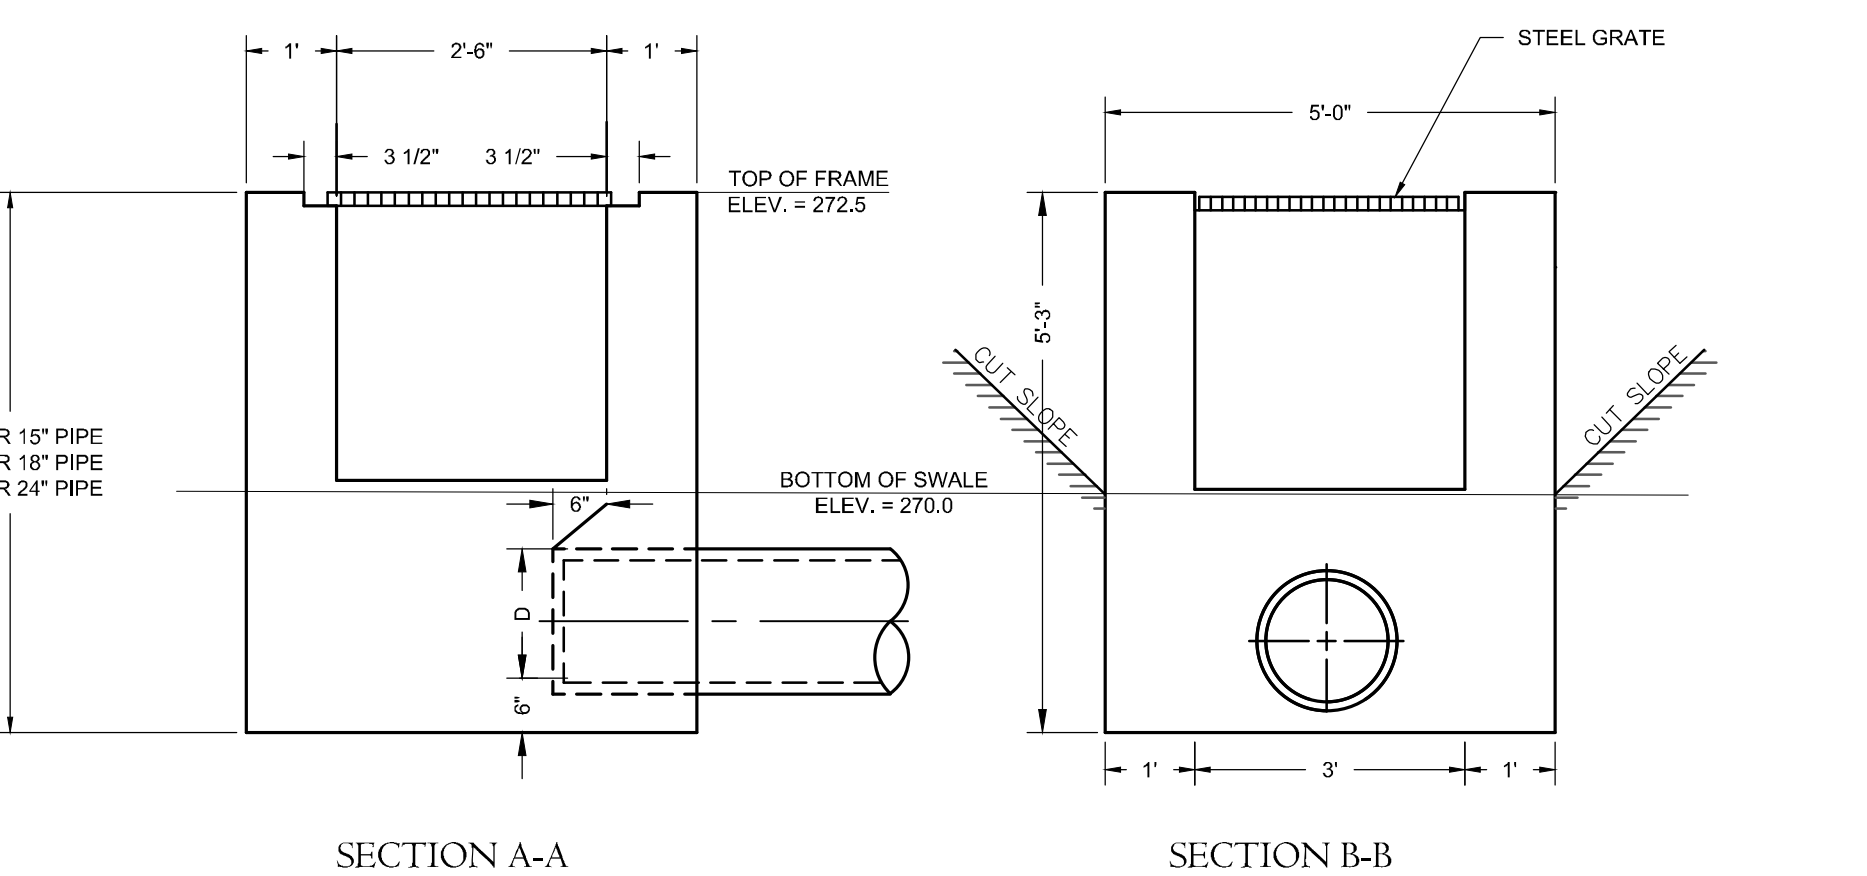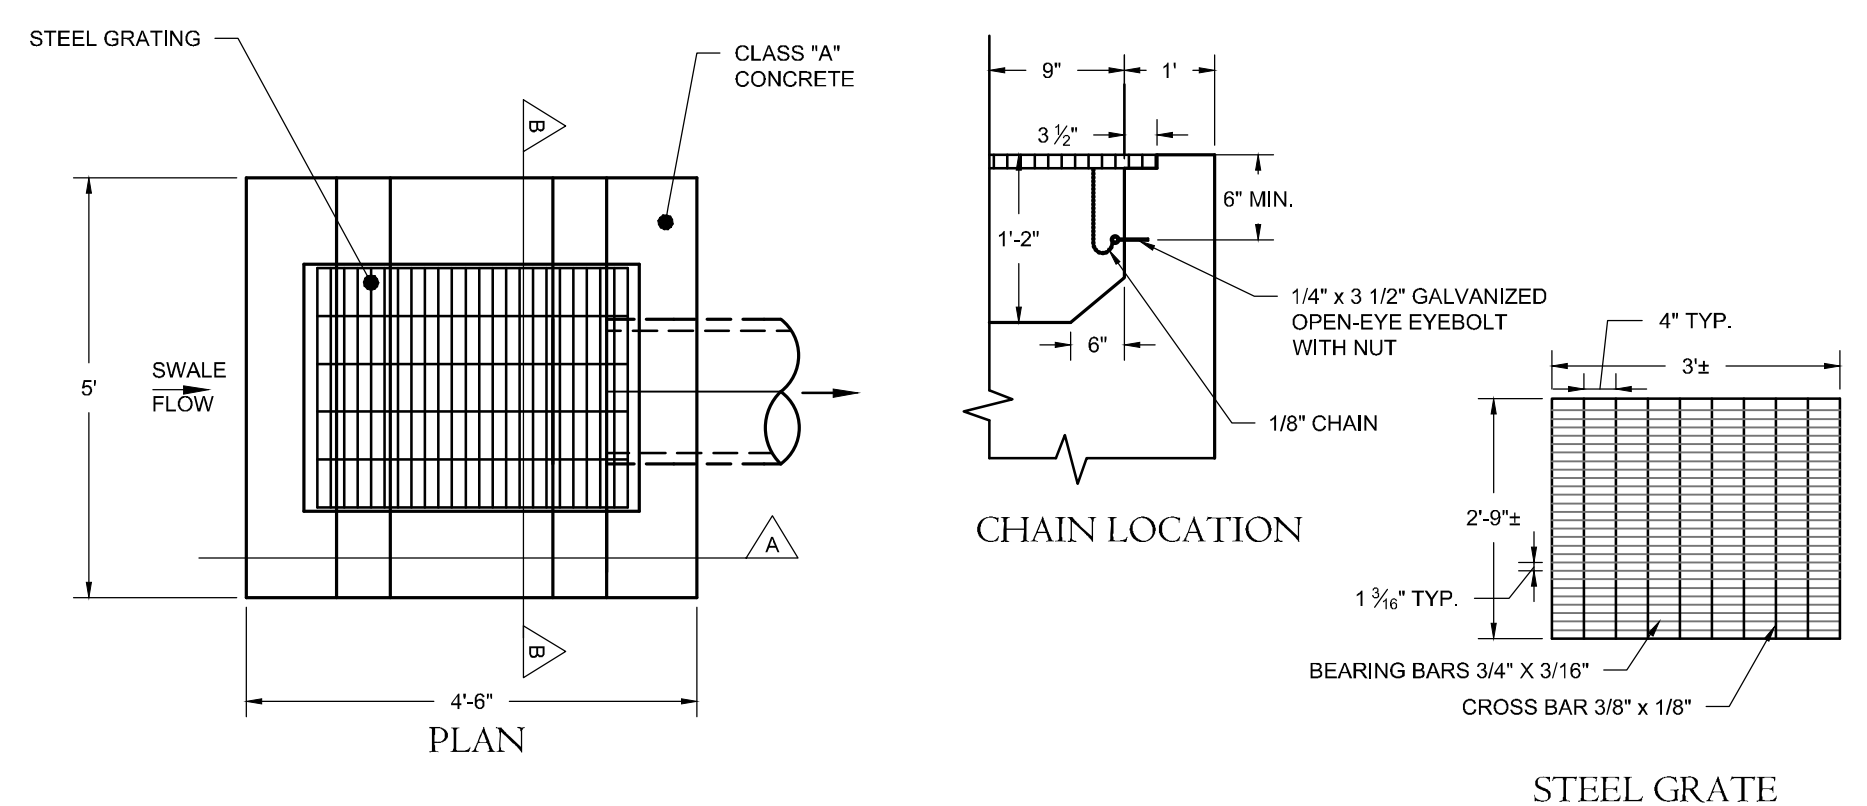


SECTION A-A **SECTION B-B**

NOTES:
1. All exposed surfaces corners shall be chamfered.
2. Steel grating shall be mechanically locked under hydraulic pressure, welded, or electroforged.
3. Steel grate shall be galvanized in accordance with CONN. DOT. M 06.03.

D-G ENDWALL DETAIL
N.T.S.

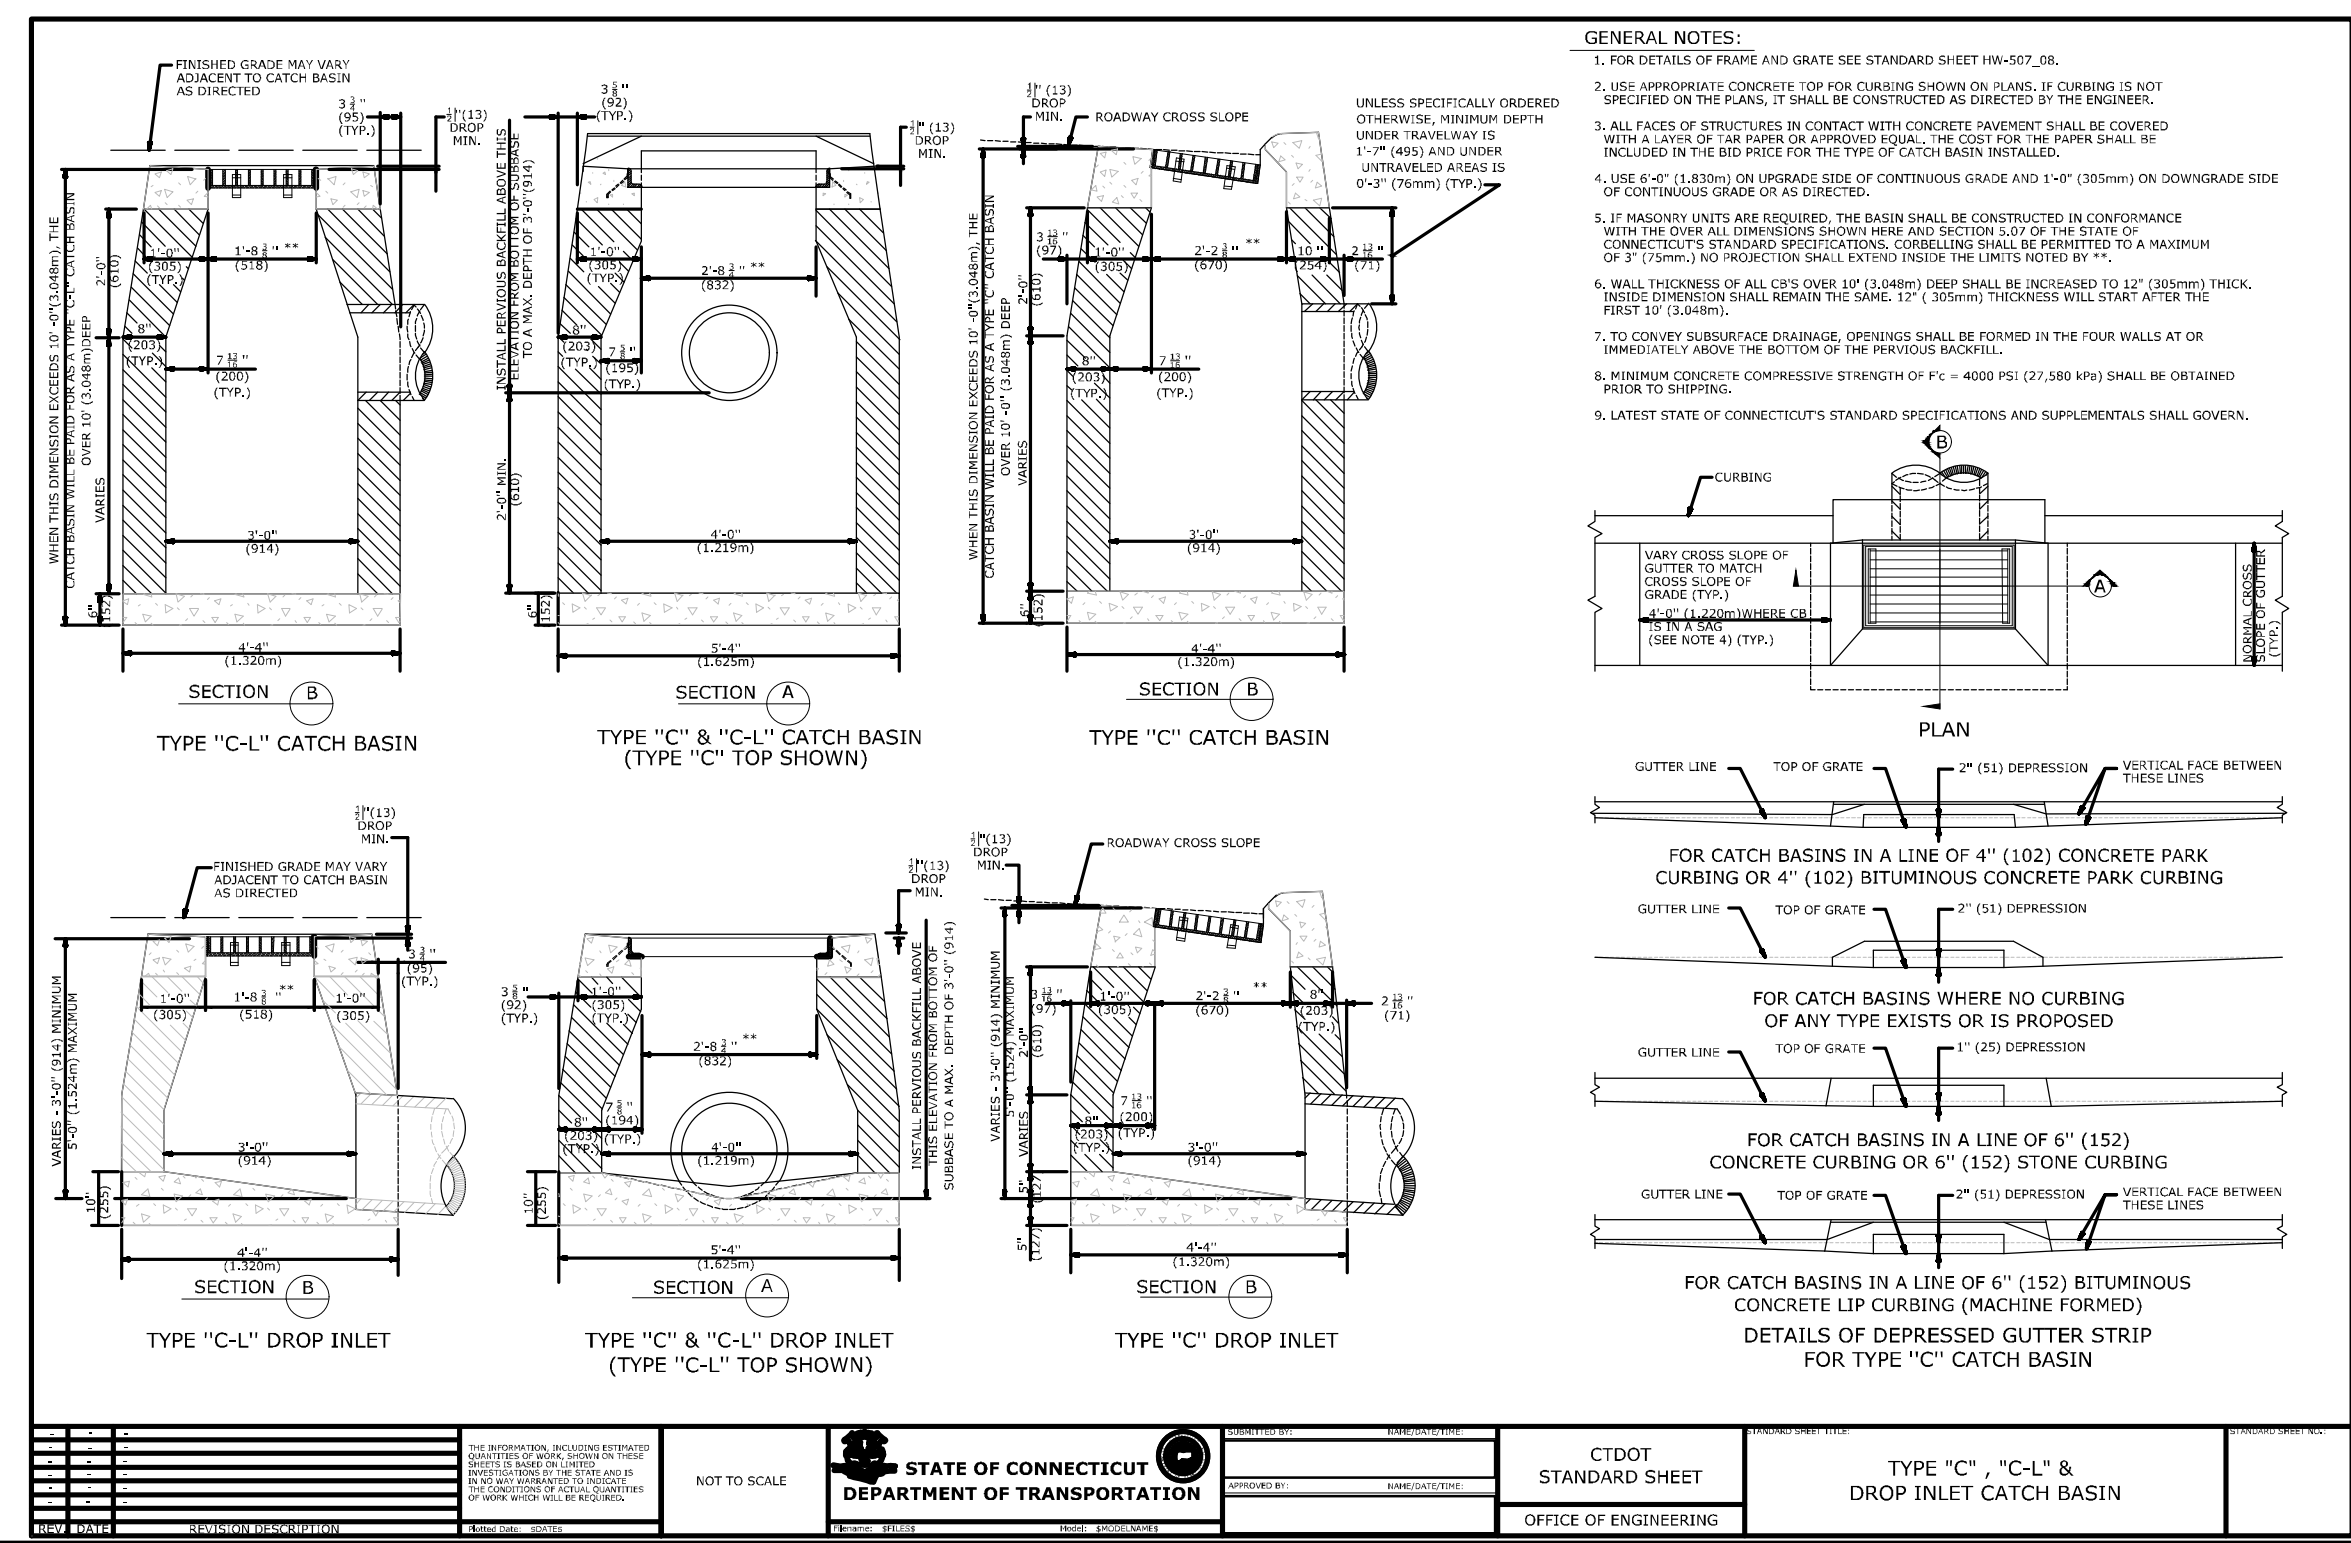

TYPE 'C', 'C-L' & DROP INLET CATCH BASIN

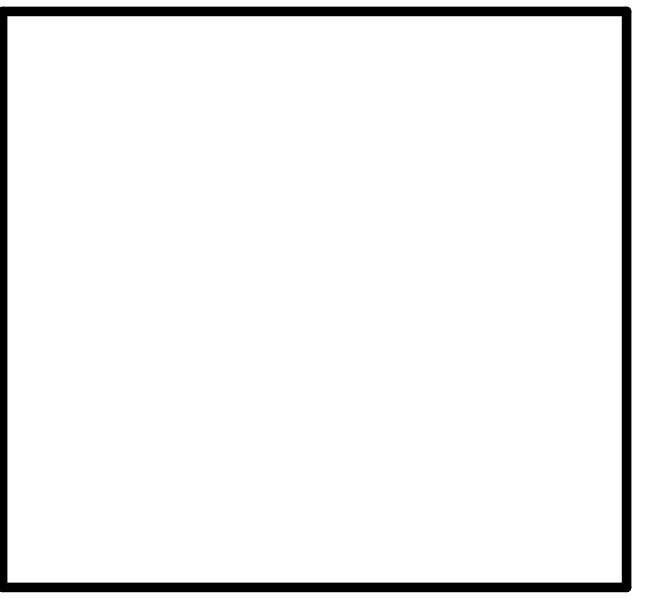

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PROJECT NAME:
HIGHLAND RIDGE
ACTIVE ADULT
COMMUNITY

580 Meriden Waterbury Turnpike
Southington, Connecticut

PREPARED FOR:
AA DENORFIA
BUILDING &
DEVELOPMENT

Sheet Description:
DETAILS

Scale:
N.T.S.

Date: September 1, 2022

Project #: 2235 F.B. #: ---


Drawn By: BTP Approved By: BNB

Date:	Descriptions:
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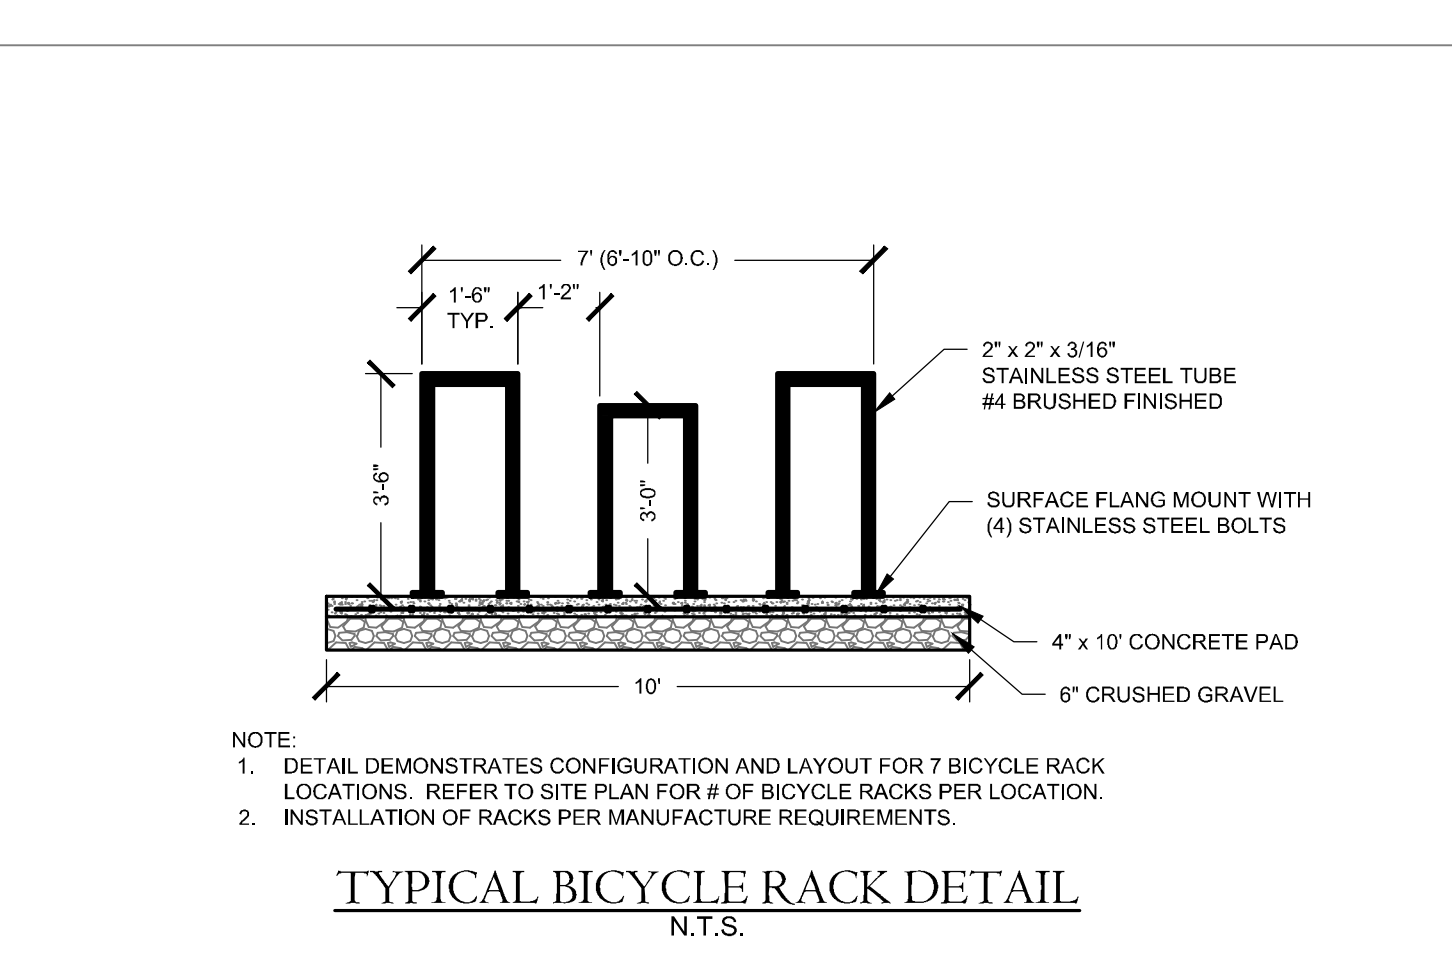
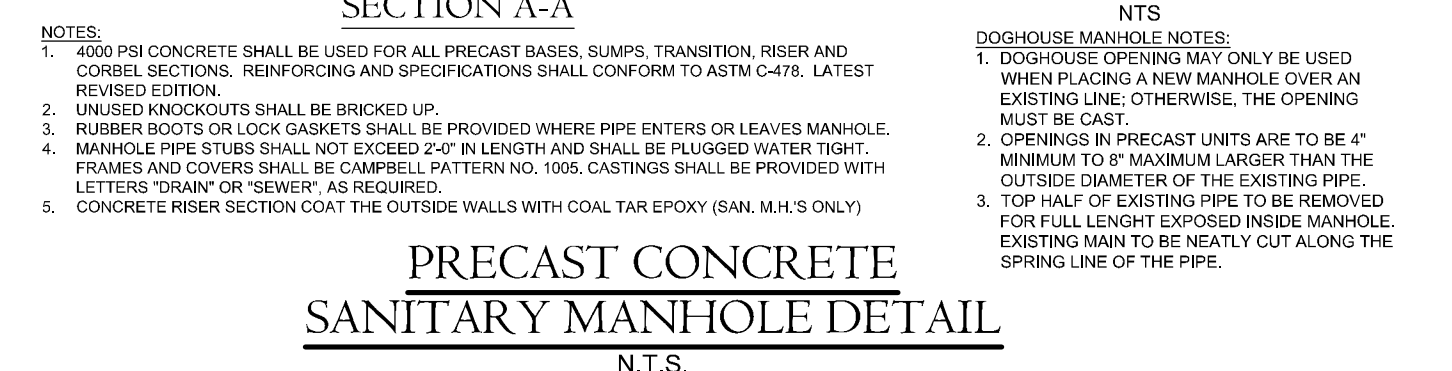
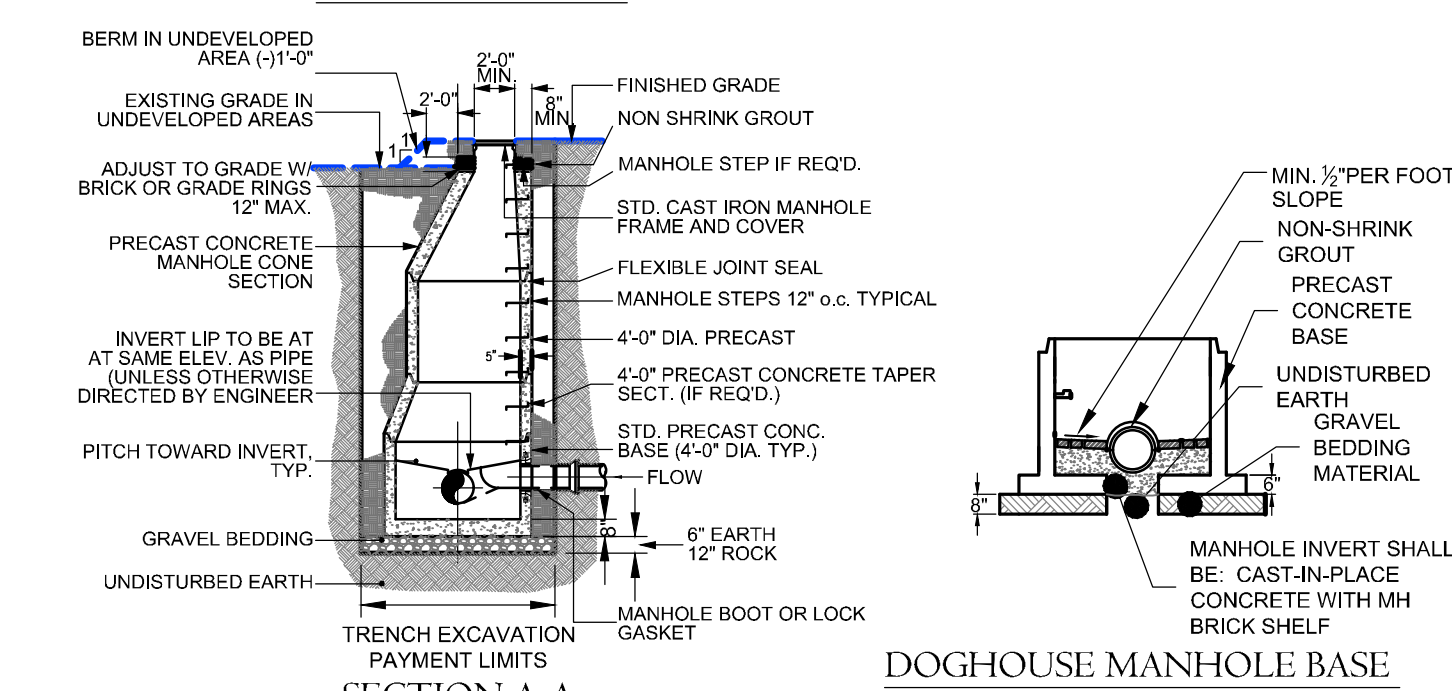
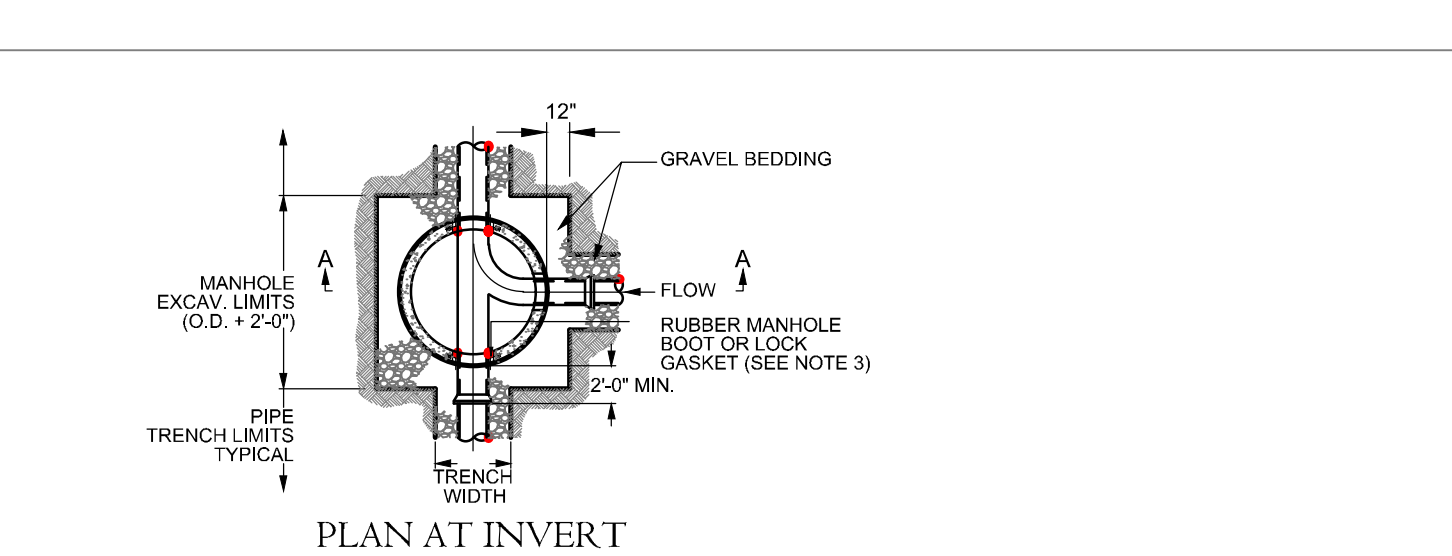
Sheet #:
D2

DRAWING NAME: [Project Name] Location: [Location] Date: [Date] Designer: [Designer] Checker: [Checker] Project No: [Project No]


- NOTES:**
- FOR UNSHIELDED TRENCH WHERE PIPE O.D. IS 6" OR LESS THAN, PAYMENT WIDTH (W) = 2'-6"; WHERE PIPE O.D. IS GREATER THAN 6" BUT LESS THAN OR EQUAL TO 36" THEN, W = O.D. + 2'-0"; WHERE PIPE O.D. IS GREATER THAN 36" THEN, W = O.D. + 2'-6".
 - IF SUITABLE GRANULAR PIPE BEDDING MATERIAL IS AVAILABLE FROM ON-SITE EXCAVATIONS, IT SHALL BE UTILIZED PROVIDED IT CONFORMS WITH THE "STANDARD SPECIFICATIONS", AND IS APPROVED BY THE ENGINEER. NO PAYMENT SHALL BE MADE FOR THIS MATERIAL.
 - TYPICAL FOR ALL FLEXIBLE PIPE MATERIALS, I.E. PVC, CCP, POLYETHYLENE, FRP, AND ABS TRUSS.
 - SHEETING OR SHORING OF TRENCH WALLS, WHERE UNSUITABLE CONDITIONS EXIST, IS THE SOLE RESPONSIBILITY OF THE CONTRACTOR.
 - FOR ROCK REMOVAL DEPTHS GREATER THAN 10', INCREASE PAYMENT WIDTH (W) BY 6". REMOVAL DEPTH SHALL BE MEASURED FROM THE TOP OF EXPOSED SURFACE.

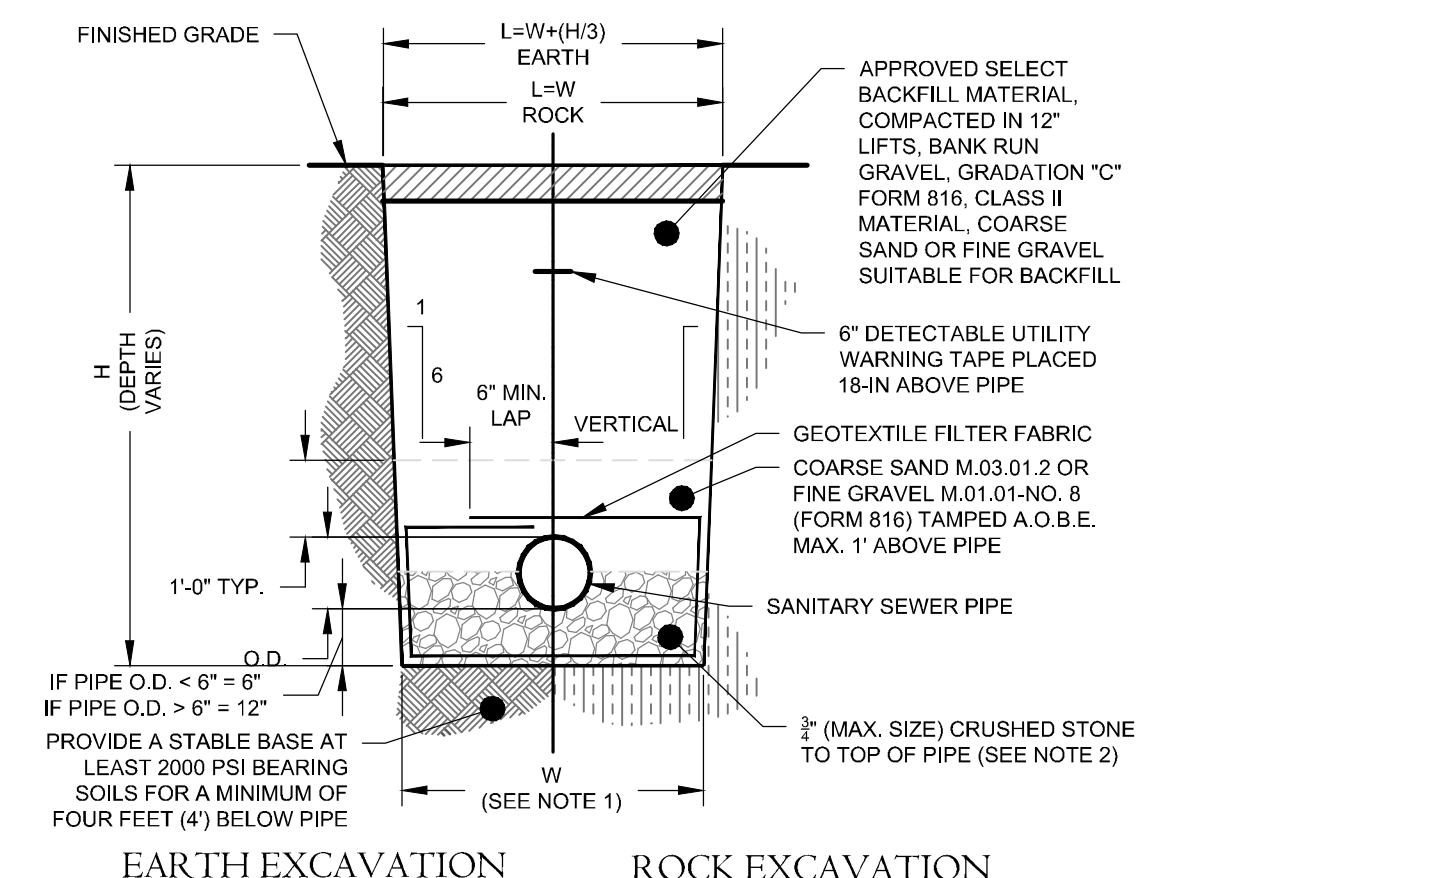



SANITARY CLASS 'B' TRENCH DETAIL
N.T.S.




TYPICAL BICYCLE RACK DETAIL
N.T.S.

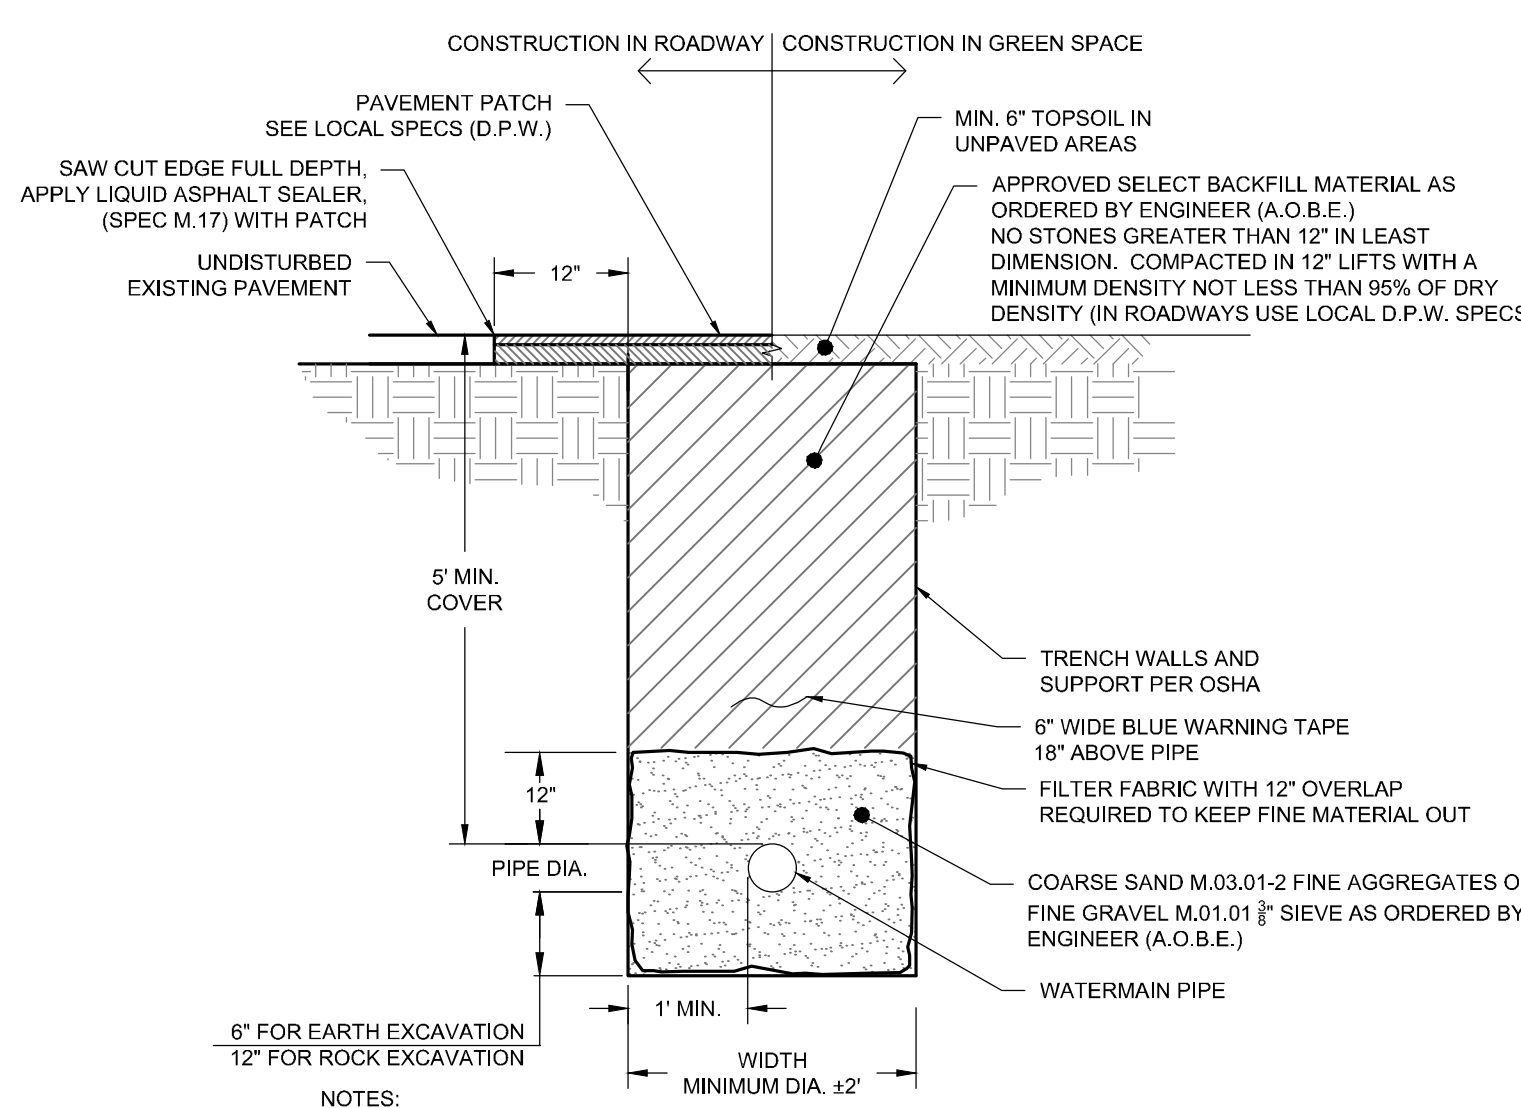


TYPICAL WATERMAIN TRENCH
N.T.S.

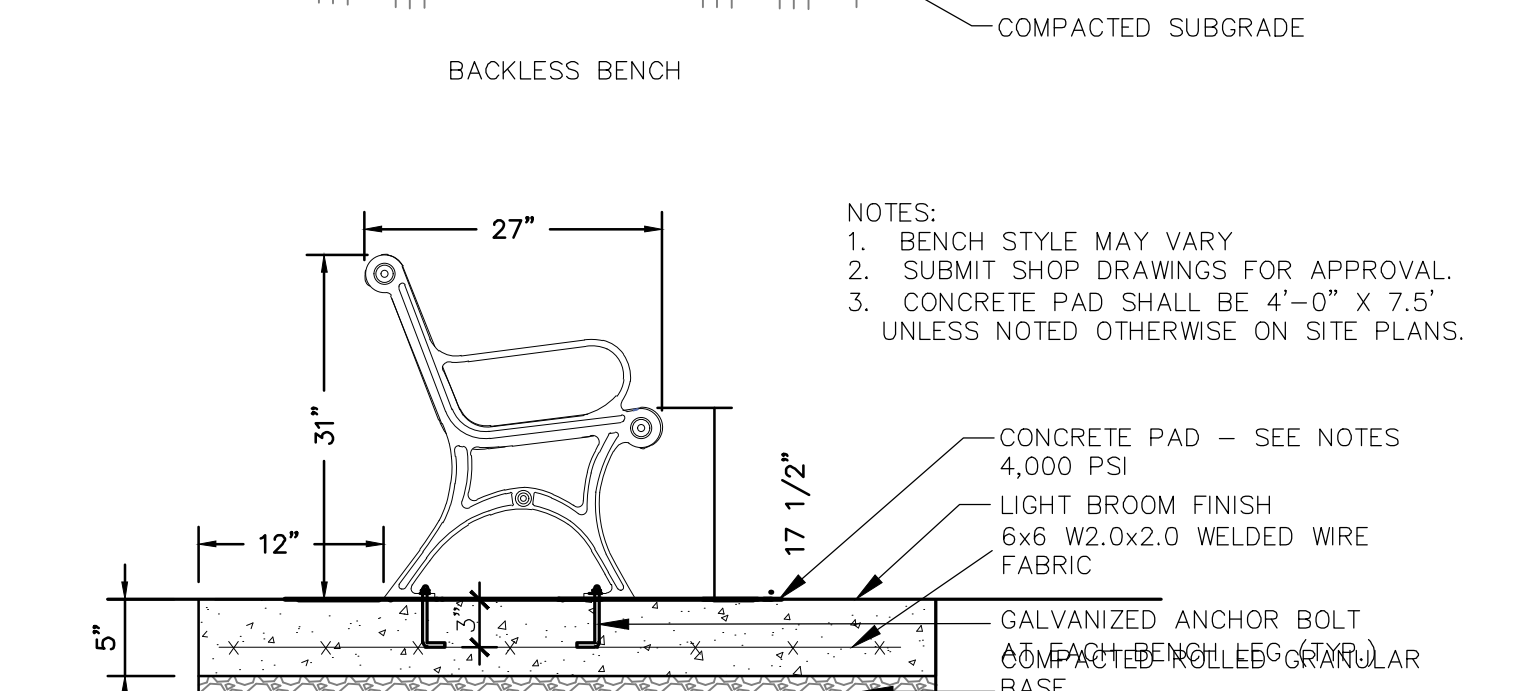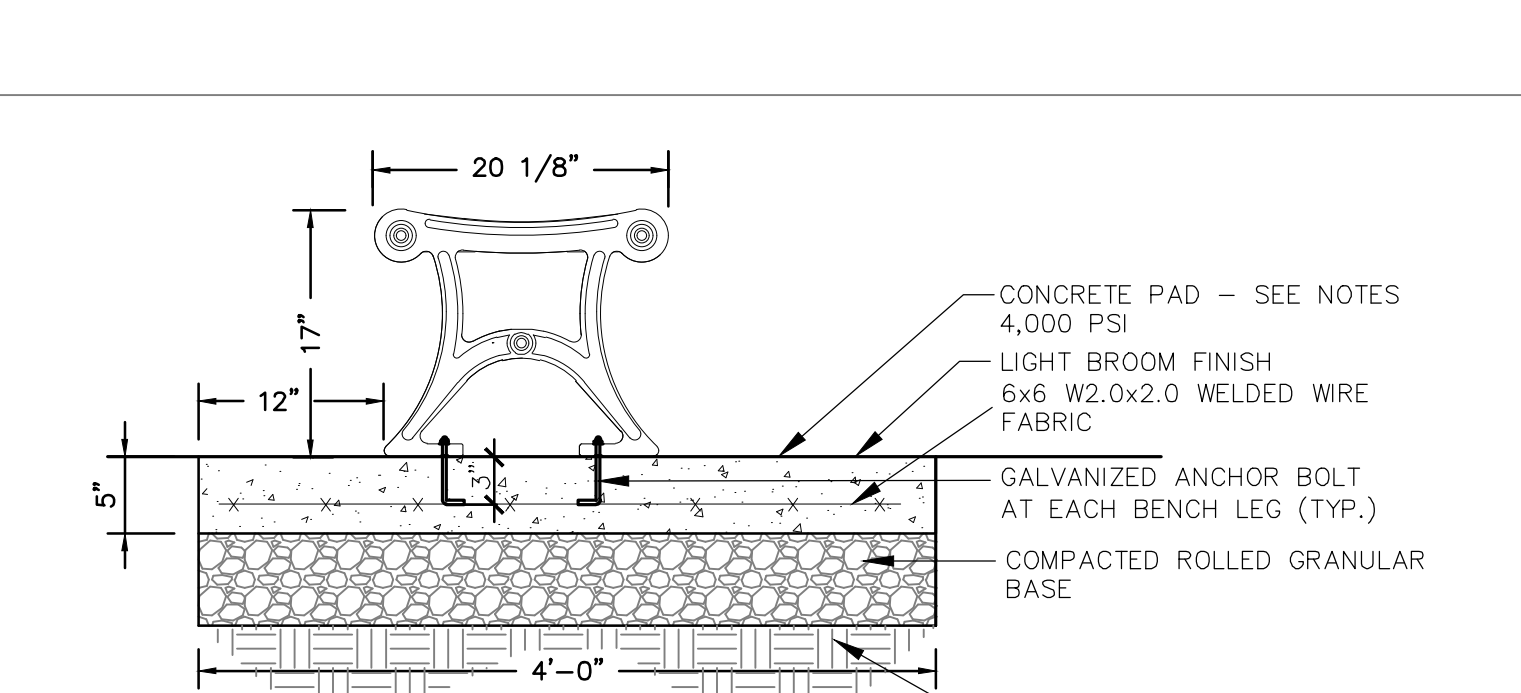




BENCH ON CONCRETE PAD DETAIL
N.T.S.

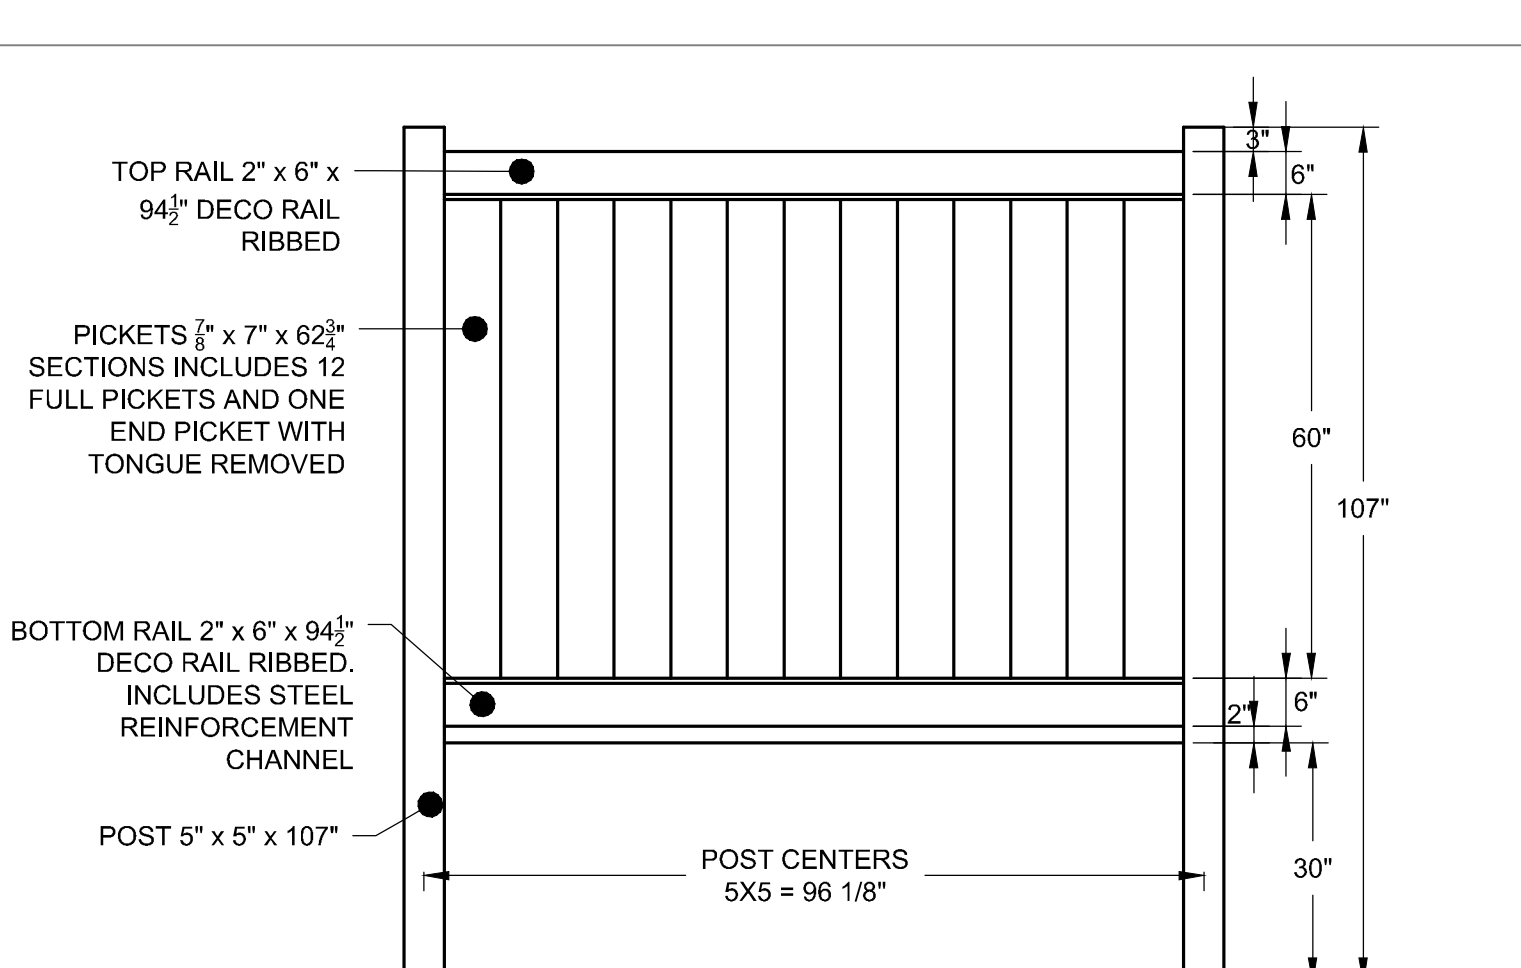



TYPICAL VINYL PRIVACY FENCE DETAIL
N.T.S.

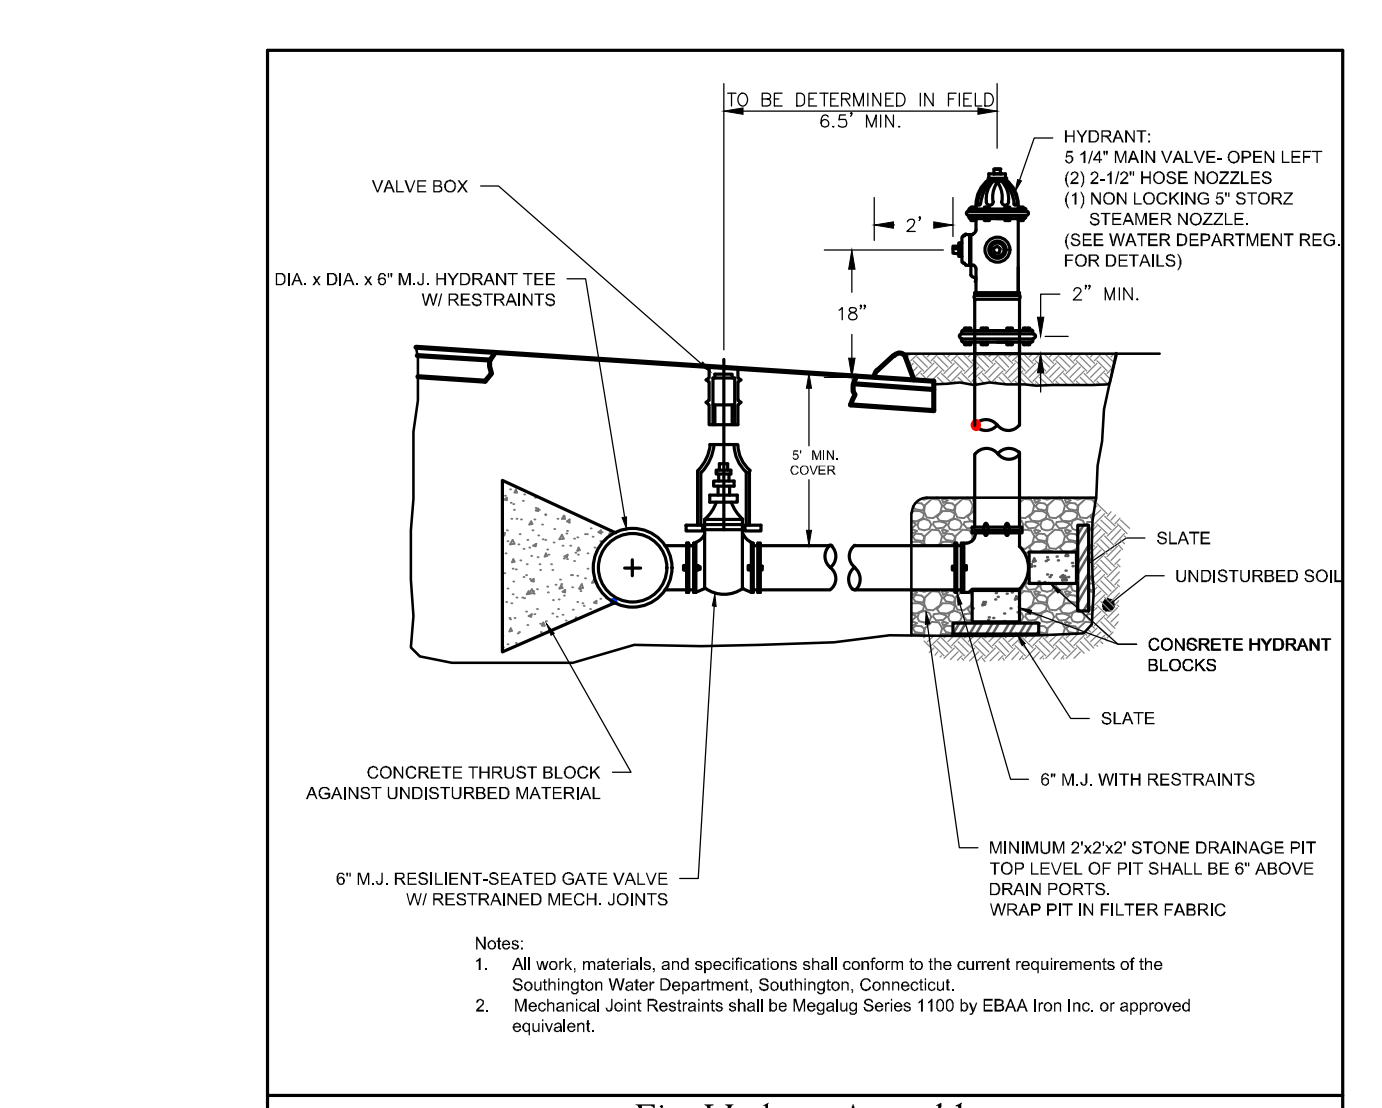

Fire Hydrant Assembly

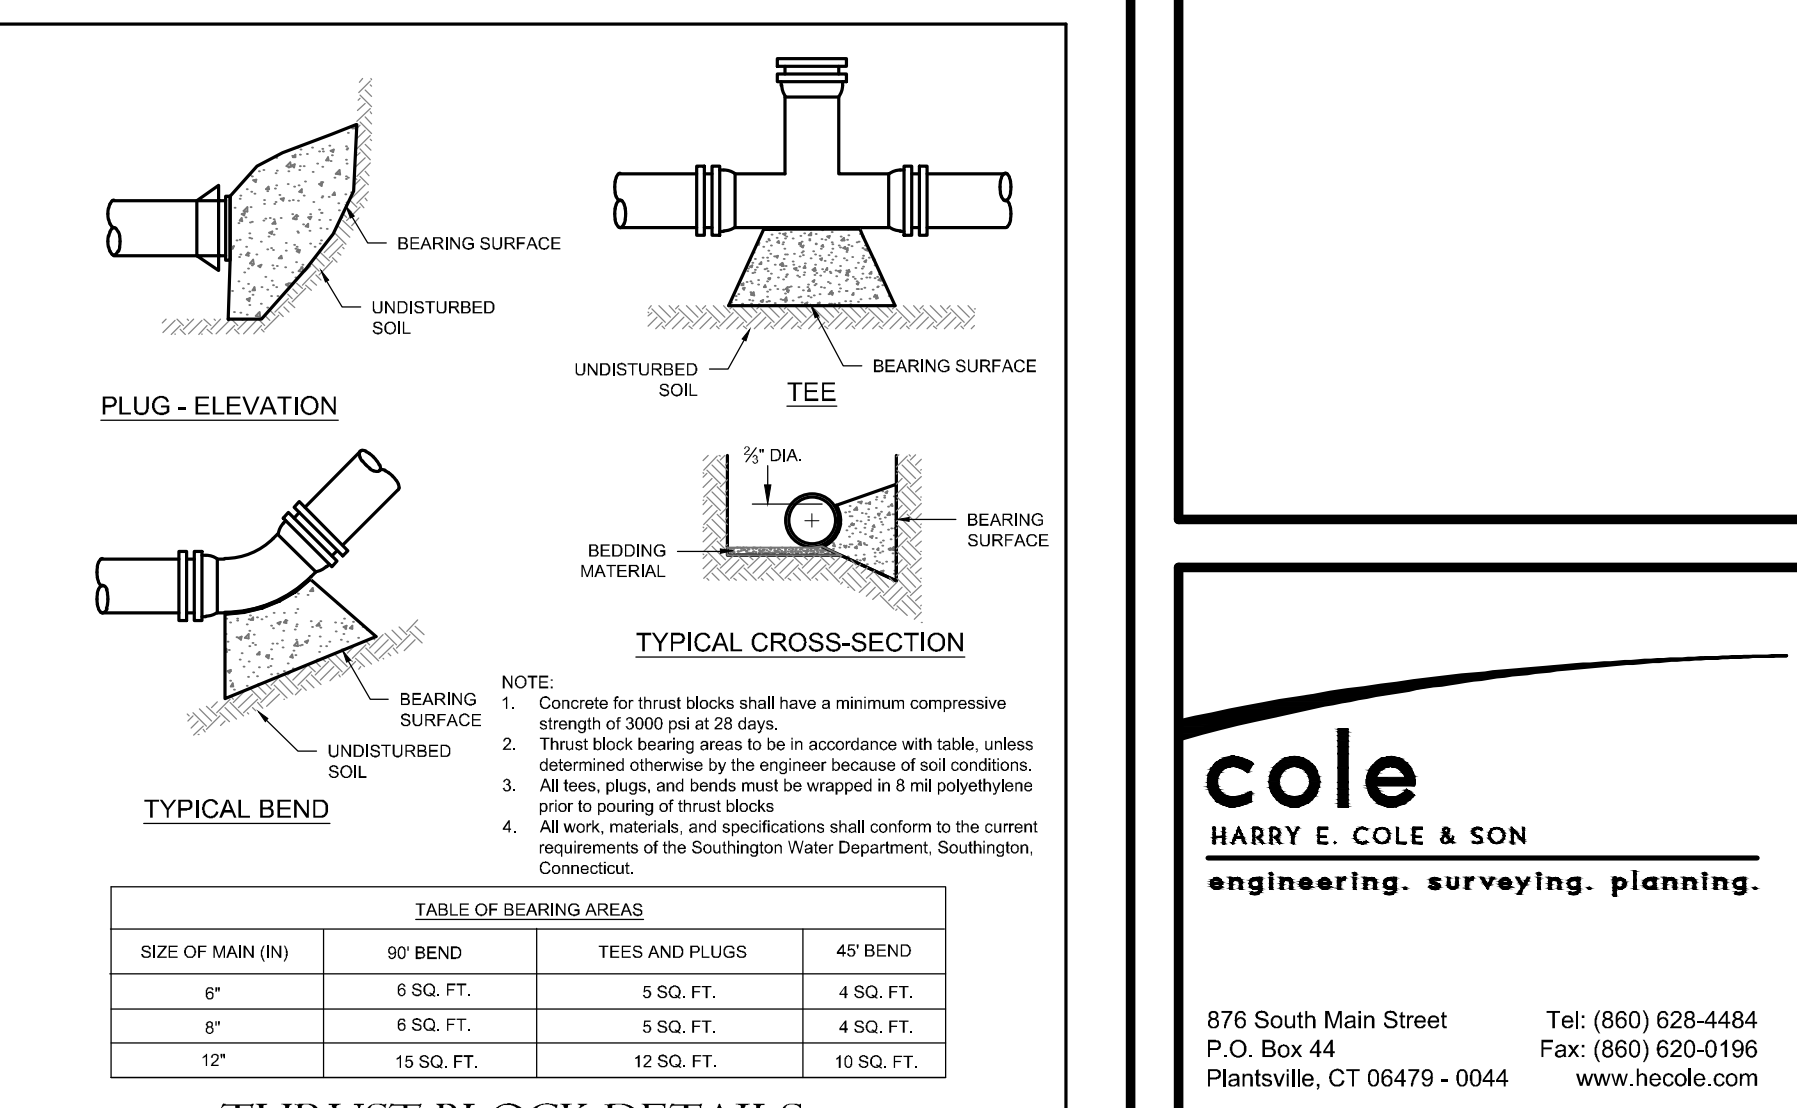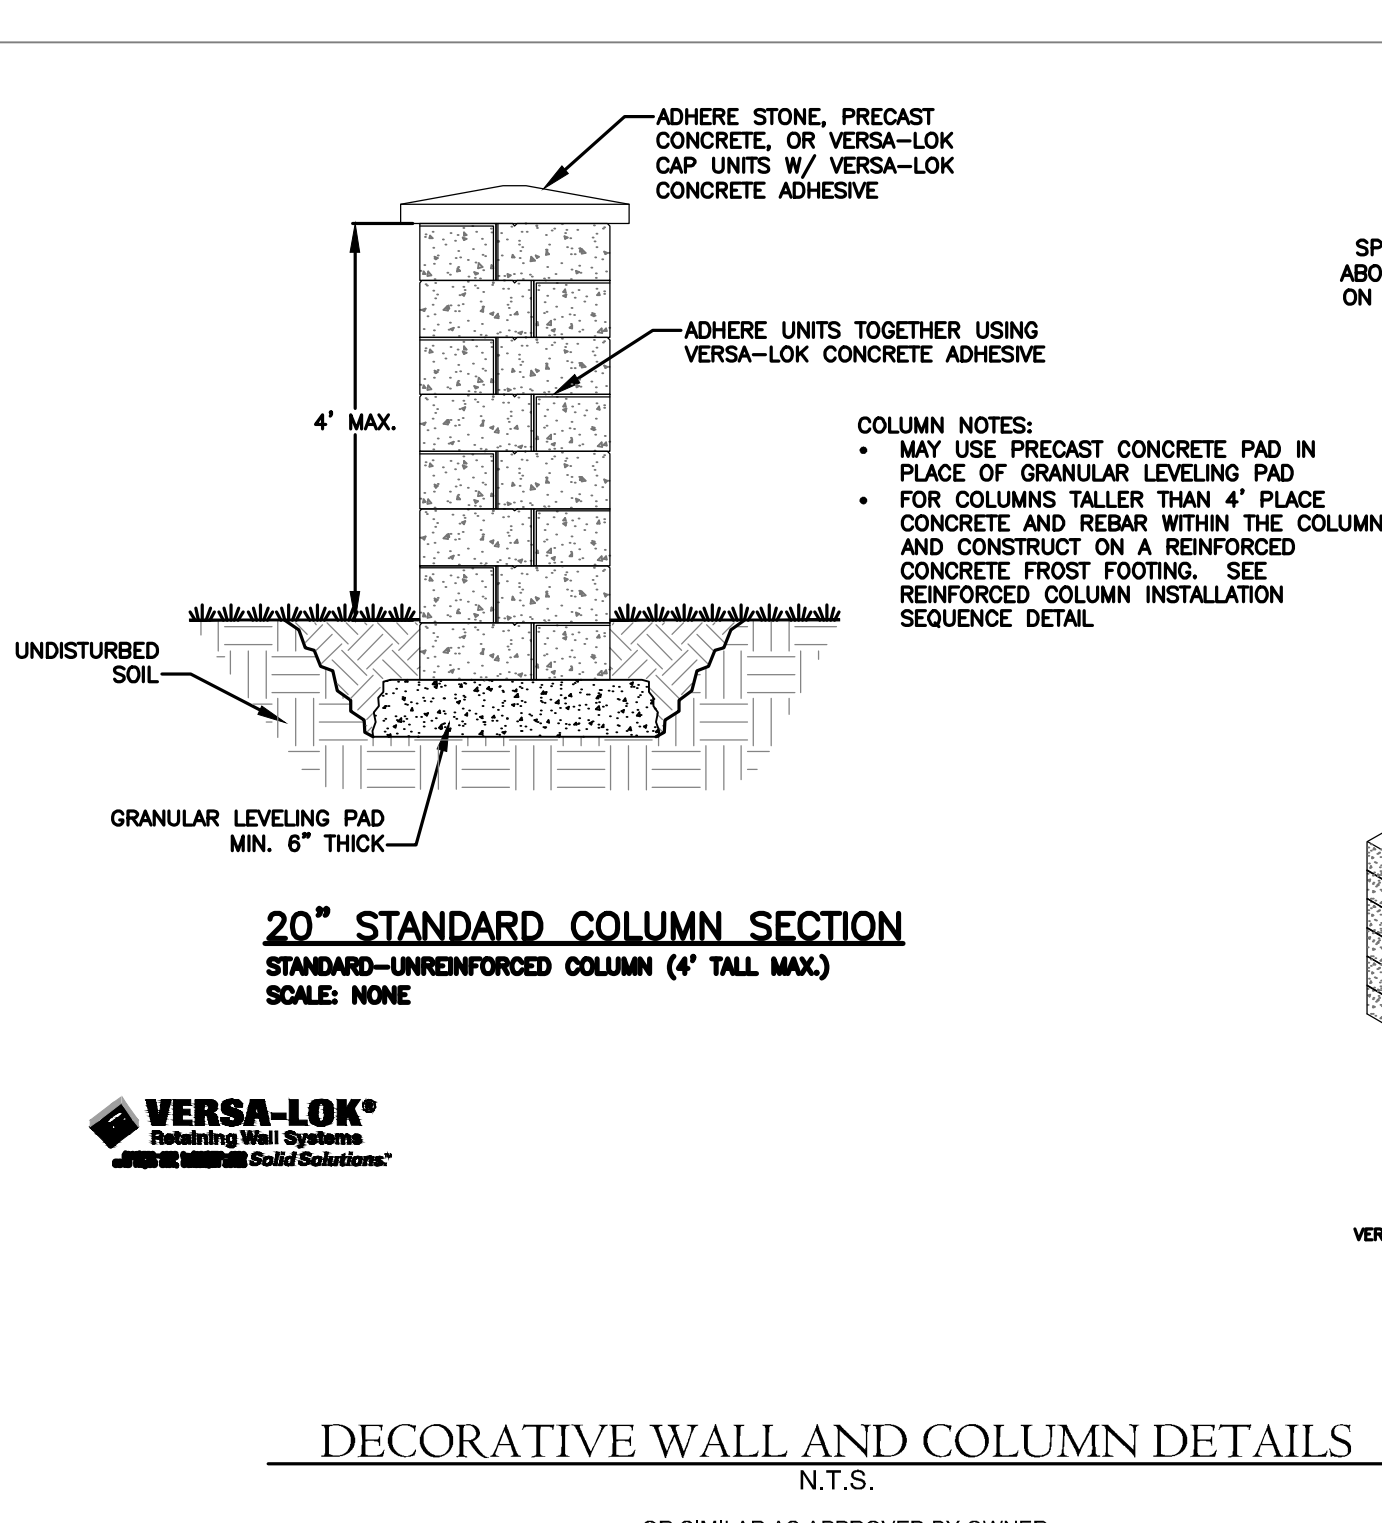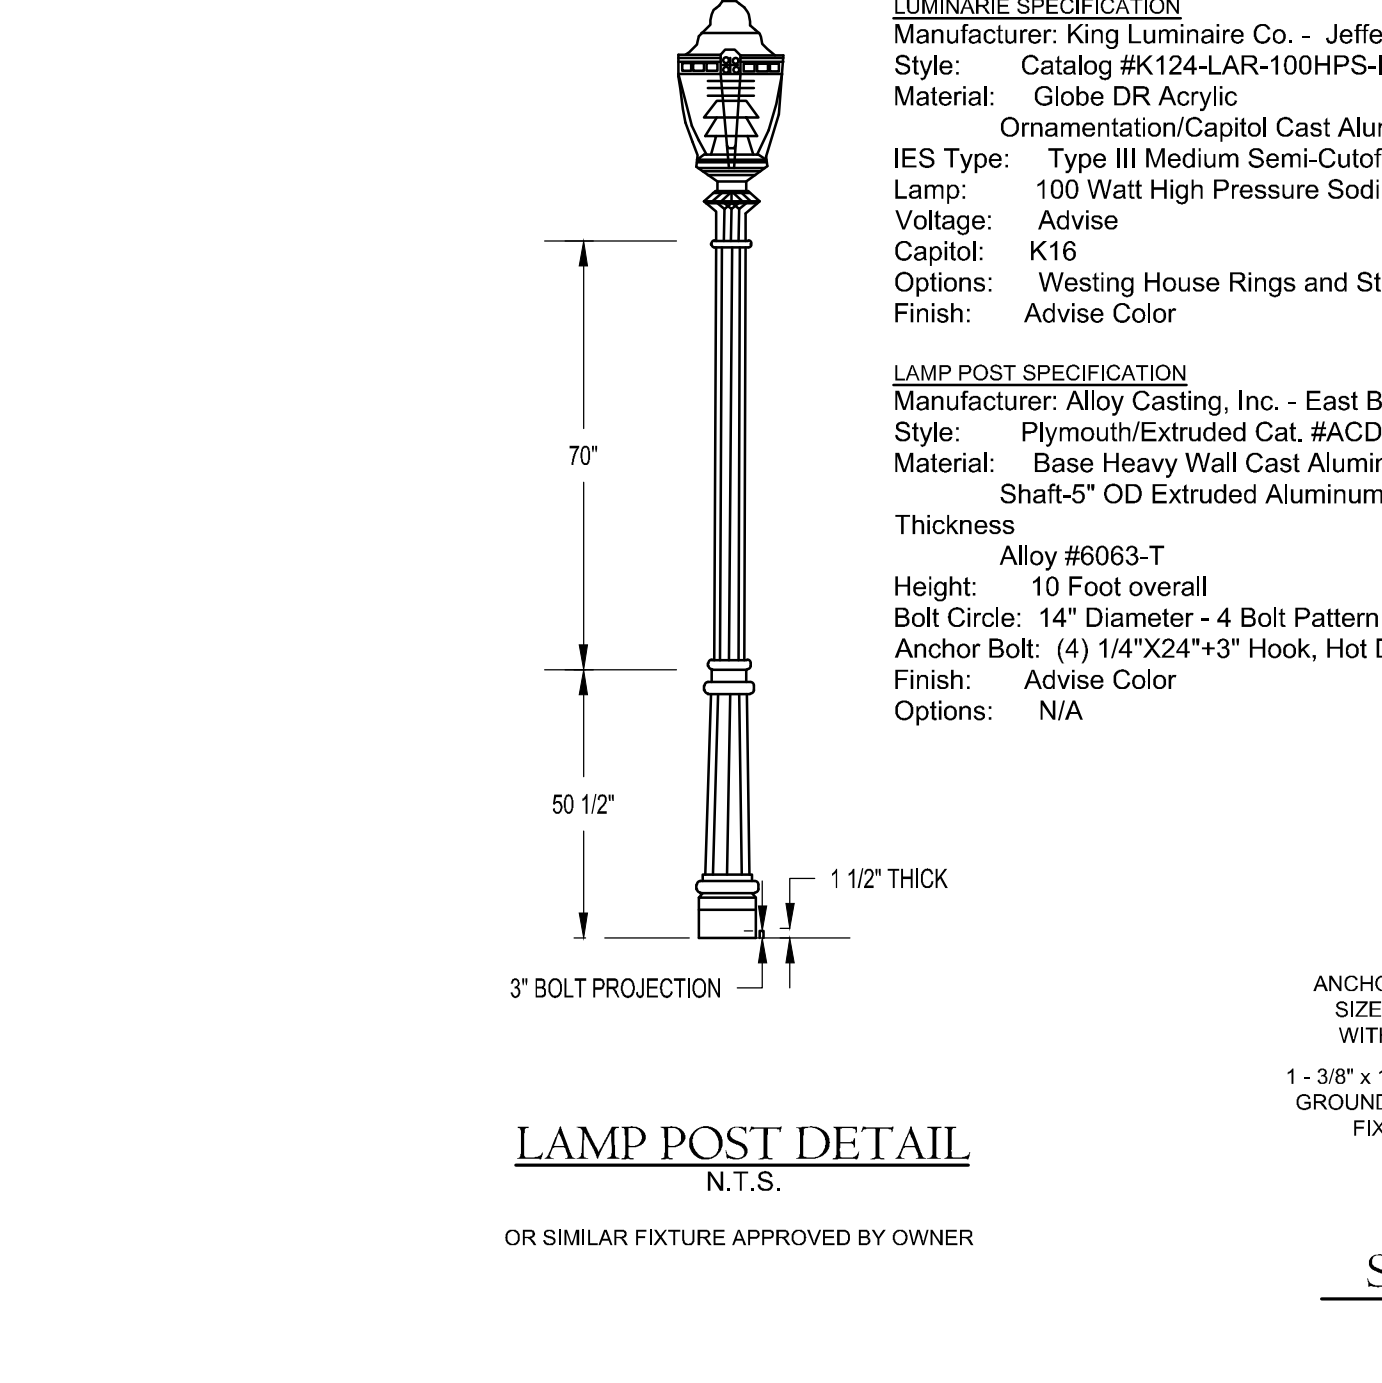

THRUST BLOCK DETAILS

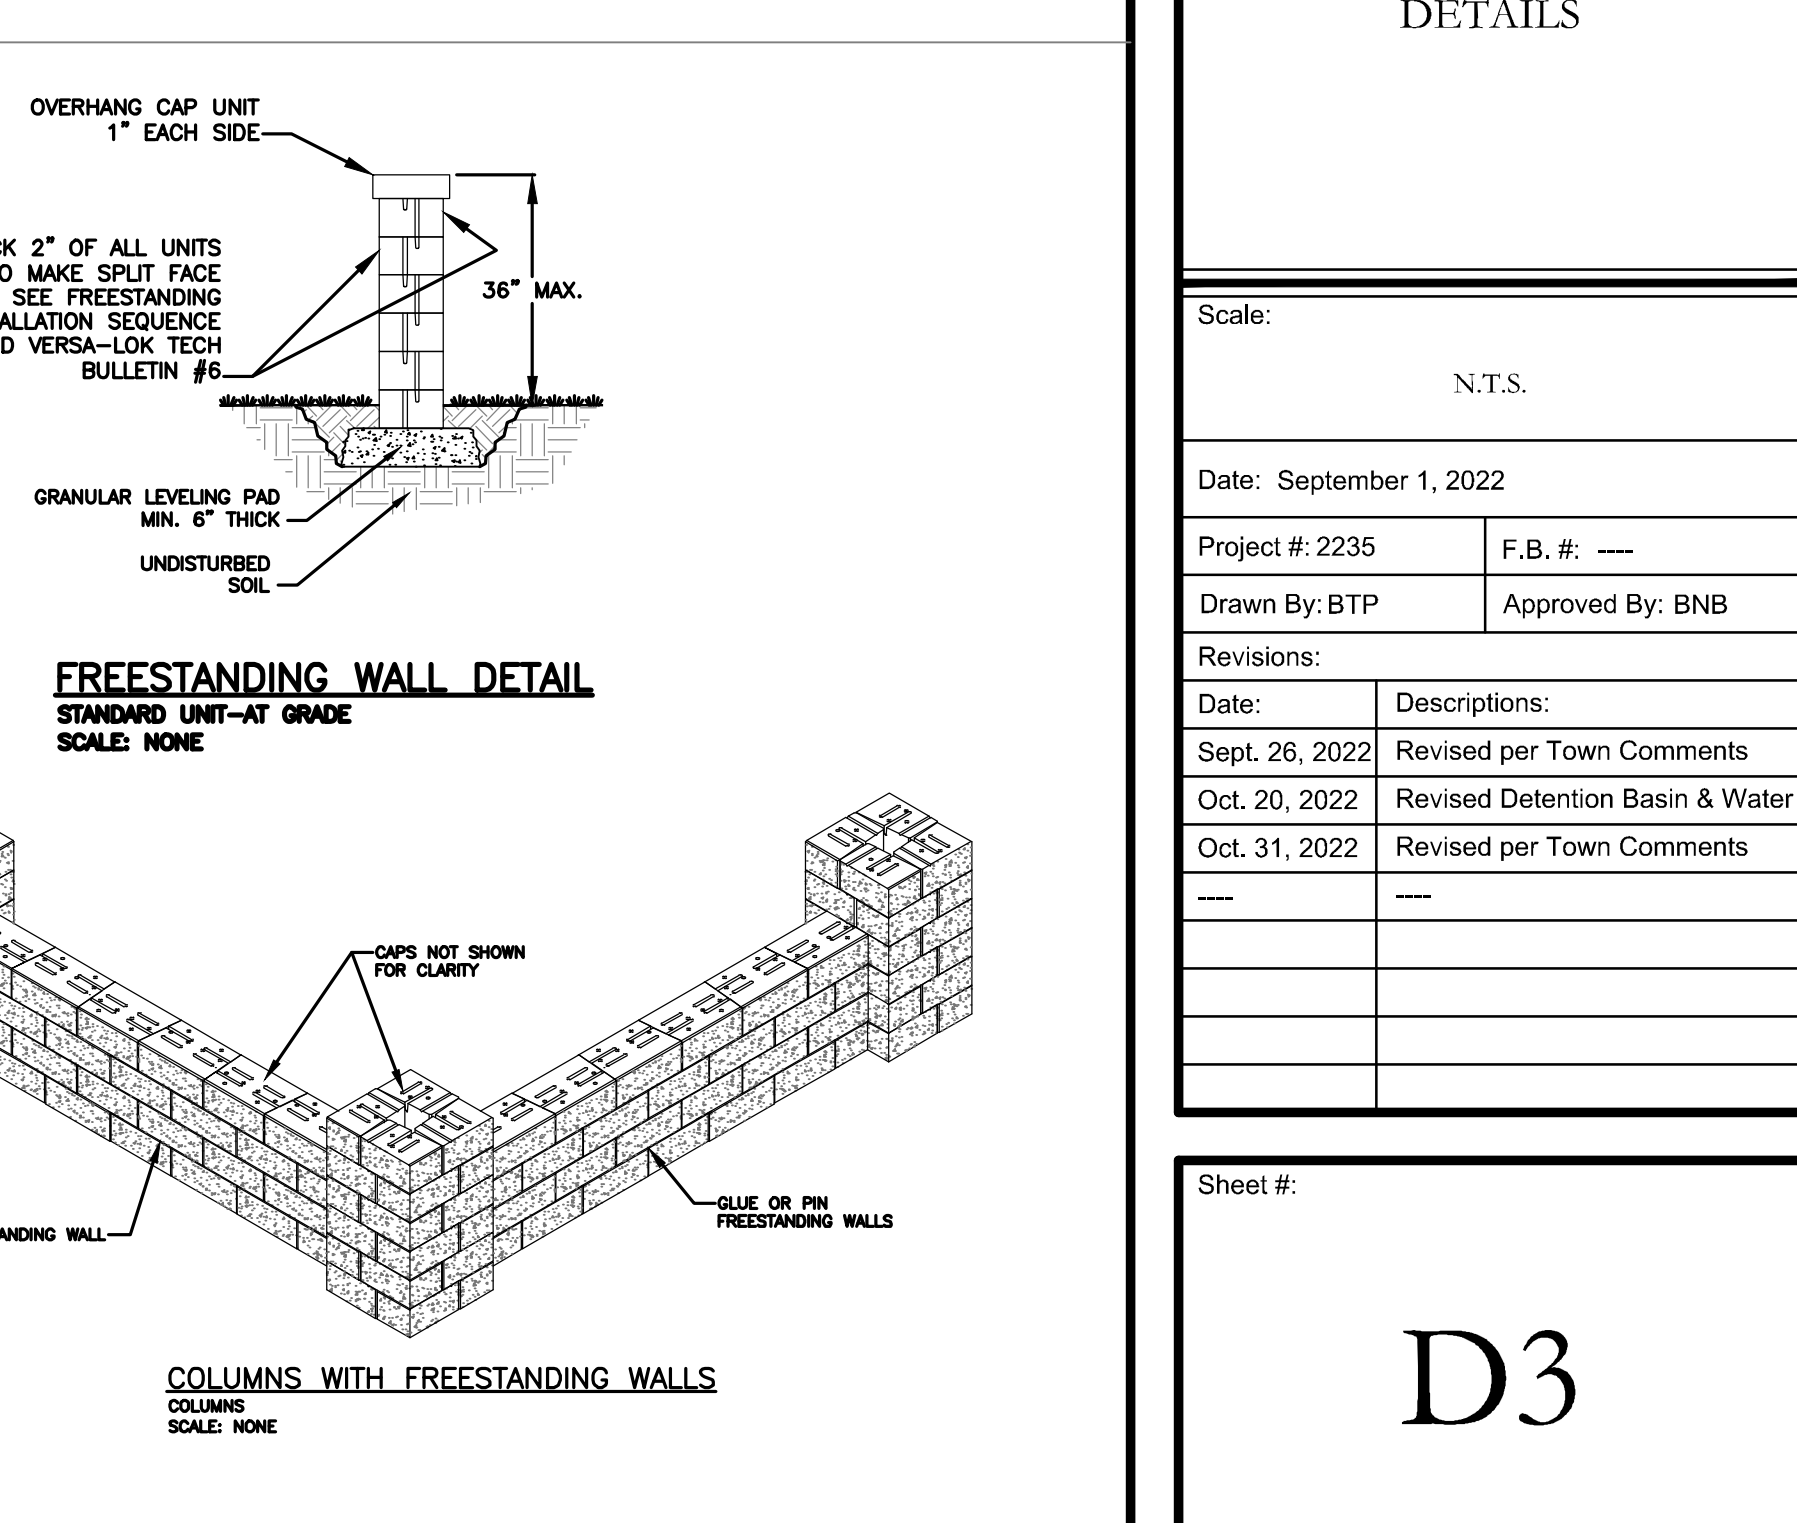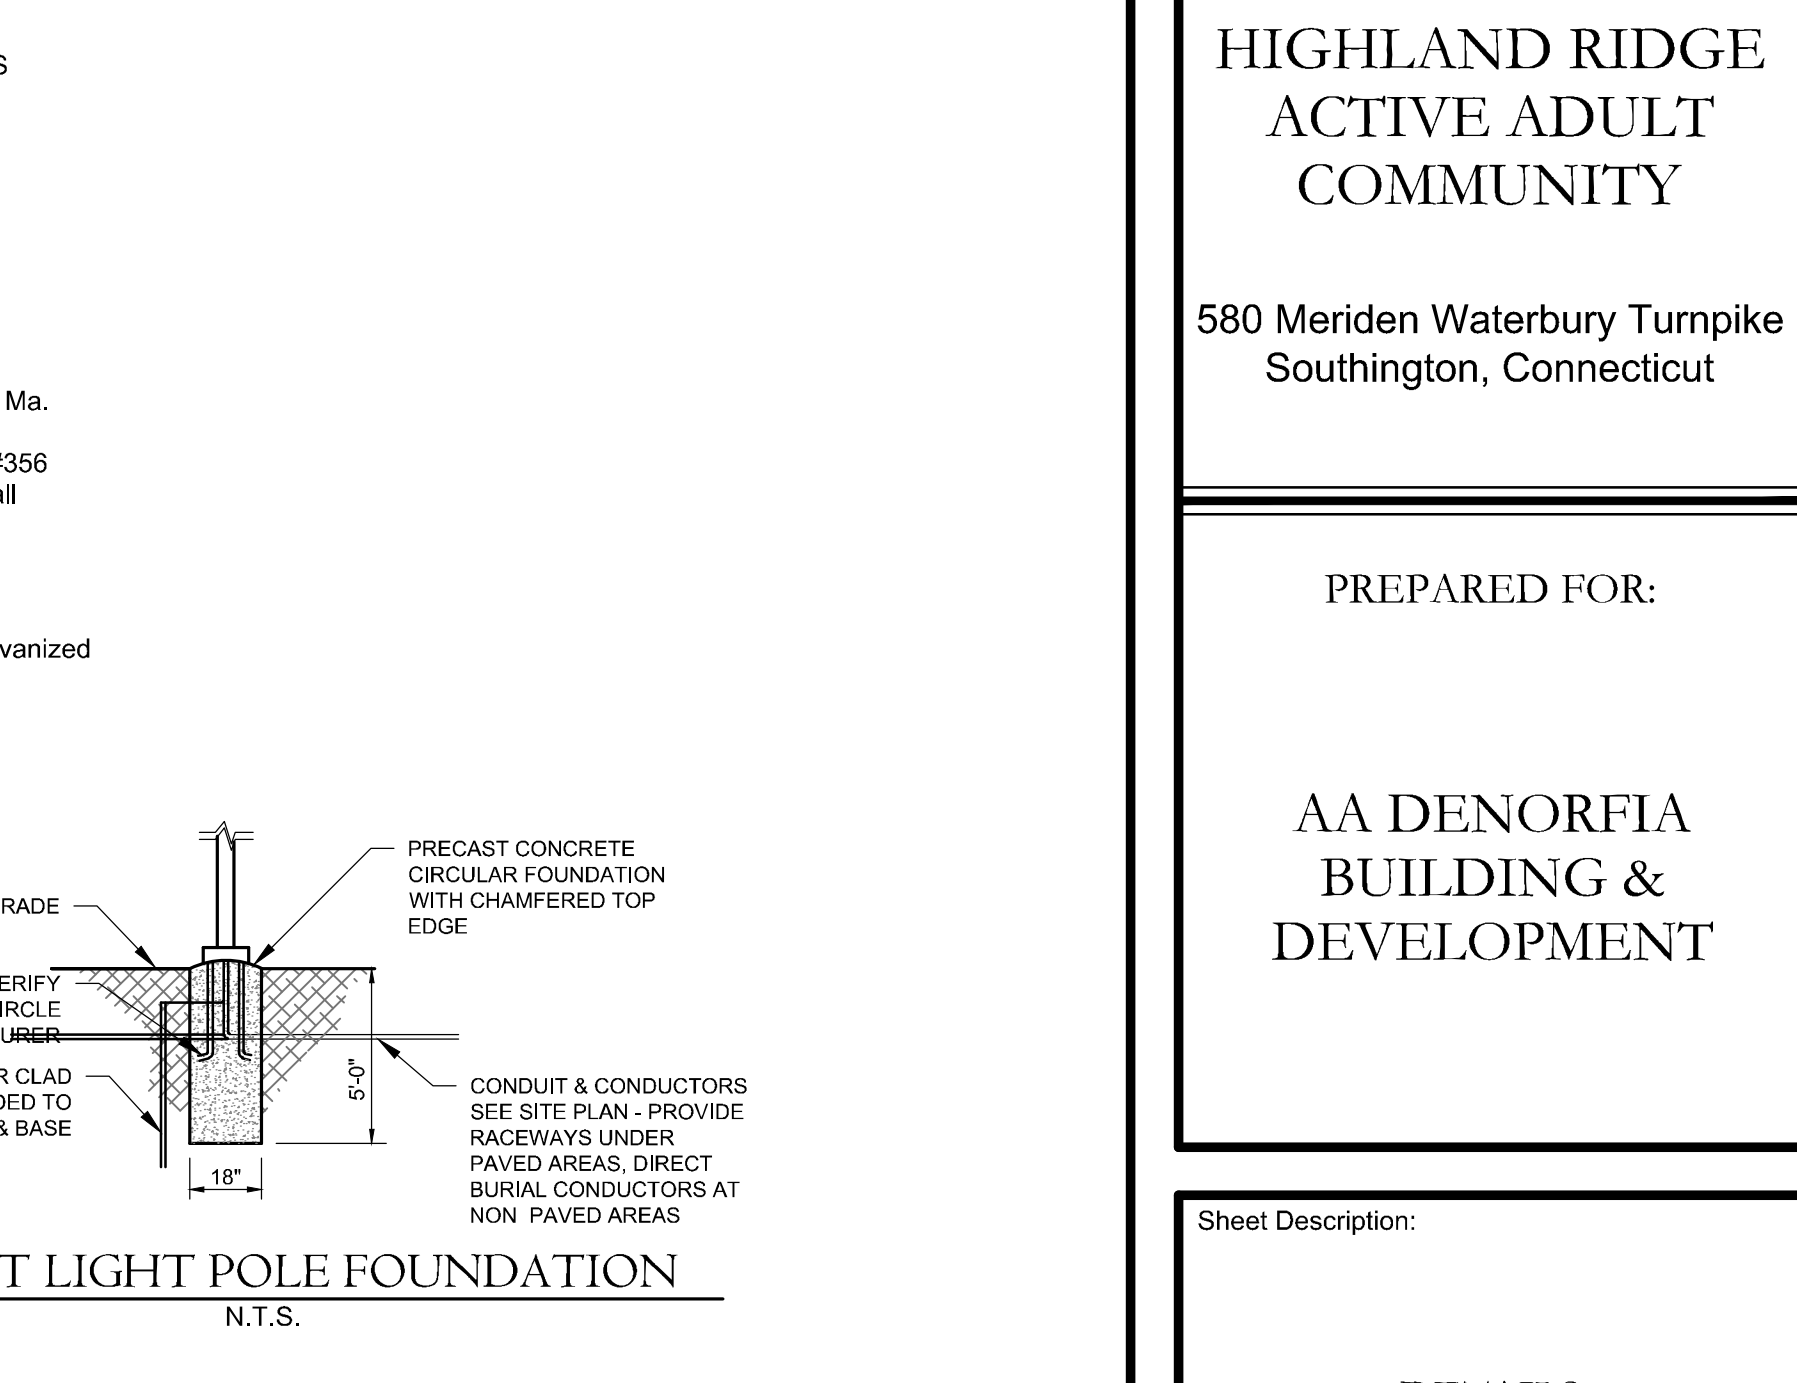

FREESTANDING WALL DETAIL
N.T.S.



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PROJECT NAME:
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580 Meriden Waterbury Turnpike
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PREPARED FOR:
AA DENORFIA
BUILDING &
DEVELOPMENT

Sheet Description:
DETAILS

Scale: N.T.S.

Date: September 1, 2022

Project #: 2235 F.B.#: ---


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Revisions:


Date:	Descriptions:
Sept. 26, 2022	Revised per Town Comments
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Sheet #:
D3

DRAWING NAME: Pavement Details; Drawing No.: 1223-04; Date: 08/20/2022; Project: Highland Ridge Active Adult Community; Location: Southington, CT; Scale: N.T.S.; Author: J. P. ...




STONE PRETREATMENT STRIPS
N.T.S.

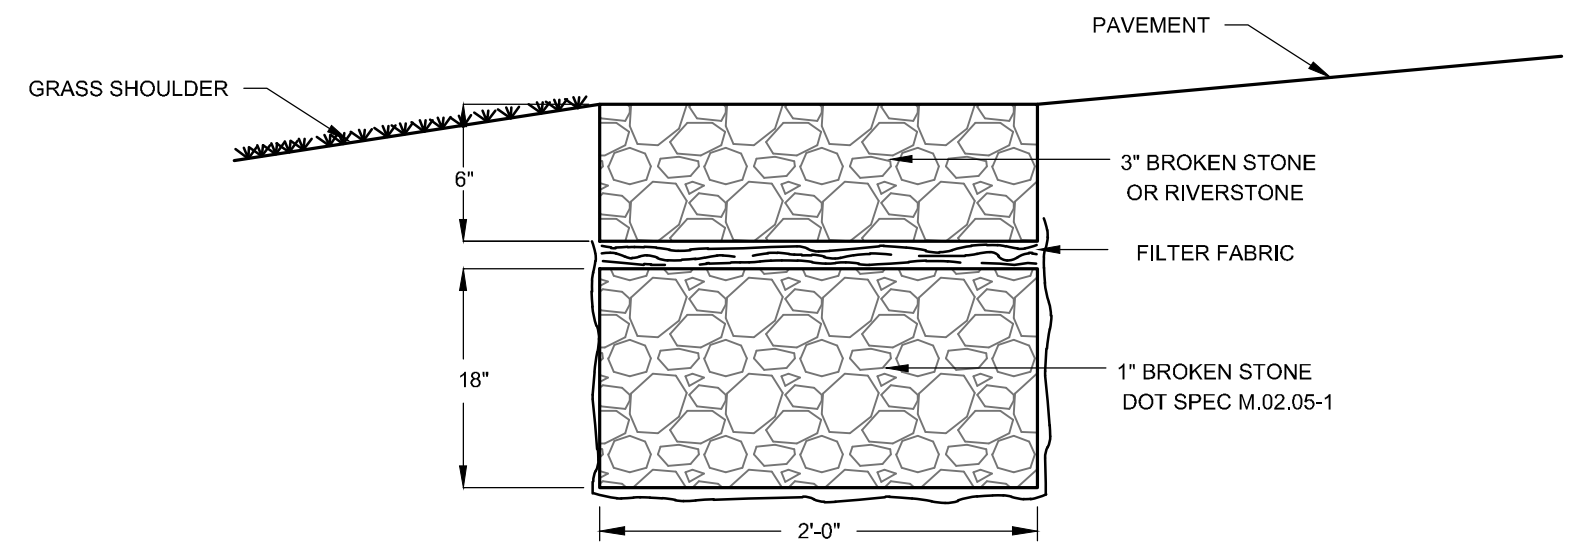

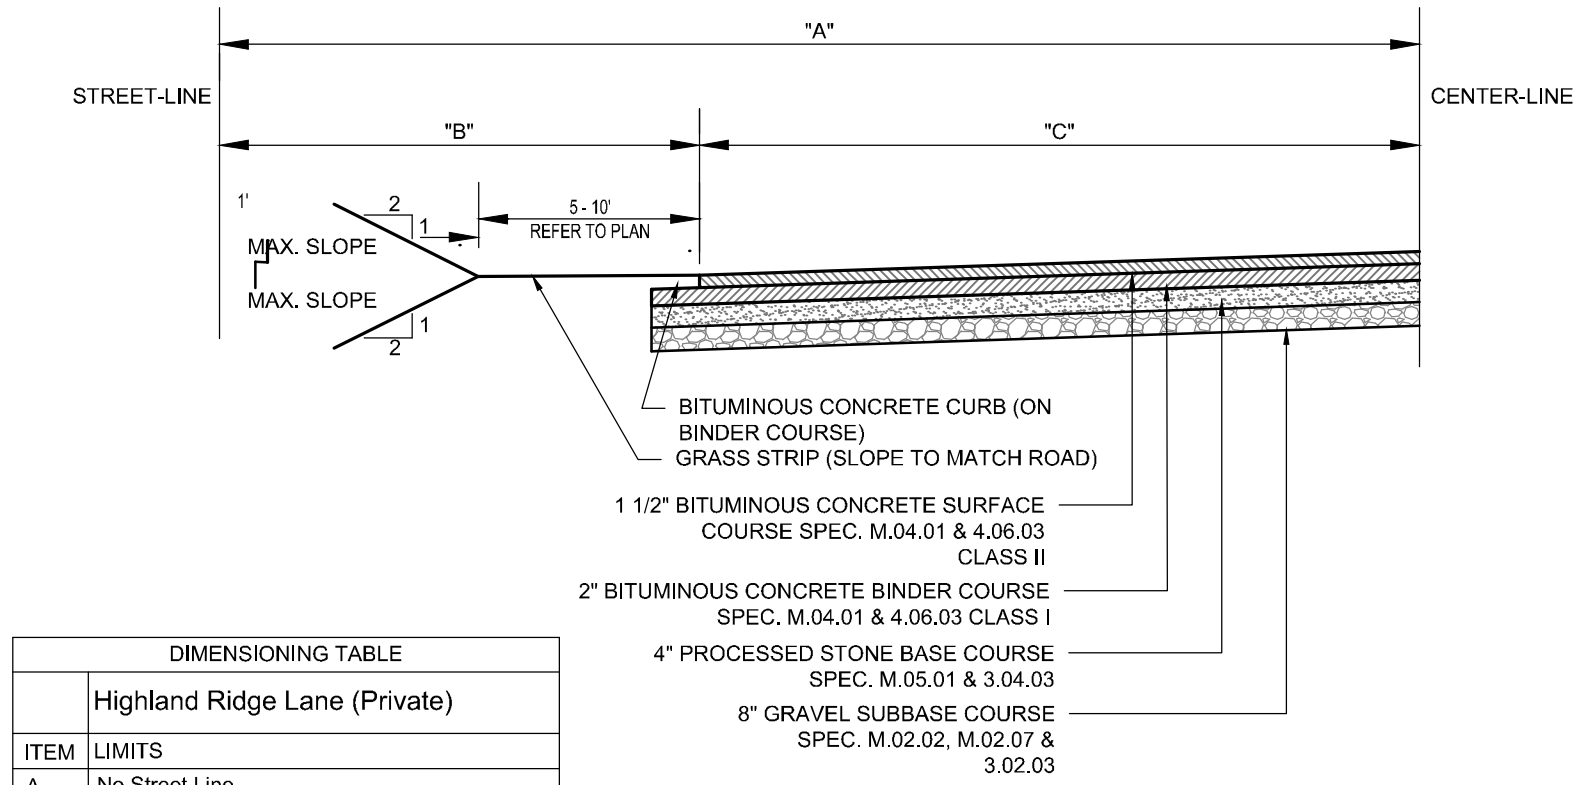DIMENSIONING TABLE	
ITEM	LIMITS
A	No Street Line
B	No Street Line
C	10'

STANDARD ROAD SECTION FOR CONSTRUCTION OF PRIVATE ROADWAY
N.T.S.



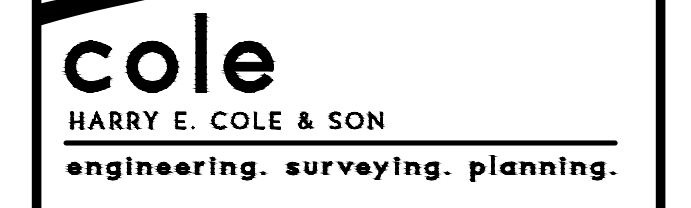


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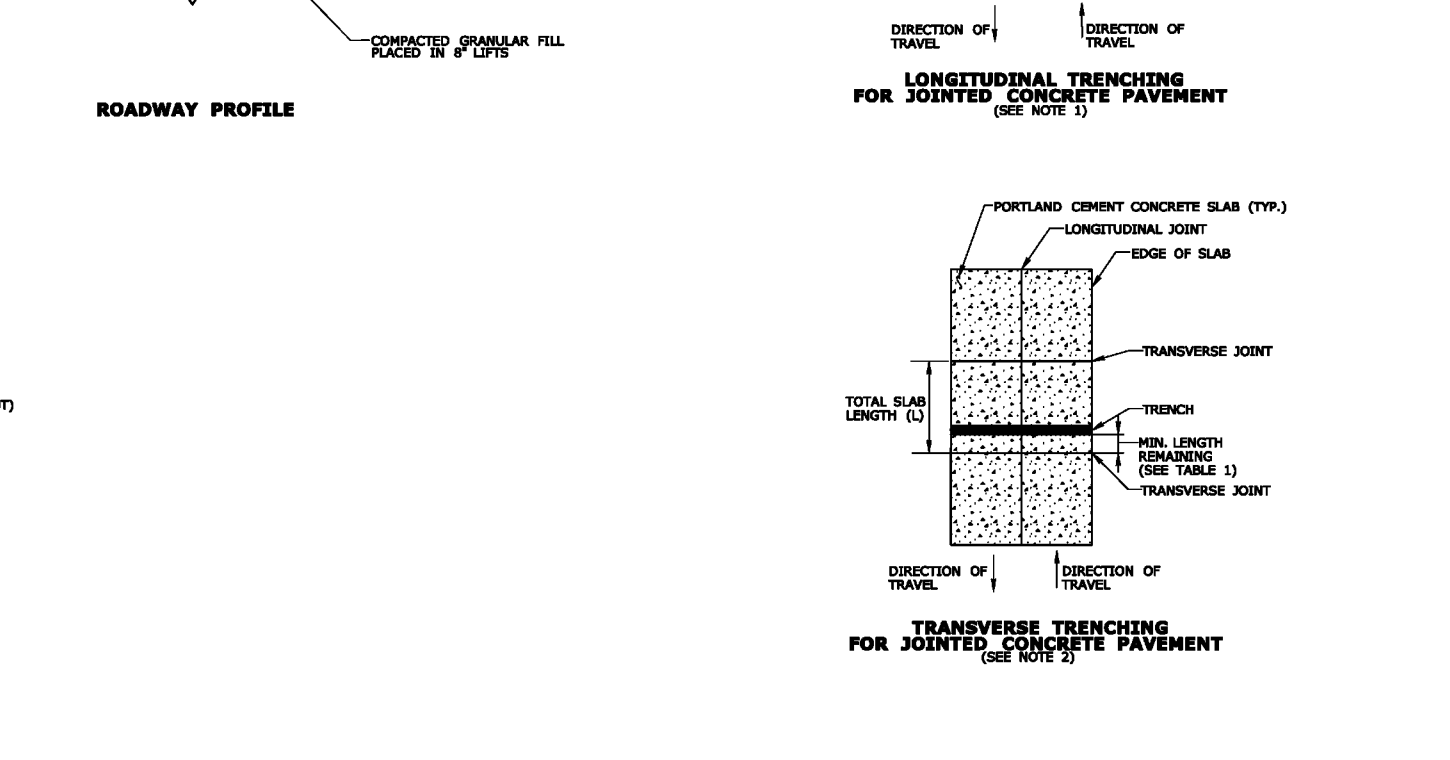
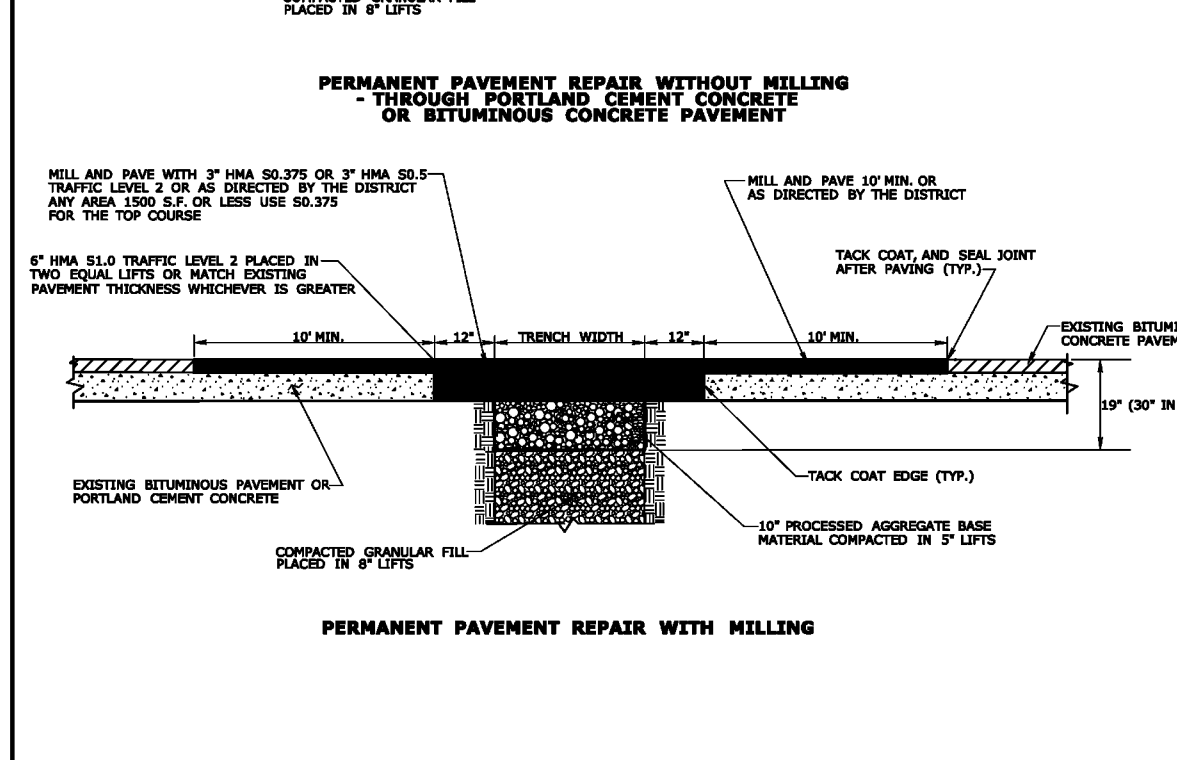
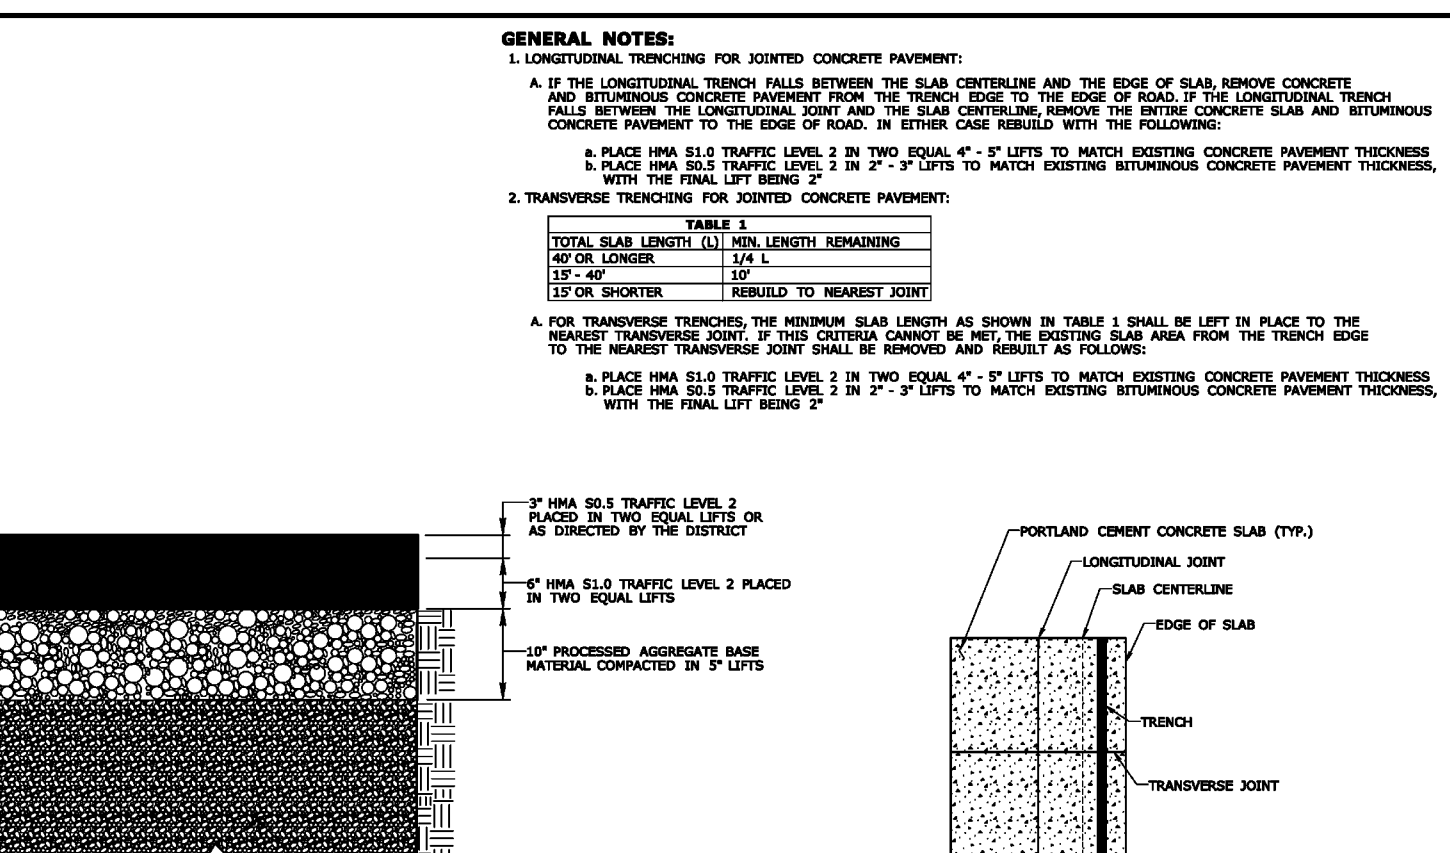
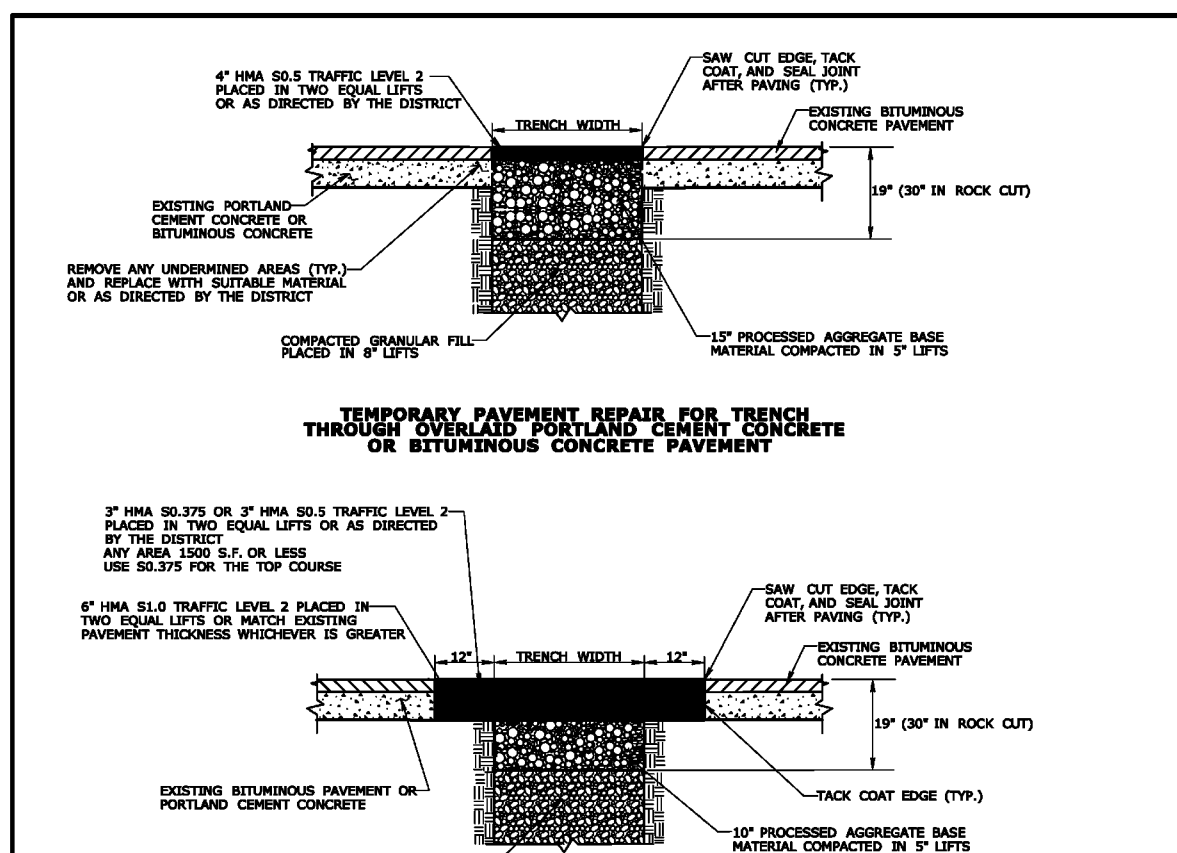
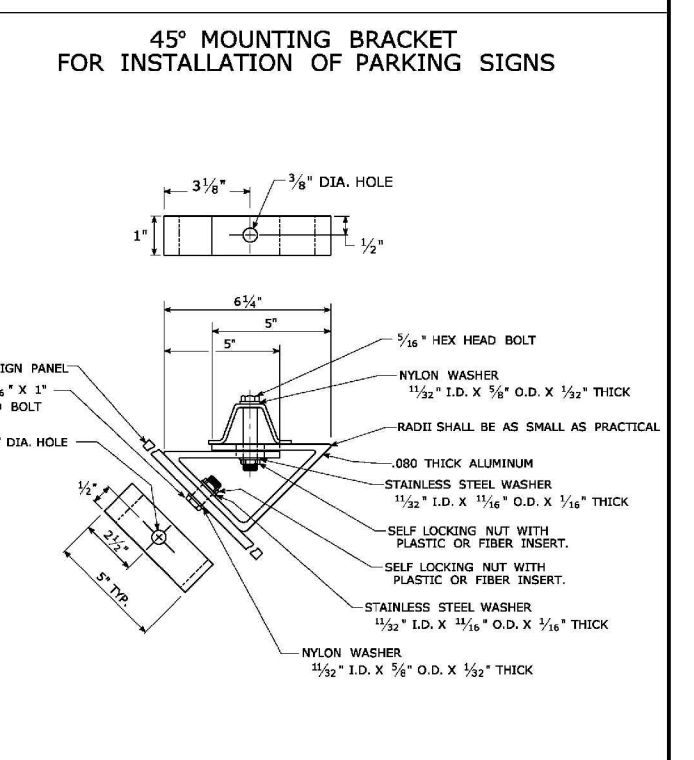
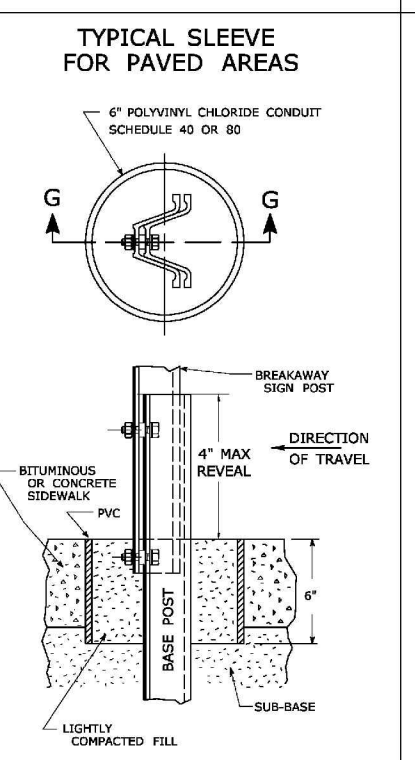
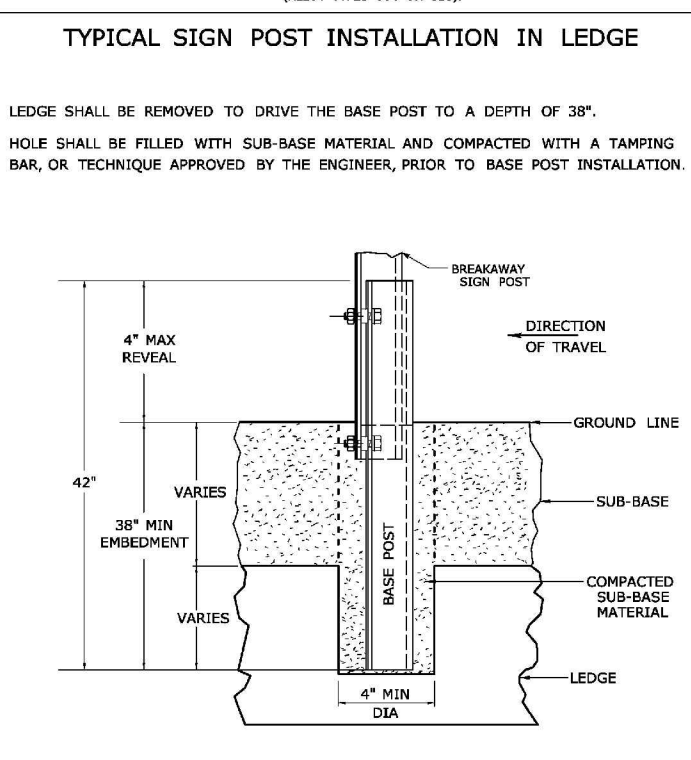
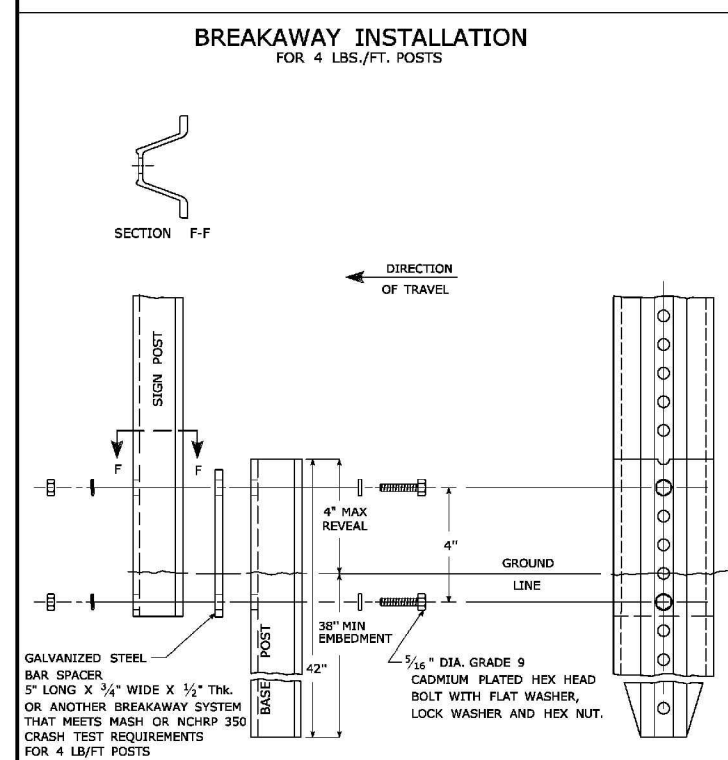
PROJECT NAME:
HIGHLAND RIDGE ACTIVE ADULT COMMUNITY
580 Meriden Waterbury Turnpike
Southington, Connecticut

PREPARED FOR:
AA DENORFIA BUILDING & DEVELOPMENT



GENERAL NOTES:

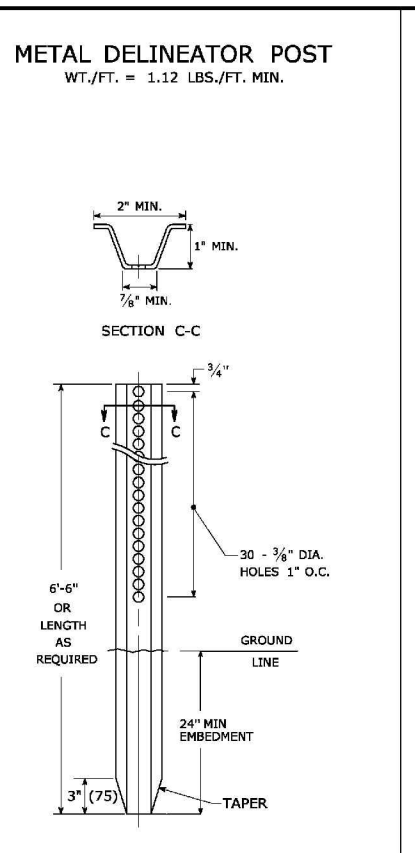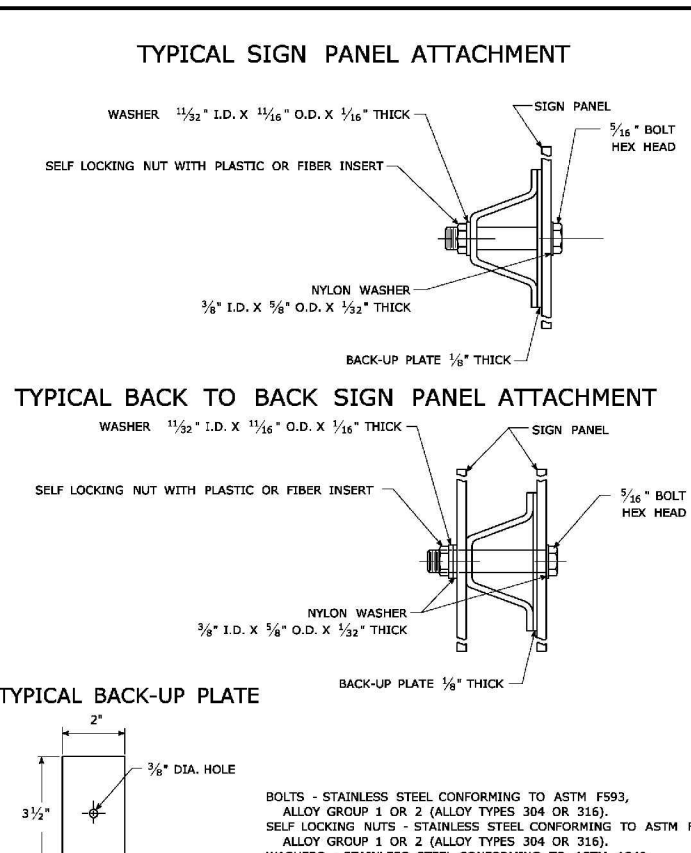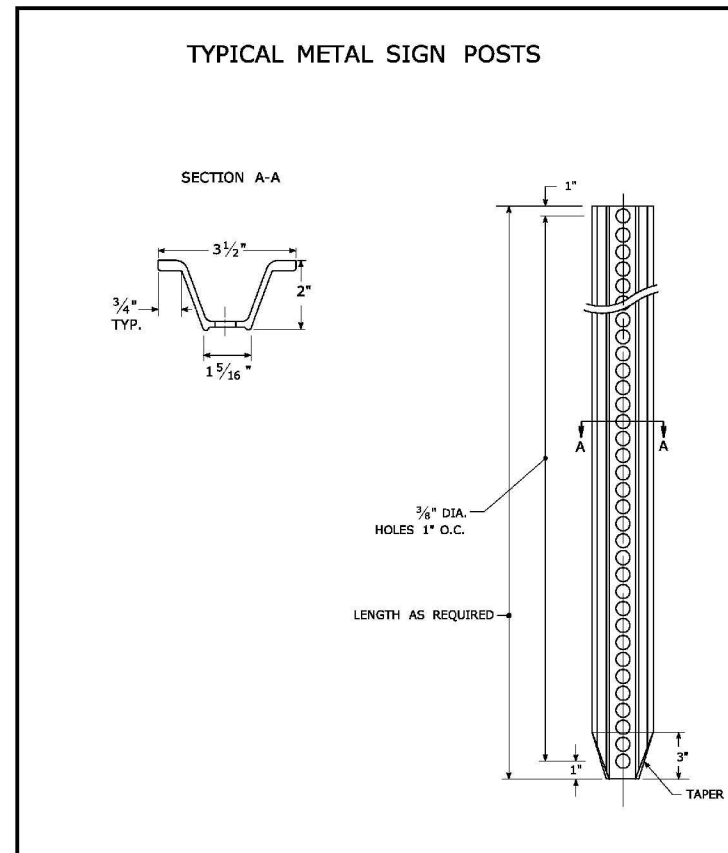- STEEL FOR DELINEATOR POSTS SHALL BE ASTM A36 STEEL. FOR ALL OTHER POSTS SHALL CONFORM TO THE MECHANICAL REQUIREMENTS OF ASTM A 999, GRADE 80 AND TO THE CHEMICAL REQUIREMENTS OF ASTM A1 CARBON STEEL. THE RAIL HAVING NOMINAL WEIGHT (RATED) OF 91 LBS. OR GREATER PER LINEAL YARD.
- AFTER FABRICATION, ALL STEEL POSTS, STRAPS AND PLATES SHALL BE GALVANIZED TO MEET THE REQUIREMENTS OF ASTM A123.
- WASHERS FOR BRIDGWAY INSTALLATIONS SHALL MEET ASTM F436, TYPE 1.
- SPOCKE BAR FOR BRIDGWAY INSTALLATION SHALL CONFORM TO THE MECHANICAL REQUIREMENTS OF ASTM A36.
- ALL BOLTS, NUTS, AND WASHERS FOR BRIDGWAY INSTALLATIONS SHALL BE GALVANIZED TO MEET THE REQUIREMENTS OF ASTM A153.
- ALL SIGN POSTS SHALL HAVE BREAKAWAY FEATURES THAT MEET ASHTO REQUIREMENTS CONTAINED IN THE CURRENT "STANDARD SPECIFICATIONS FOR STRUCTURAL SUPPORTS FOR HIGHWAY SIGNS, LUMINAIRES AND TRAFFIC SIGNALS." THE BREAKAWAY FEATURES SHALL BE STRUCTURALLY ADEQUATE TO CARRY THE SIGNS SHOWN IN THE PLANS AT 60 MPH WIND LOADINGS. INSTALLATIONS SHALL BE IN ACCORDANCE WITH MANUFACTURERS RECOMMENDATIONS.
- SIGN POSTS SHALL BE 4 LBS./FT.



GENERAL NOTES:

- LONGITUDINAL TRENCHING FOR JOINTED CONCRETE PAVEMENT:
 - IF THE LONGITUDINAL TRENCH FALLS BETWEEN THE SLAB CENTERLINE AND THE EDGE OF SLAB, REMOVE CONCRETE AND BITUMINOUS CONCRETE PAVEMENT REPAIR THE TRENCH EDGE TO THE EDGE OF SLAB. FOR LONGITUDINAL TRENCH FALLS BETWEEN THE CENTERLINE AND THE SLAB CENTERLINE, REMOVE THE BITUMINOUS CONCRETE SLAB AND BITUMINOUS CONCRETE PAVEMENT TO THE EDGE OF ROAD. IN EITHER CASE REBUILD WITH THE FOLLOWING:
 - PLACE 1\"/>
 - TRANSVERSE TRENCHING FOR JOINTED CONCRETE PAVEMENT:
 - PLACE 1\"/>
- FOR TRANSVERSE TRENCHES THE MINIMUM SLAB LENGTH AS SHOWN IN TABLE 1 SHALL BE LEFT IN PLACE TO THE NEAREST TRANSVERSE JOINT. IF THIS CRITERIA CANNOT BE MET THE EXISTING SLAB AREA FROM THE TRENCH EDGE TO THE NEAREST TRANSVERSE JOINT SHALL BE REMOVED AND REBUILT AS FOLLOWS:
 - PLACE 1\"/>

Scale: N.T.S.

Date: September 1, 2022

Project #: 2235 F.B.#: ---


Drawn By: BTP Approved By: BNB

Revisions:



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Sheet #:
D4

DRAWING NAME: P:\Land Project\2235-01\Drawings\Building & Development\2235-01-01-01-01.dwg DATE: 09/01/2022 11:11:00 AM USER: BTP

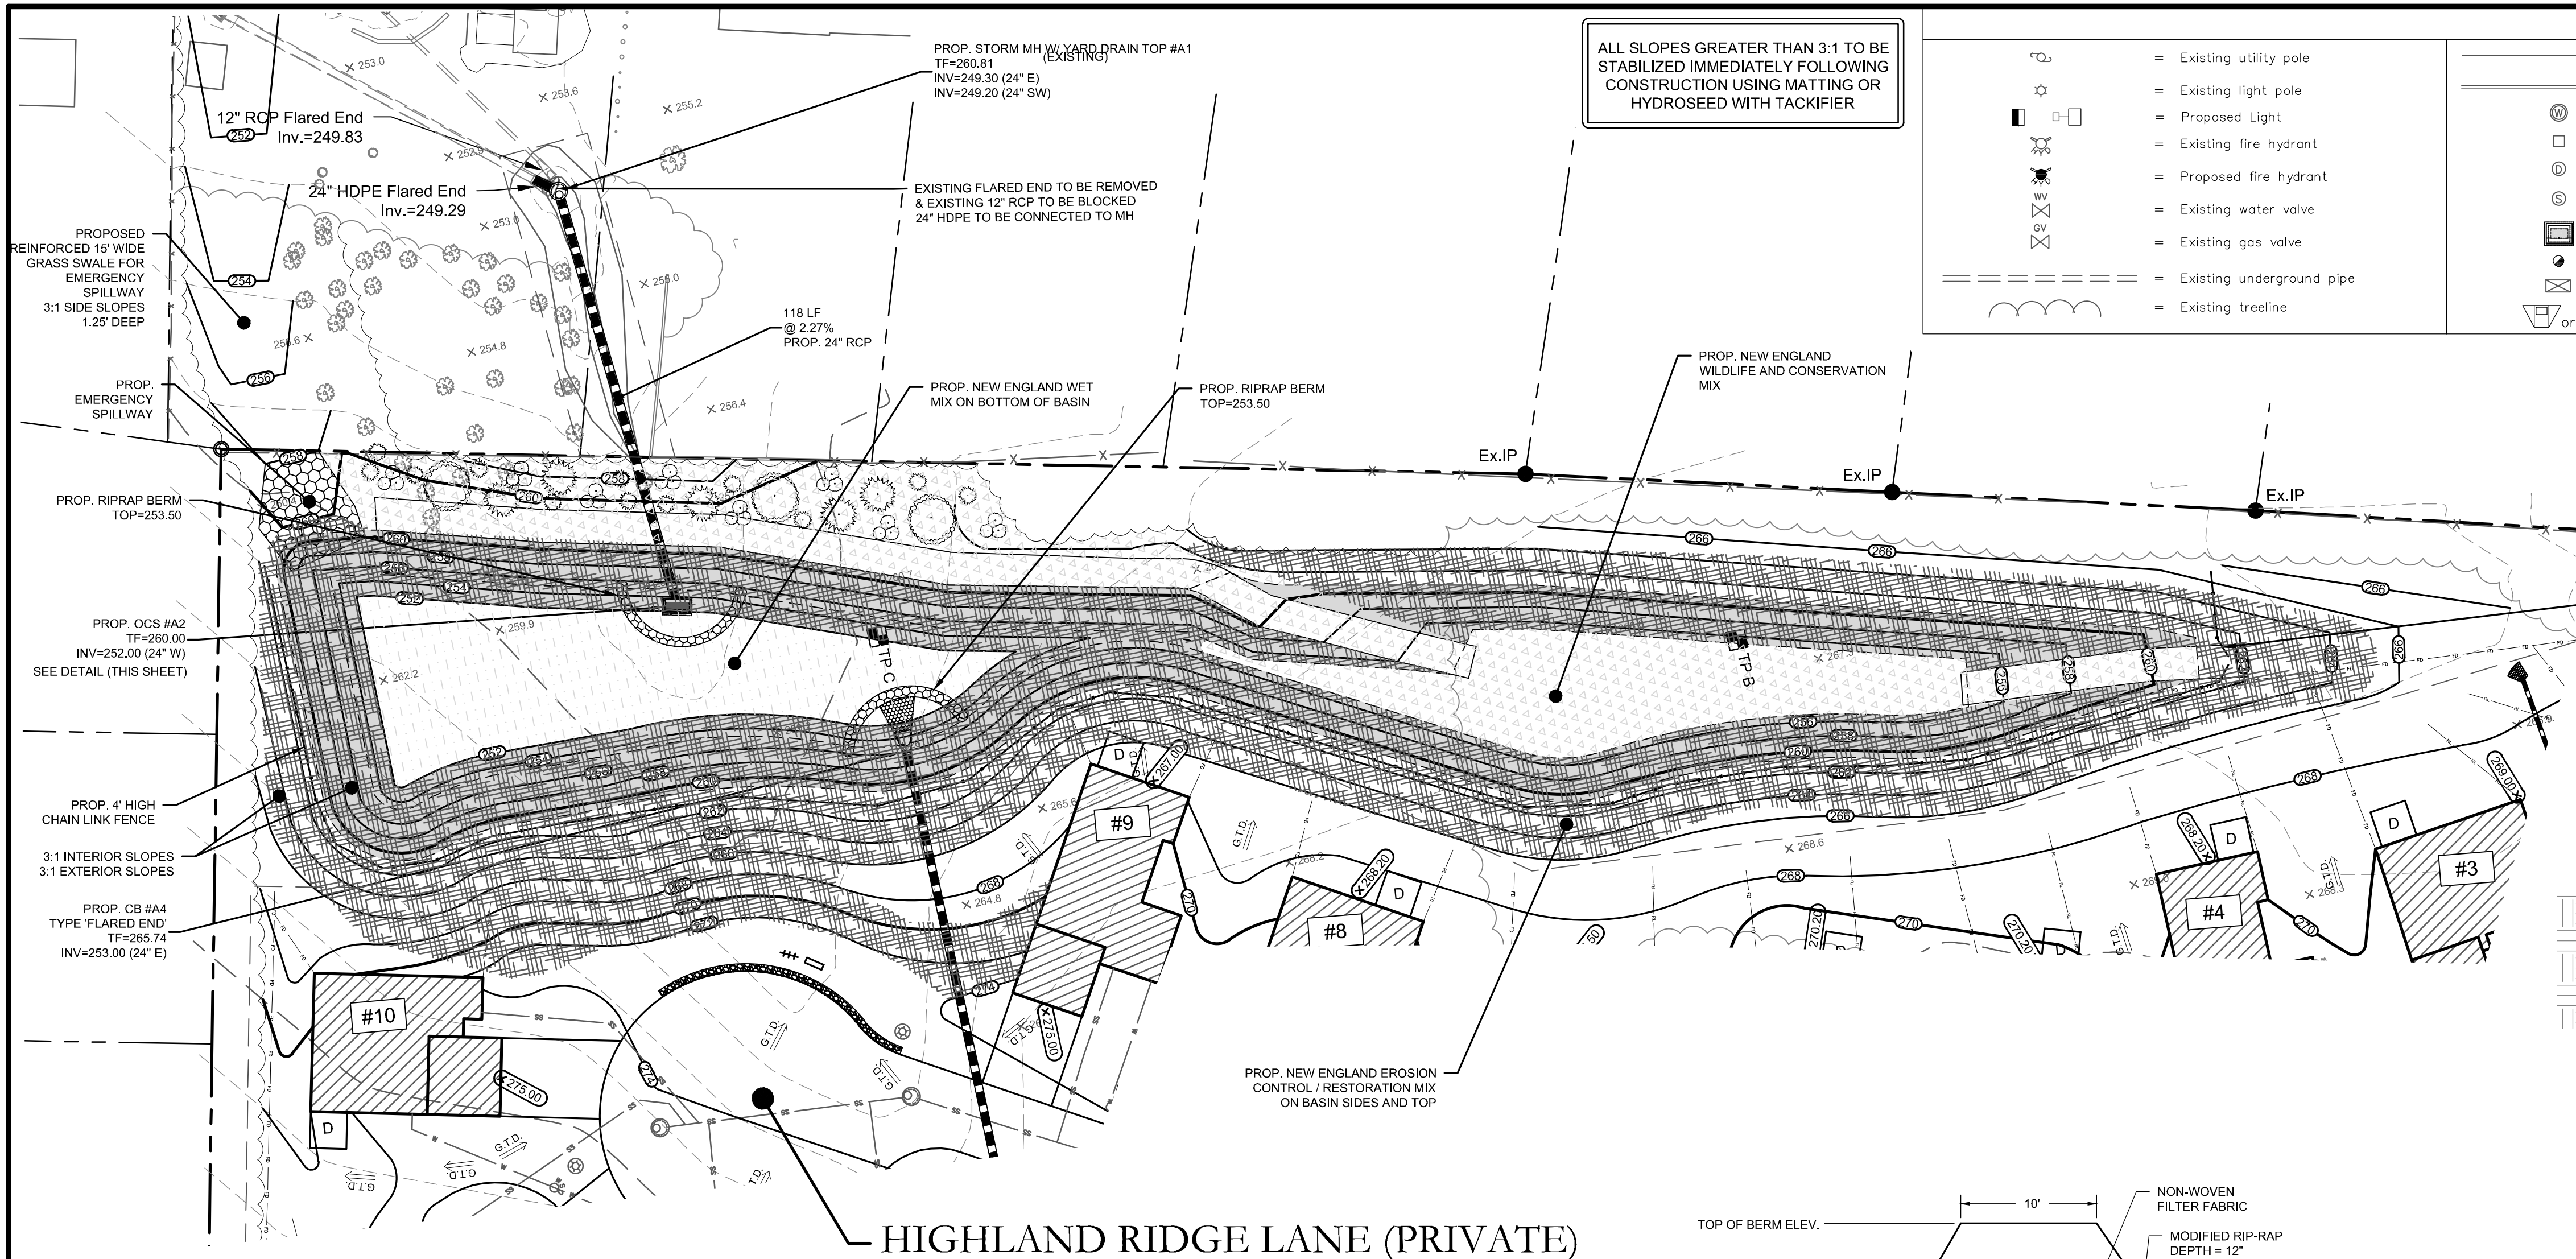

ALL SLOPES GREATER THAN 3:1 TO BE STABILIZED IMMEDIATELY FOLLOWING CONSTRUCTION USING MATTING OR HYDROSEED WITH TACKIFIER

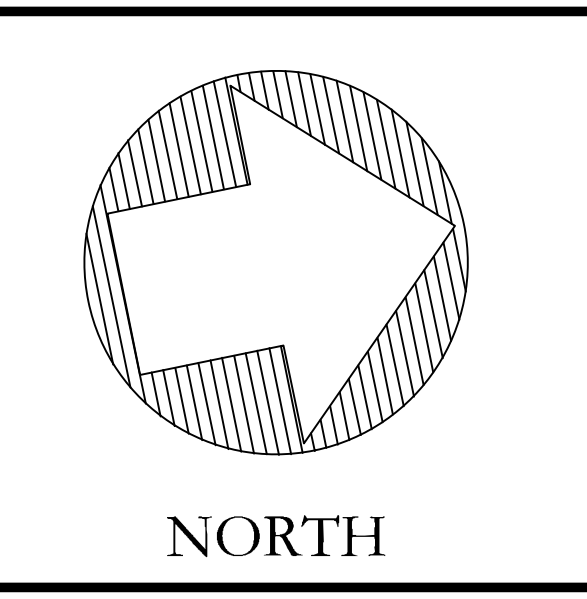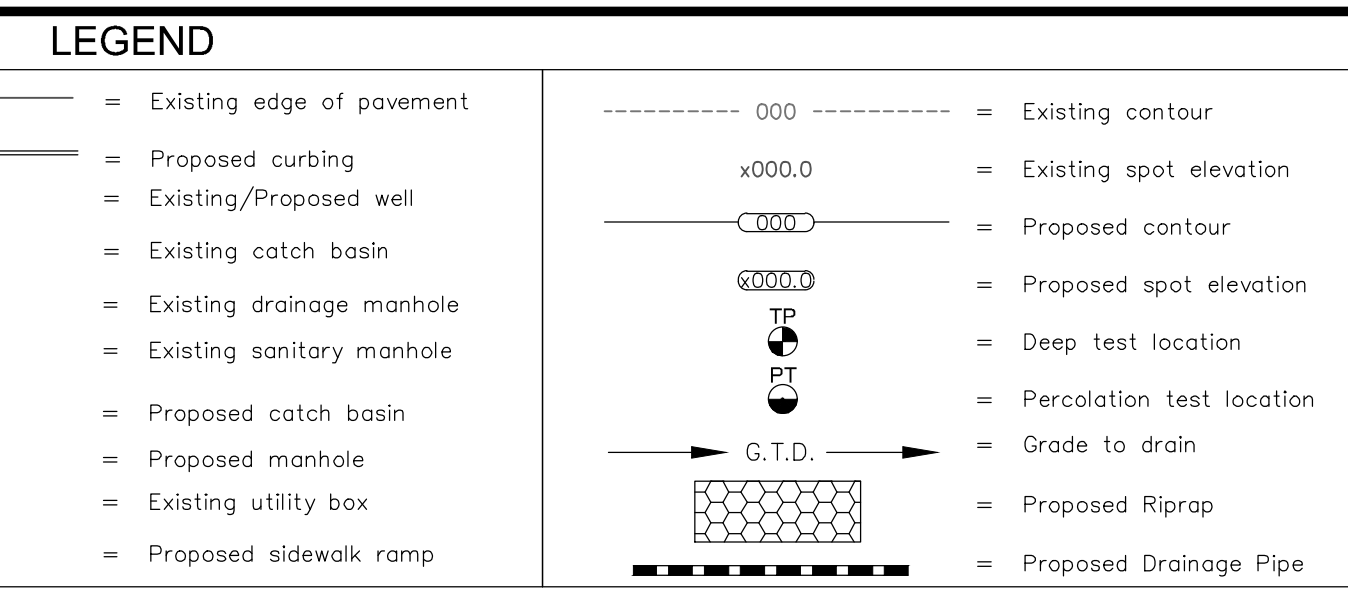




cole
HARRY E. COLE & SON
engineering. surveying. planning.
876 South Main Street Tel: (860) 628-4484
P.O. Box 44 Fax: (860) 620-0196
Plainville, CT 06479 - 0044 www.heccole.com

PROJECT NAME:
HIGHLAND RIDGE ACTIVE ADULT COMMUNITY
580 Meriden Waterbury Turnpike
Southington, Connecticut

PREPARED FOR:
AA DENORFIA BUILDING & DEVELOPMENT



SEED MIX & FABRIC LEGEND

- NEW ENGLAND WET MIX
APPLICATION RATE: 1 POUND/5,000 SQ. FT.
LOCATION: BASIN BOTTOM
- NEW ENGLAND WILDLIFE AND CONSERVATION MIX
APPLICATION RATE: 3 LB/5,000 SQ. FT.
LOCATION: DISTURBED AREAS SURROUNDING BASIN
- NEW ENGLAND EROSION CONTROL/RESTORATION MIX
APPLICATION RATE: 1 LB /1,250 SQ. FT.
LOCATION: BASIN SIDES AND TOP
- SLOPE WITH EROSION CONTROL FABRIC S150 BY NORTH AMERICAN GREEN OR APPROVED EQUAL (LOAM AND SEED, THEN APPLY FABRIC)
ALL SLOPES 3:1 OR STEEPER

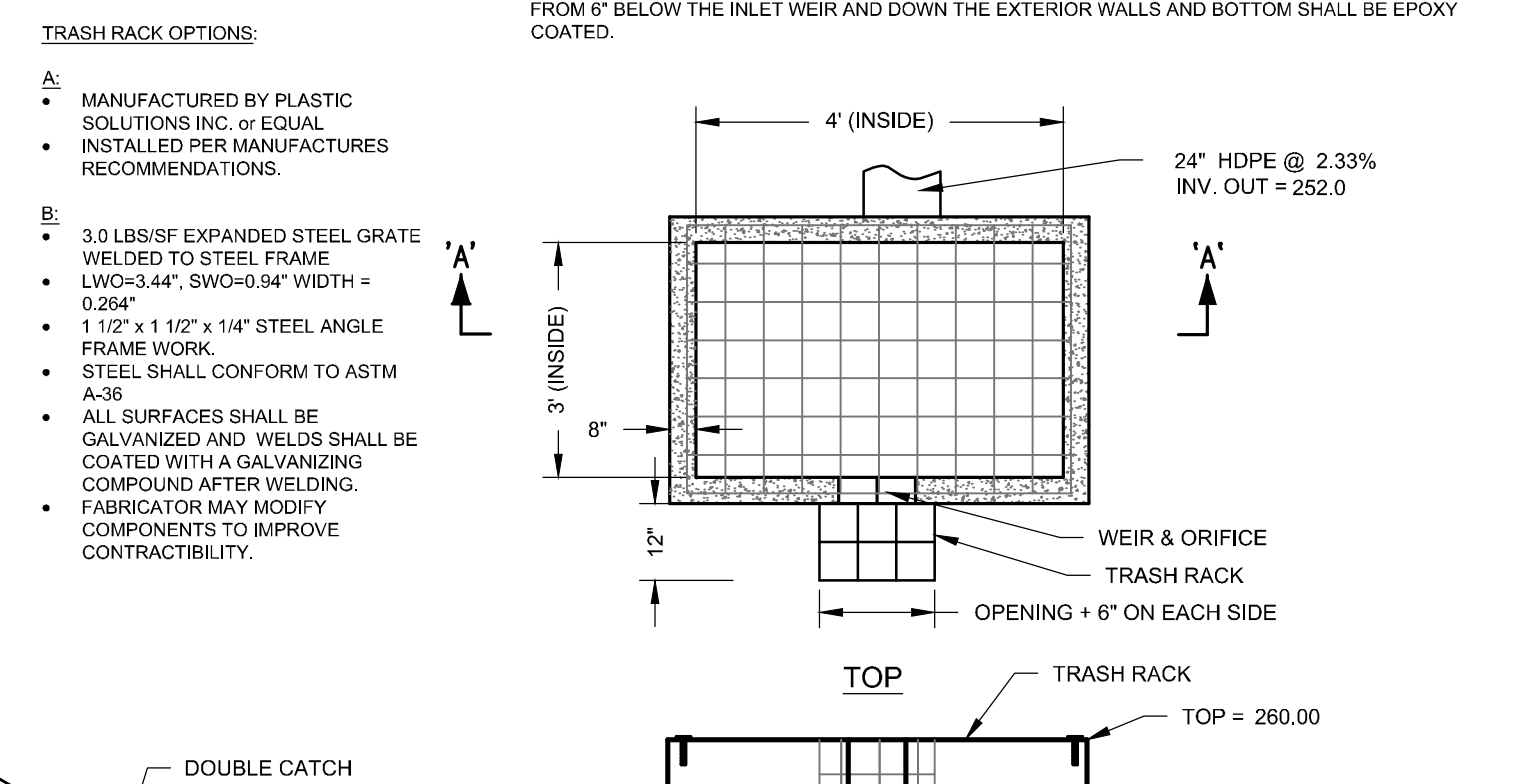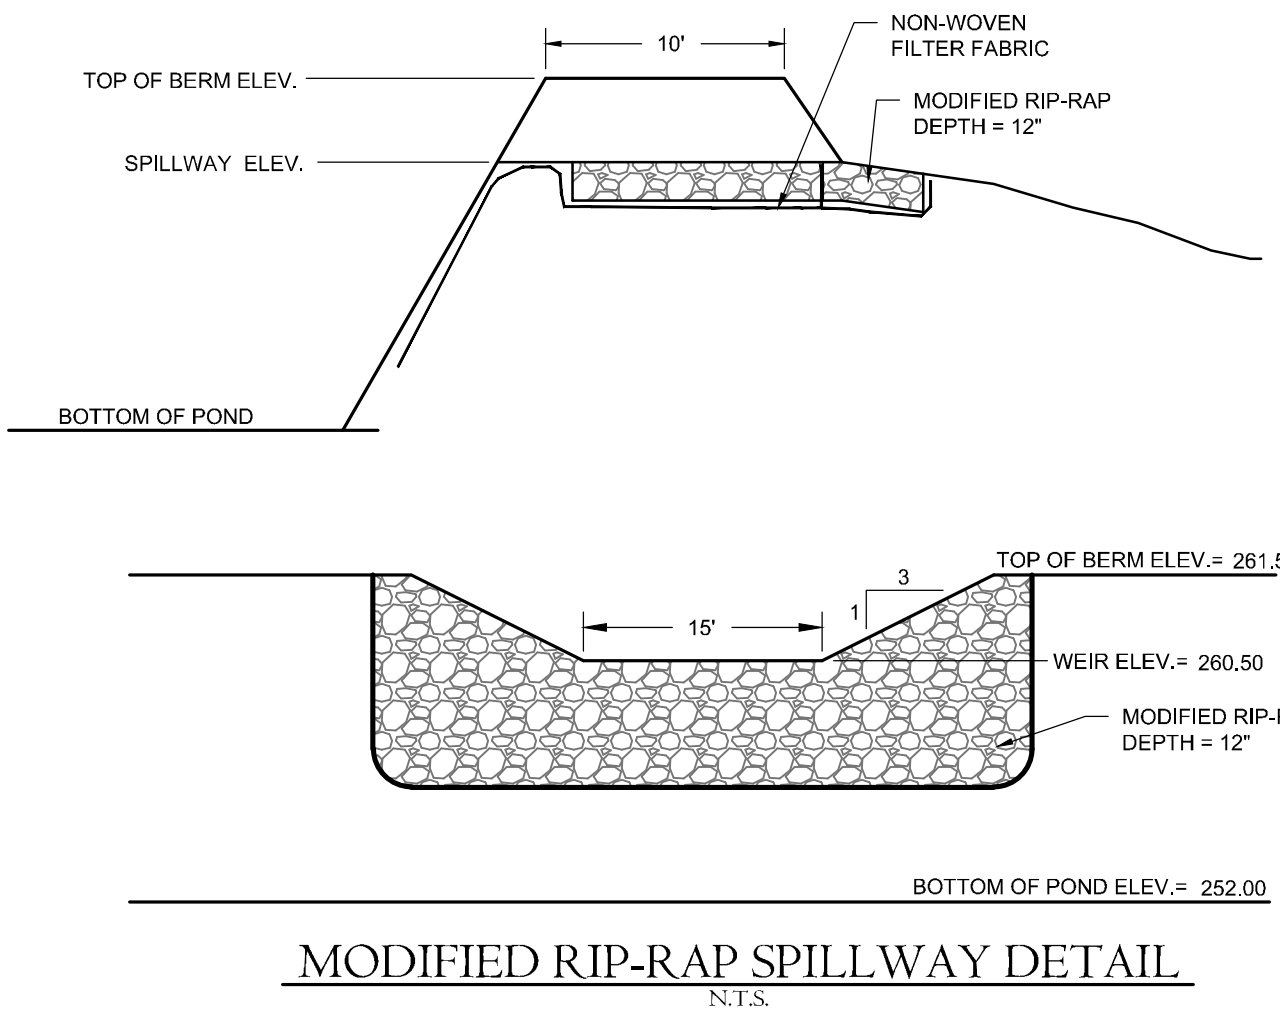
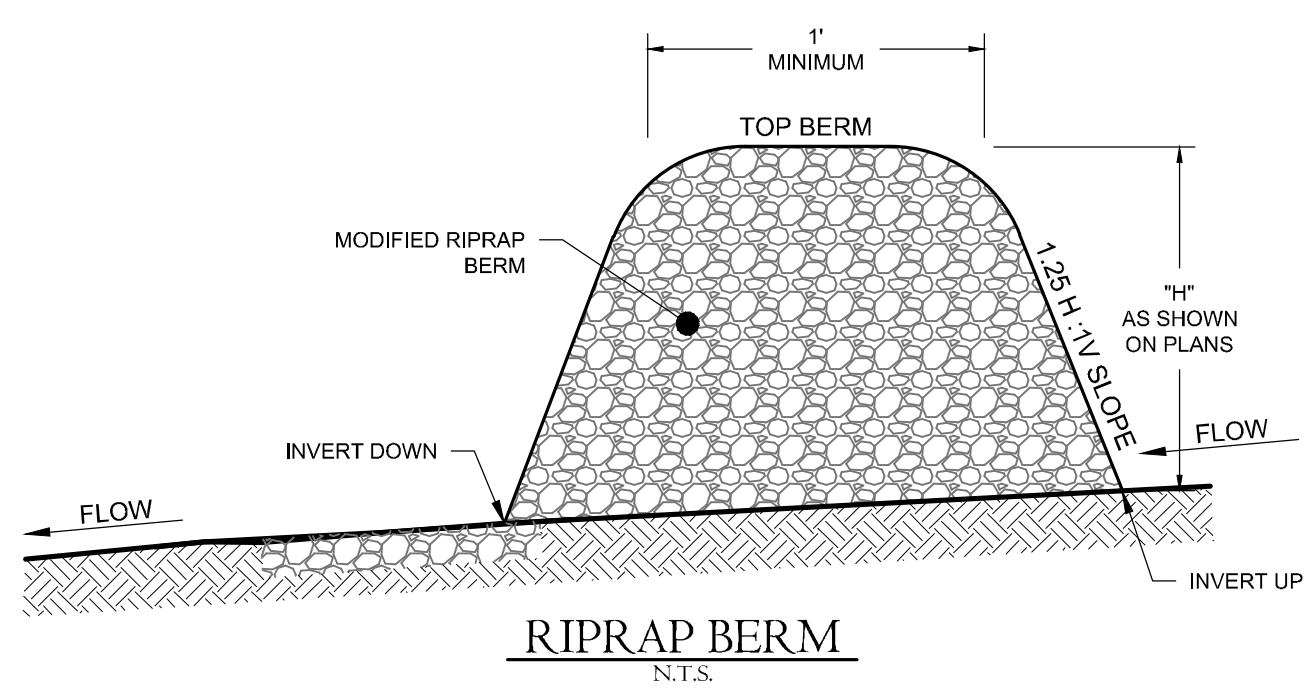


TRASH RACK OPTIONS:

- A. MANUFACTURED BY PLASTIC SOLUTIONS INC. OR EQUAL
INSTALLED PER MANUFACTURER'S RECOMMENDATIONS.
- B. 3.0 LBS/SF EXPANDED STEEL GRATE WELDED TO STEEL FRAME
LWD=3.44', SWD=0.94' WIDTH = 0.264'
1 1/2" x 1 1/2" x 1/4" STEEL ANGLE FRAME WORK
STEEL SHALL CONFORM TO ASTM A36
ALL SURFACES SHALL BE GALVANIZED AND WELDS SHALL BE COATED WITH A GALVANIZING COMPOUND AFTER WELDING.
FABRICATOR MAY MODIFY COMPONENTS TO IMPROVE CONTRACTIBILITY.

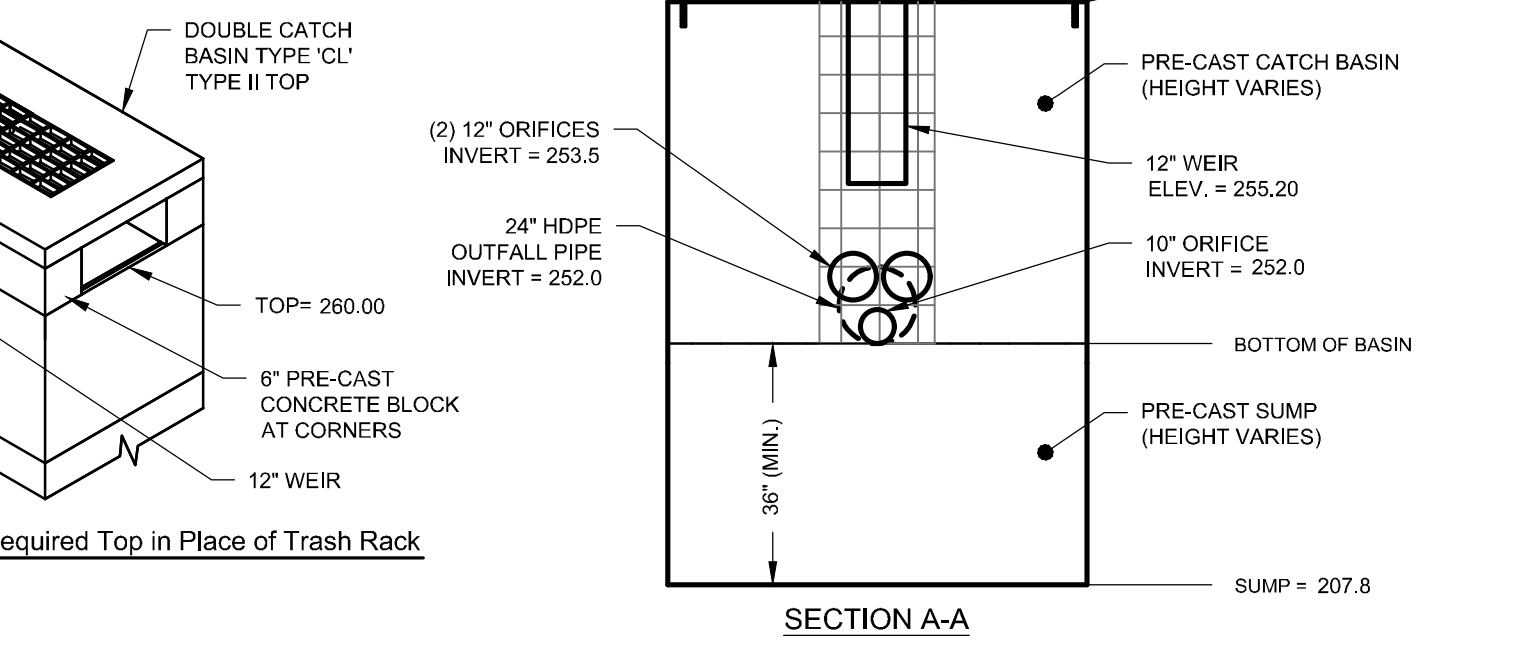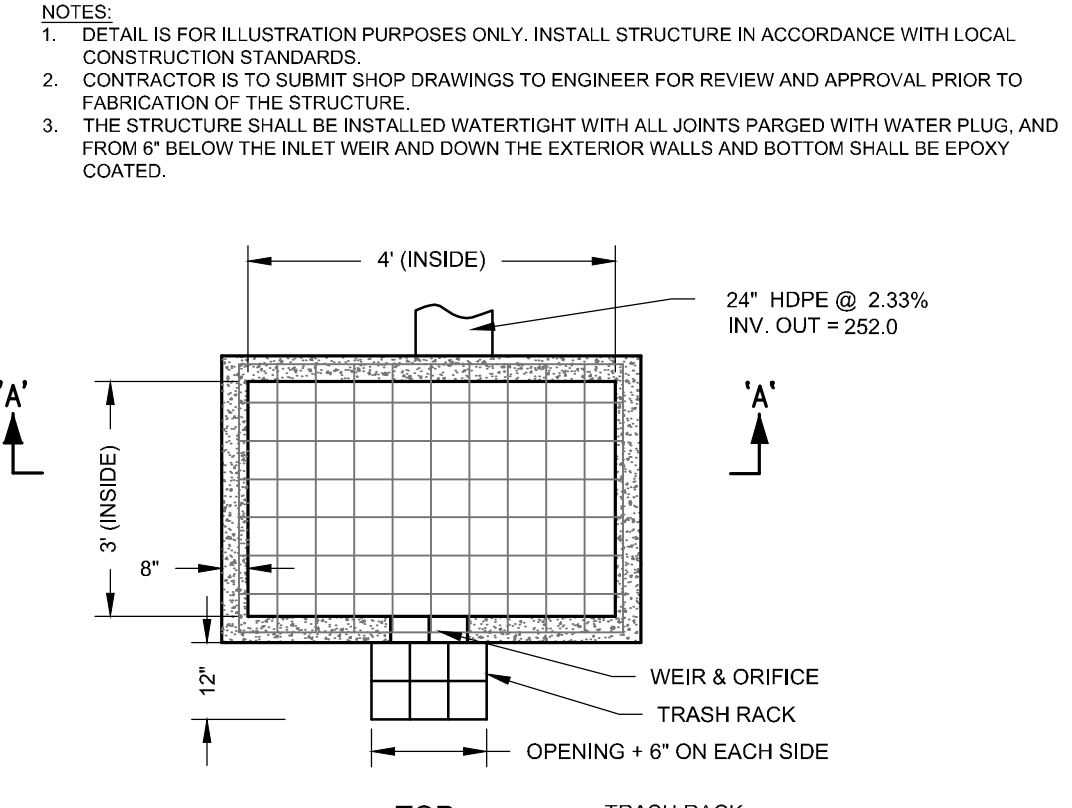

Basin Schematic

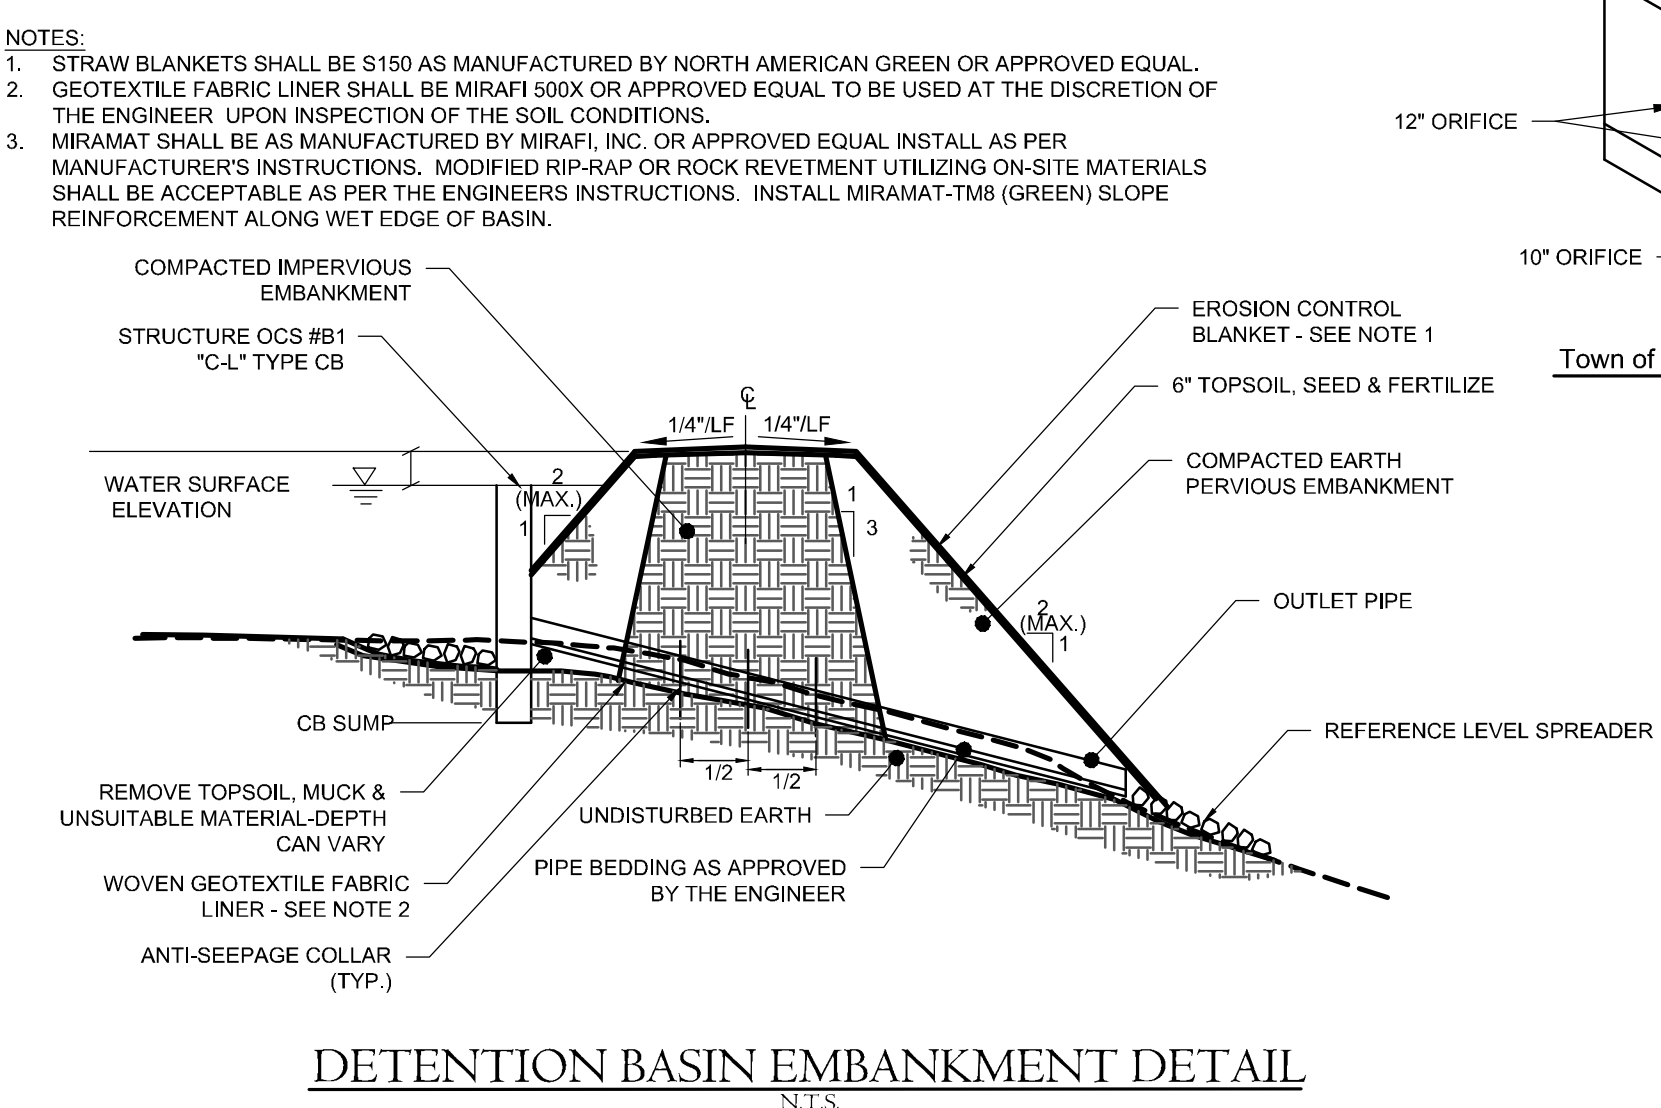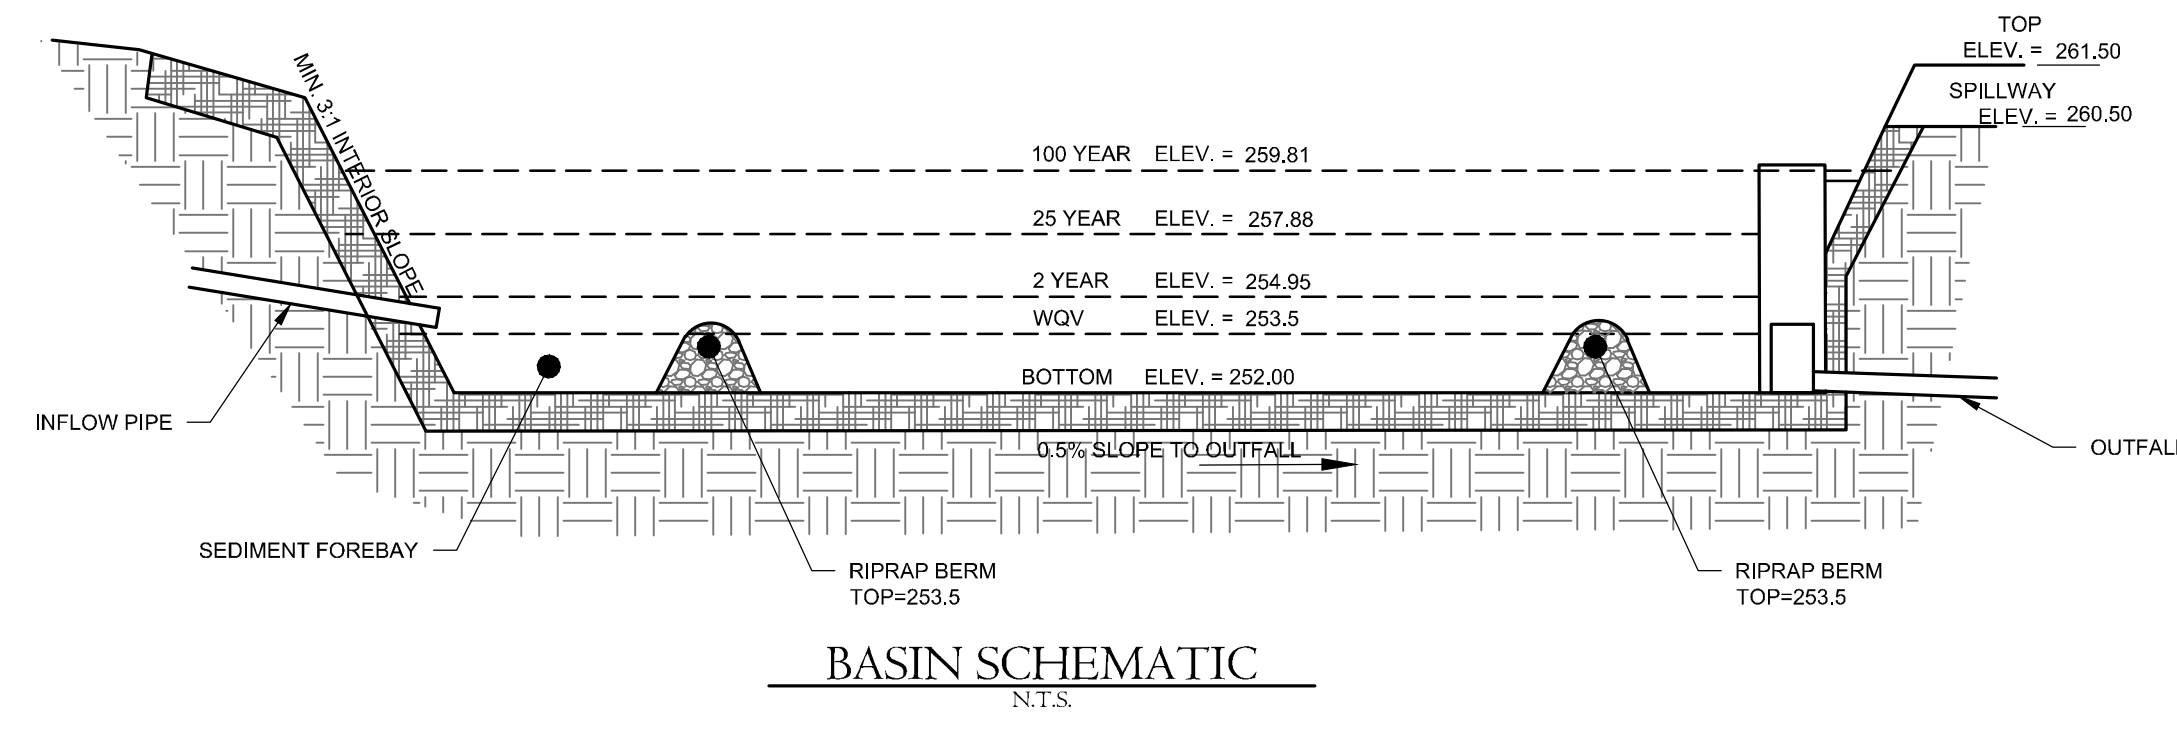


Basin Embankment Detail



#13653
Barton N. Bovee P.E. Reg. No.
NOT VALID UNLESS EMBOSSED SEAL OR STAMP IS AFFIXED HERETO

DETENTION BASIN DETAILS

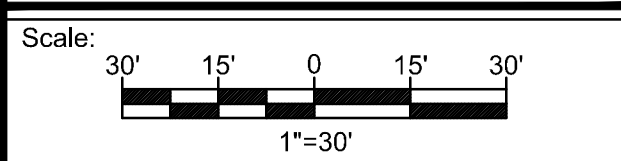

Date: September 1, 2022
Project #: 2235 F.B. #: ---
Drawn By: BTP Approved By: BNB

Date	Descriptions
Sept. 26, 2022	Revised per Town Comments
Oct. 20, 2022	Revised Detention Basin & Water
Oct. 31, 2022	Revised per Town Comments

Sheet #:
DB1